

CASHMI DETA	41
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CUSTOMER APPROVAL TO MANUFACTURE:	
Approved as Noted Approved with NO Exception Taken	$\overline{\left(\right)}$
Revise and Resubmit	
Your Title Date SEQUENCE OF OPERATION - HOOD CONTROLS	
ELECTRICAL PACKAGE: DCV SERIES Once all power, light and temperature sensor circuits are properly landed on the control	
terminal block the LCD interface will be illuminated. All temperature readings are measured by resistive temperature sensors (thermistors) installed in each hood exhaust riser. One room temperature sensor is installed in the space to measure ambient air temperature.	
Two methods to activate system:	
Manual activation: 1. Operator presses the fan button to engage the exhaust fan(s) and the exhaust fan(s) begin operation in low-CFM Prep Mode. Dedicated make-up air units (if applicable) for the based remain off in Drep Mode	
hood remain off in Prep Mode. 2. Operator turns on the cooking appliances. Once the exhaust air temperature reaches 10 degrees (F) above ambient temperature in the space, the exhaust system will ramp up to a	
preset minimum speed (low-volume cooking conditions). Makeup air fan will power on at this point (also at minimum speed). 3. As the temperature of the exhaust air increases, the exhaust and make-up air fan speeds	
increase proportionally. The fans will modulate between preset low-speed and high-speed exhaust levels, dependant upon on the exhaust air temperature (cooking load). 4. At any point, operator may engage the 100% override option on the touch screen and run	
the fans at full speed for a fixed period of time (adjustable). After this period, fan modulation based on temperature will resume.	
Automatic activation: 1. If the operator does not manually engage the exhaust system, the SC-EMS will automatically activate Prep Mode when the exhaust air temperature reaches 5 degrees above	DI FA
ambient temperature. When the air temperature at the hood collar increases to 10 degrees above ambient, the exhaust and makeup air fans will ramp up to preset low speeds for low volume conditions. 2. System will continue operating per steps 3 & 4 (above)	MA (V PA CC
	N
degrees above ambient, the fans will shut off.	CA EQ CC
	BE

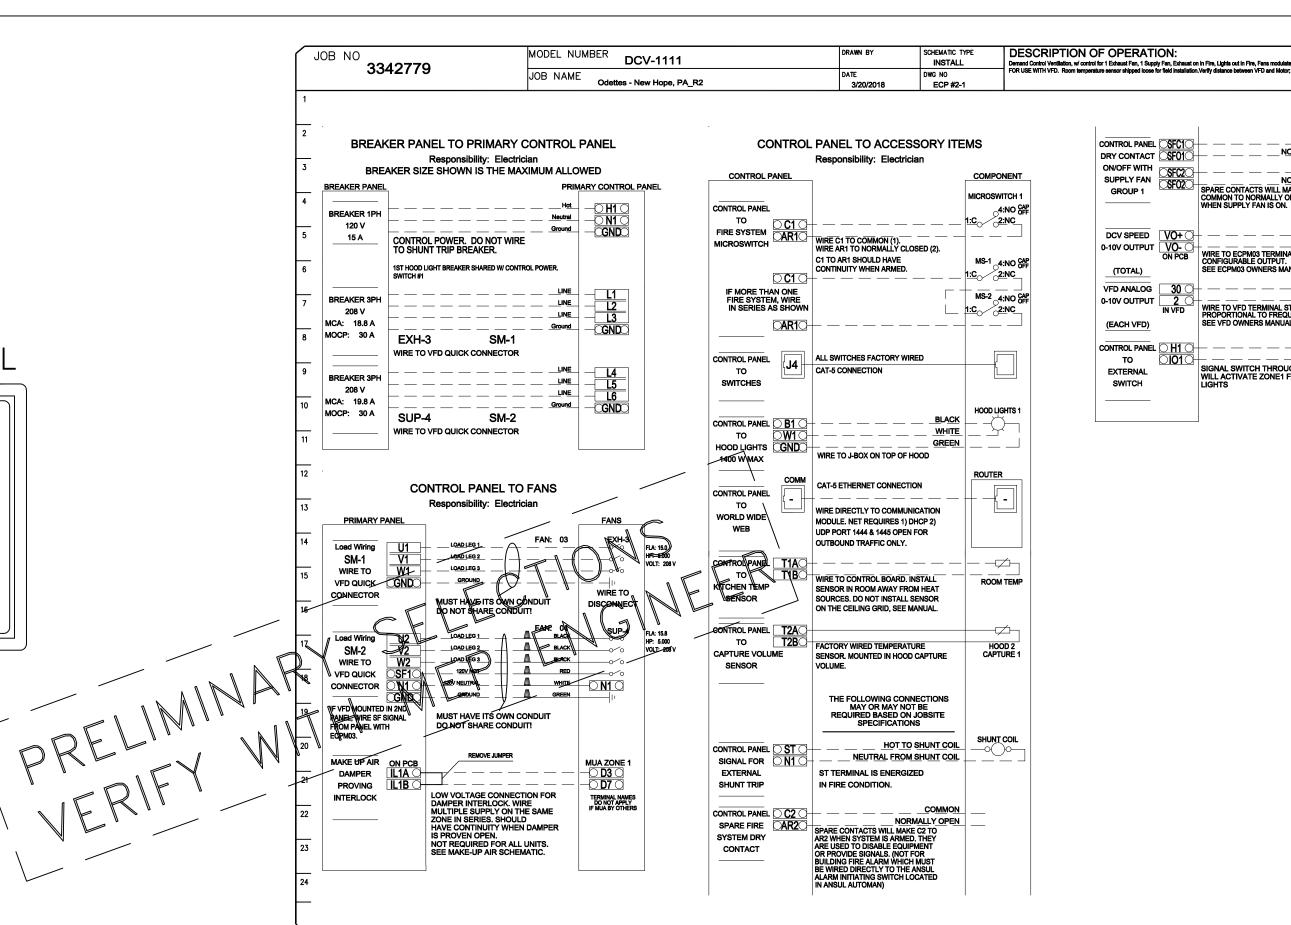

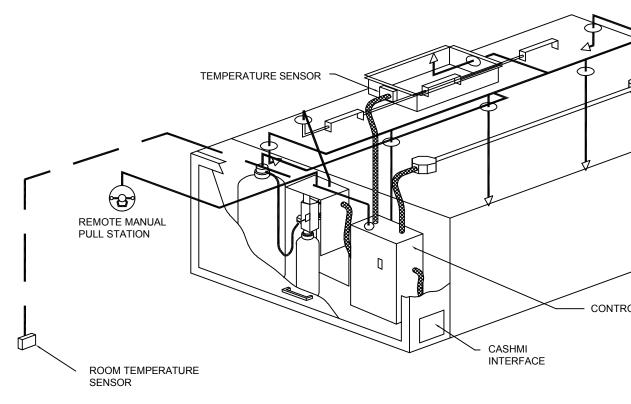

ND CONTROL VENTILATION SYSTEM NOTE

TO BE CONTROLLED BY A MODULATING ENERGY MENT SYSTEM. PRE-WIRED VARIABLE FREQUENCY DRIVES RE INCLUDED IN THE MANUFACTURER'S CONTROL . FAN MOTORS MUST BE INVERTER-DUTY AND IBLE WITH A VARIABLE AIR VOLUME APPLICATION.

TO ELECTRICAL CONTRACTOR

IRE HOOD CONTROL PACKAGE IS FURNISHED BY KITCHEN CONTRACTOR AND SHOWN ON ELECTRICAL DRAWINGS FOR ATION PURPOSES ONLY. ALL FIELD WIRING AND INTERLOCKS TO PLETED BY ELECTRICAL CONTRACTOR. CONTACT CAPTIVEAIRE WITH S REGARDING SCOPE OF WORK: (800) 988–0881

HOOD CONTROL DE

SCREMATIC TYPE INSTALL DESCRIPTION OF OPERATION: Demod Coard Welfact, women's of Islawel in Stage Yan, Islawel on The Light of In Pin, Ere module lead on duit targetaire, INVERTER DUTY 3 PMSE BOTOR RECURED DOE NO ECP #2-1 SORY ITEMS an CONTROL PANEL SFCIO COMMON NORDAULY OPEN OMOPONENT 100 COMPONENT 100 COMPONENT CONTROL PANEL SFCIO NORDAULY OPEN SED (2). CONTROL PANEL SFCIO NORDAULY OPEN OMOPONENT 100 COMPONENT CONTROL PANEL SFCIO NORDAULY OPEN SED (2). MS1 4 ANO 000 LIGO 2 ANG 2 ANG 000 LIGO 2 ANG 2 ANG 0000 LIGO 2 ANG 2 ANG 00000 LIGO 2 ANG 2 ANG 00000 LIGO 2 ANG 2 ANG 00000 LIGO 2 ANG 2 ANG 00000 LIGO 2 ANG 2 ANG 000000 LIGO 2 ANG 2 ANG 0000000 LIGO 2 ANG 2 ANG 00000000000000000000000000000000000		THE DESIGN OF DIFFERENCE Where the Difference is in the Details S425 WISCONSIN AVE STE 700 CHEVY CHASE, MD 20815 PHONE: 202-787-3317 FAX: 202-835-1037 EMAIL: slevine@thedesigndifference.com www.thedesigndifference.com
	TATAL CONTRACTOR CONTR	TTES Ope, pa
CASHMI INTERFACE	DATE: 3/20/2018 DRAWN CDP-32 SCALE: NTS MASTER DRAWING	H M M M M M
NTROL DETAILS	SHEET NO. 9	
GENERAL NOTE (TYP OF ALL SHEE) THESE DRAWINGS ARE FOR INFORMATION PURPOS The information conveyed in this set is intended to commu design intent for use in the planning and bidding processes These documents are not for use in construction or to loc or other requirements. The Kitchen Equipment Contractor	SES ONLY Inicate s only.	SHEET TITLE: KITCHEN EQUIPMENT EXHAUST HOOD CONTROLS DETAILS SCALE: NO SCALE DATE: 02/26/2019 SHEET NO:

these plans. NIKEC: Not included in the Kitchen Equipment Contract

sub-contractors are to verify all information and produce construction documents. TDD, parent company and affiliates will not be liable

for action taken as a result of the design and equipment portrayed in

REVISIONS	REVISIONS

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