NOTES: 1. REFER TO DRAWING MPE-I FOR HVAC, PLUMBING FIRE PROTECTION & ELECTRICAL GENERAL NOTES, ABBREVIATIONS, LEGENIDS & DRAWING LIST. 2. UNLESS OTHERWISE NOTED, ALL 120 VOLT, SINGLE PHASE CIRCUITS SHALL HAVE 2812, 1912 ON 34°C AS A MINIMUM, ALL 120 VOLT, 20A SINGLE PHASE CIRCUITS OVER 70 FT. IN LENGTH SHALLE 2910, 1910 M 34°C. 3. UNLESS OTHERWISE NOTED, ALL 208 VOLT, 20A SINGLE PHASE CIRCUITS OVER 110 FT. IN LENGTH SHALLE 2910, 1910 M 34°C. 4. COORDINATE WITH KITCHEN CONSULTANT ON FINAL DEVICE MOUNTING HEIGHTS. 5. UNLESS OTHERWISE NOTED AS STANDARD (S), ALL RECEPTACLES ON THE GROUND FLOOR SHALL BOUSED IN A WEATHERPROOF (PM) HUSS (III) ENCLOSURE AND HAWE GROUND FAULT CIRCUIT-INTERRUPTER PROTECTION (GF).

DRAWING NOTES:

PROVIDE NEW POLYMER CONCRETE HANDHOLE FOR PULLING NEW PECO SERVICE ENTRANCE CONDUCTORS. HANDHOLE SHALL BE SIZED TO ACCOMMODATE THE NUMBER OF CONDUCTORS AS NOTED ON THE SINGLE LINE DIAGRAM INCLUDING BENDING RADII. HANDHOLE SHALL BE MANUFACTURED BY HUBBELL/QUAZITE OR APPROVED EQUAL.

SERVICE ENTRANCE CONDUIT AND CONDUCTORS TURN FROM BELOW GRADE AT THIS LOCATION AND RISE VERTICALLY IN CONCRETE ENCASEMENT (MINIMUM 2 INCHES). CONDUITS ENTER SERVICE DISCONNECT CIRCUIT BREAKER ON 1ST FLOOR CLOSET. REFER TO SINGLE LINE DIAGRAM FOR OTHER INFORMATION.

CIRCUIT BREAKER IN 1ST FLOOR PUMP PUMP ROOM, CONDUIT TO BE ENCASED IN CONCRETE (MINIMUM 2 INCHES). REFER TO SINGLE LINE DIAGRAM FOR OTHER INFORMATION.

TELEPHONE & CABLE TV SERVICE ENTRANCE CONDUITS AND WIRE TURN UP FROM BELOW GRADE IN THIS

FIRE PUMP FEEDER DOWN FROM SERVICE ENTRANCE CIRCUIT BREAKER AND ROUTE TO THE FIRE PUMP

TELEPHONE & CABLE TV SERVICE ENTRANCE CONDUITS AND WIRE TURN UP FROM BE LOCATION.
 TWO (2) 5" FLOOR SLEEVES IN DECK ABOVE FOR TELEPHONE AND CABLE TV RISERS.

6 NOT USED.

7 FEMA FLOOD FLOAT SWITCH. COORDINATE WITH ELEVATOR VENDOR FOR REQUIREMENTS ON INTERFACING WITH ELEVATOR CONTROLLER.

PROVIDE NEMA-4 30AS/15AF DISCONNECT SWITCH MOUNTED TO THE CEILING SLAB. CONVERT FROM EMT TO LIQUID-TIGHT FLEXIBLE CONDUIT FOR FINAL TERMINATION AT THE EQUIPMENT SHOWN. CIRCUIT TO PANEL INDICATED WITH 3#12, 1#12G., 3/4"C. TYPICAL FOR ALL UNIT AND UNIT HEATERS.

9 FIREPLACE OUTLET BOX. COORDINATE WITH MANUFACTURE ON EXACT REQUIREMENTS FOR LOCATION, SIZE ETC. CONTRACTOR SHALL ALSO PROVIDE ALL WIRING AS REQUIRED AND DIRECTED BY THE FIREPLACE MANUFACTURER.

PROVIDE NEMA-4, 30AS/15AF DISCONNECT SWITCH MOUNTED TO THE CEILING SLAB AND CIRCUIT WITH 2#12, 1#12G., 3/4"C. TO THE PANEL INDICATED. CONVERT FROM EMT TO LIQUID-TIGHT FLEXIBLE CONDUIT FOR FINAL TERMINATION AT THE EQUIPMENT SHOWN.

PROVIDE FRACTIONAL HORSEPOWER RATED TOGGLE SWITCH FOR EQUIPMENT SHOWN CIRCUIT WITH 2#12, 1#12G., 3'4"C TO THE PANEL INDICATED.

1#12G., 34 C TO THE PANEL INDICATED.

12 CIRCUIT TO VENDOR SUPPLIED INTEGRAL MOTOR STARTER FOR AIR COMPRESSOR (NOT SHOWN) WITH 2#12, 1#12G. 3/4"C FROM THE PANEL INDICATED.

1#12G., 3/4"C. FROM THE PANEL INDICATED.

PROVIDE NEMA-4 30AS/25AF DISCONNECT SWITCH MOUNTED TO THE CEILING SLAB. CONVERT FROM EMT TO LIQUID-TIGHT FLEXIBLE CONDUIT FOR FINAL TERMINATION AT THE EQUIPMENT SHOWN. CIRCUIT TO PANEL

INDICATED WITH 3#10, 1#10G., 3/4"C. TYPICAL FOR ALL UNIT AND CABINET HEATERS.

CIRCUIT BREAKERS FOR RECEPTACLE CIRCUIT RP-1/24, RP-1/25 AND RP-1/29 SHALL BE ABLE TO BE SWITCHED OFF IN CASE OF FLOOD. CIRCUIT THE RECEPTACLES AS NOTED ON THE DRAWING, DO NOT CONNECT OTHER

WIRING DEVICES TO THESE CIRCUITS.

5

FIRE ALARM DEVICE SHALL BE LOCATED ABOVE REGULATORY FLOOD ELEVATION.

EQUIPMENT AND ELECTRICAL DEVICES SHALL BE LOCATED ABOVE REGULATORY FLOOD ELEVATION.

PROVIDE 120V POWER TO SUMP PUMP, PUMP IS 115V 1/3HP. WIRING SHALL BE 2#12, 1#12G, 3/4"C. MOUNT THE WEATHERPROOF RECEPTACLE ABOVE REGULATORY FLOOD ELEVATION.

WIRE AND PROGRAM HEAT DETECTOR FOR ELEVATOR SHUNT TRIP FUNCTION. HEAT DETECTORS SHALL BE LOCATED WITHIN 24 INCHES OF SPRINKLER HEAD IN THIS AREA. HEAT DETECTORS SHALL HAVE THEIR TEMPERATURE SETTING SET APPROXIMATELY 30°F LOWER THAN THE ACTIVATION TEMPERATURE OF THE SPRINKLER HEAD THEY ARE MOUNTED NEAR. HEAT DETECTORS SHALL ALSO HAVE A HIGHER SENSITIVITY RATING THAN THE SPRINKLER HEAD IT IS MOUNTED NEAR.

(19) PROVIDE 120V POWER TO TRAP PRIMER. COORDINATE LOCATION WITH PLUMBING CONTRACTOR.

CONDUIT FOR FIRE PUMP FEEDER ENCASED IN 2" CONCRETE (MIN.) DOWN FROM 1ST FLOOR

CONDUIT FOR FIRE PUMP FEEDER ENCASED IN 2" CONCRETE (MIN.) STUFF UP TO FIRE PUMP CIRCUIT BREAKER ON 2ND FLOOR FIRE PUMP ROOM.

PROVIDE HARD WIRE CONNECTION TO SUMP PUMP. PROVIDE NEMA 4 J-BOX MOUNTED ABOVE REGULATORY FLOOD ELEVATION.

POWER FOR PROPOSED PUMP STATION (FOR BUCKS COUNTY WATER AND SEWER AUTHORITY)

THE FOLLOWING ARE PRELIMINARY CIRCUIT INFORMATION FOR THE PROPOSED PUMP STATION (DETAILS TO BE DETERMINED)

1. 460V, 100A 3-PHASE POWER FOR GRINDER PUMPS TO BE FED FROM

INSTALLED BY OTHERS.

120V, 20A 1-PHASE POWER FOR A SCADA PANEL LOCATED AT THE PROPSOED PUMP STATION. CIRCUIT FED FROM PANEL RP-1 CKT #30.

CONDUITS AND WIRING TO BE FURNISHED AND INSTALLED BY OTHERS.

EC TO PROVIDE A 120VAC/1P CIRCUIT TO POWER SMOKE DAMPERS WITHIN


DRAWINGS FOR LOCATION OF DAMPERS. CIRCUIT TO NEAREST RECEPTACLE PANEL WITH 2#12, 1#12G., 3/4"C. UTILIZE 20A/1P BREAKER WITHIN PANEL FOR

EC TO PROVIDE FIRE ALARM CONTROL/RELAY MODULE AT EACH DAMPER. THINTENT IS TO HAVE THE DAMPERS INITIATED BY THE FIRE ALARM CONTROL

PANEL UPON DETECTION OF SMOKE WITHIN THE DUCT DETECTORS FOR THE AIR HANDLING EQUIPMENT SERVING THIS FACILITY. COORDINATE WITH FIRE


ALARM VENDOR FOR INTERFACE OF EQUIPMENT.

PANEL MDP. 100/3 C.B., CONDUITS AND WIRING TO BE FURNISHED AND

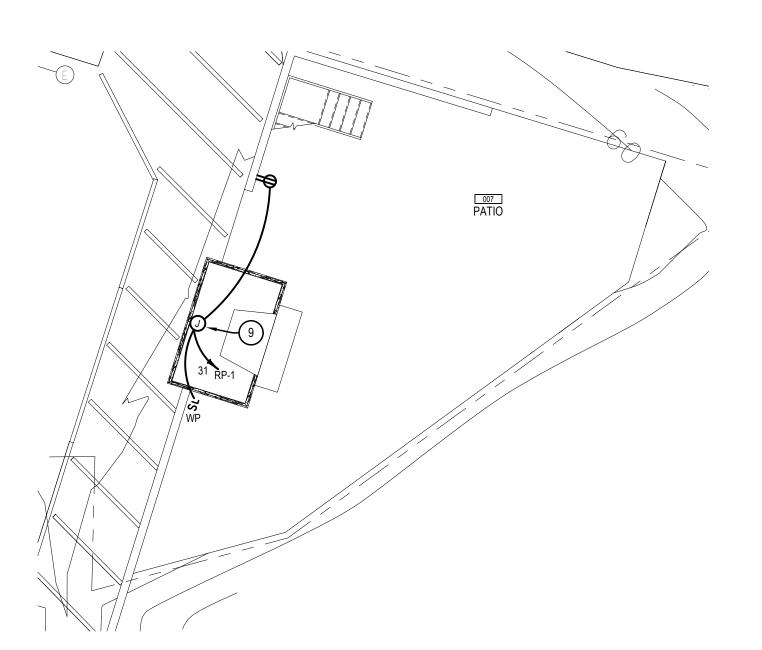

PARTIAL GRADE LEVEL PLAN
POWER & SYSTEMS WORK

SCALE : 1/8" = 1'-0"

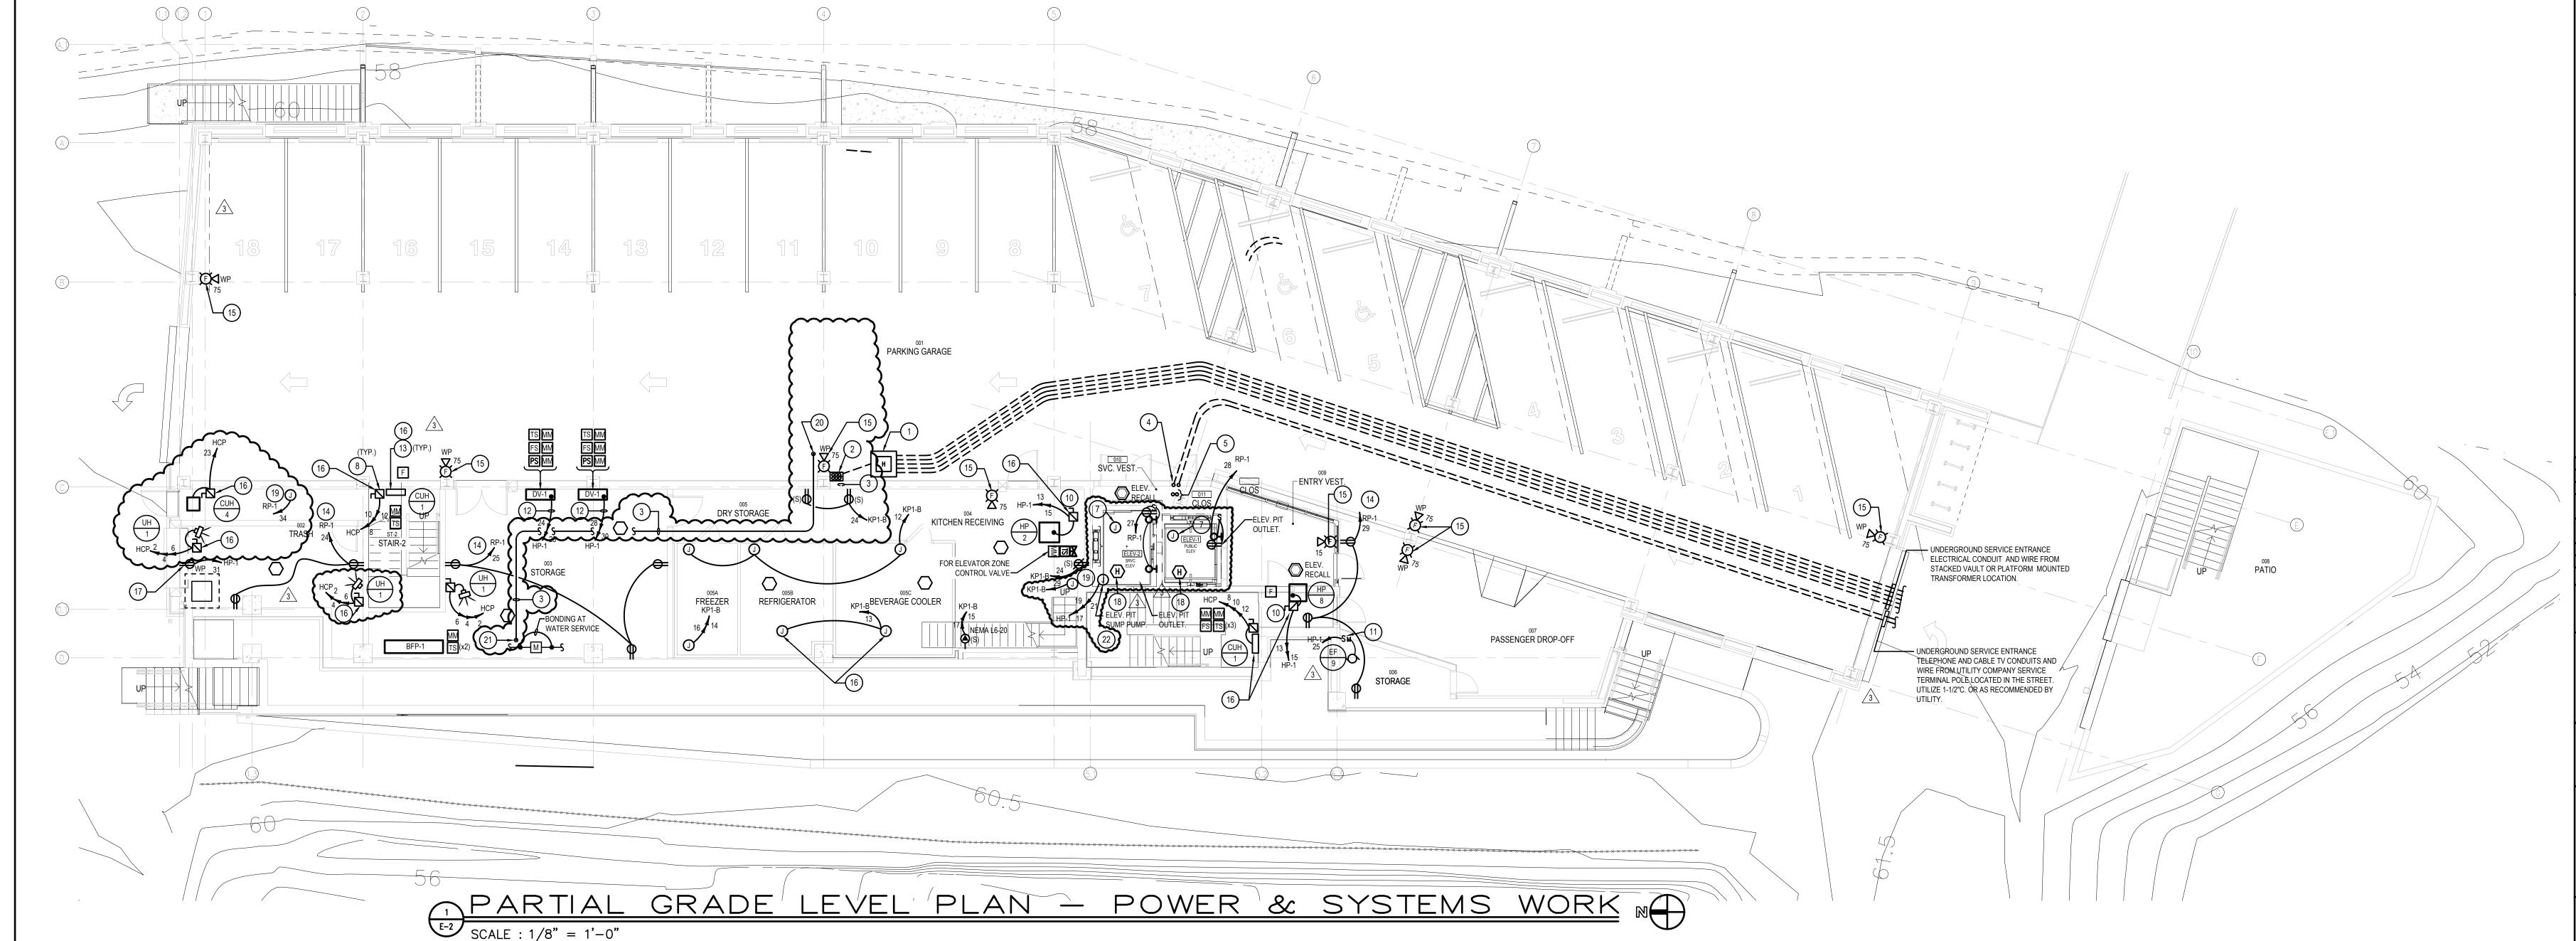

RIVERHOUSE AT Odette's

274 SOUTH RIVER ROAD NEW HOPE, PA 18938

OWNER/ OPERATOR:
GATEWAY TO NEW HOPE, LLC
274 South River Road
New Hope, PA 18938

ARCHITECT:
STOKES ARCHITECTURE
2103 Sansom Street
Philadelphia, PA 19103
tel: (215) 523-9190

INTERIOR DESIGNER
BALONGUE DESIGN INC
707 Matsonford Road
Villanova, PA 19085
tel: (610) 525-7593
fax: (610) 525-7594

CIVIL ENGINEER:

VAN CLEEF ENGINEERING

ASSOCIATES, LLC
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Doylestown, PA 18901
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STRUCTURAL ENGINEER:

O'DONNELL & NACCARATO 111 S. Independence Mall East Suite 950 Philadelphia, PA 19106 tel: (215) 925-3788

MEP ENGINEER:
WICK FISHER WHITE
111 S. Independence Mall East Suite 400
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fax: (215) 627-8240

BRIAN ORTER LIGHTING DESIGN LLC 227 W. 29th St 8th Floor New York, NY 10001 tel: (646) 502-7568

STOKES

ARCHITECTURE + DESIG

ALL DIMENSIONS AND RELATIONSHIPS MUST BE VERIFIED BY CONTRACTOR. THE ARCHITECT IS TO BE NOTIFIED OF ANY DISCREPANCIES BEFORE PROCEEDING WITH THE CONSTRUCTION.

PROJECT #: 140145.00
FILENAME:
DRAWN: WFV
CHECKED: WFV
DATE: 07/25/1

ISSUE FOR CONSTRUCTION 02-28-2019

GRADE LEVEL
PLAN-POWER &
SYSTEMS

AWING

E-2