

## FIRE EXTINGUISHER LEGEND (ARROW INDICATES PLACEMENT ON WALL; BOX INDICATES CABINET)

MECHANICAL

ROOM SIGN

LARSEN'S EXTINGUISHER ON WALL BRACKET DESCRIPTION: FIRE EXTINGUISHER: MP10

BRACKET: 546 STANDARD BRACKET MOUNTING HEIGHT: T.O. EXTINGUISHER @ 54" A.F.F.

1/8" THICK COLORED ACRYLIC

W/ COLORED MATTE FINISH &

POLISHED/FINISHED EDGES

3/4" CUT VINYL APPLIED

RAISED BRAILLE

BY SIGN SUPPLIER

LETTERS - COLOR: WHITE

CHARACTERS PROVIDED

1/8" THICK COLORED ACRYLIC W/ COLORED MATTE FINISH &

POLISHED/FINISHED EDGES

5/8" CUT VINYL APPLIED

LETTERS - COLOR: WHITE

1-1/4" CUT VINYL APPLIED

LETTERS - COLOR: WHITE;

MAXIMUM OCCUPANCY

TOTAL

SEE ROOM SCHEDULE FOR

1/8" THICK COLORED ACRYLIC

W/ COLORED MATTE FINISH &

POLISHED/FINISHED EDGES

— 3/4" CUT VINYL APPLIED

RAISED BRAILLE

BY SIGN SUPPLIER

LETTERS - COLOR: WHITE

CHARACTERS PROVIDED

1/8" THICK COLORED ACRYLIC

W/ COLORED MATTE FINISH &

POLISHED/FINISHED EDGES

3/4" CUT VINYL APPLIED

RAISED BRAILLE

BY SIGN SUPPLIER

LETTERS - COLOR: WHITE

CHARACTERS PROVIDED

RESTROOM

RESTROOM

SIGN (HC)

MAXIMUM

ROOM\_ OCCUPANCY

OCCUPANO

Y SIGN

EXÍT

## **BUILDING CODES**

**BUILDING CODE** 2009 IBC MECHANICAL CODE 2009 IMC FUEL GAS CODE 2009 IFGC ACCESSIBILITY CODE 2009 ICC/ANSI A117.1 **ENERGY CODE** 2009 IECC

## CODE DATA

PRIMARY USE GROUPS (CHAP. #3) A-3, ASSEMBLY B, BUSINESS M, MERCANTILE

ACCESSORY USE GROUPS S-1 & S-2, STORAGE CONSTRUCTION TYPE 5B

TOTAL AREA (FOOTPRINT) 9016 S.F. SPRINKLED BUILDING **EXISTING** 

FIRE ALARMS YES, SEE MEP SHEETS **EMERGENCY LIGHTING** YES, SEE MEP SHEETS

## ALLOWABLE BUILDING HEIGHT + AREA **EXISTING BUILDING**

## BUILDING AREA MODIFICATIONS (506) **EXISTING BUILDING**

## FLOOR AREA PER OCCUPANT (1004)

A-3, ASSEMBLY AREA, POOL DECK: 1 OCCUPANT PER 15 NET S.F.

A-3, ASSEMBLY AREA, POOL & LOCKER: 1 OCCUPANT PER 50 GROSS S.F.

M, MERCANTILE AREA: 1 OCCUPANT PER 30 GROSS S.F.

B, BUSINESS AREA: 1 OCCUPANT PER 100 GROSS S.F.

S-1, STORAGE AREA: 1 OCCUPANT PER 300 GROSS S.F.

S-2, MECH AREA: 1 OCCUPANT PER 300 GROSS S.F.

## PLUMBING FIXTURES (2902.1)

A-3, B, M, S-1, S-2 SPACES REQUIRE THE FOLLOWING (BASED ON "B" THE MOST RESTRICTIVE OCCUPANCY OF THE GROUP:

> TOTAL WATER CLOSETS (2 MEN/4 WOMEN) 2 TOTAL LAVATORIES (1 MEN/1 WOMEN) 1 DRINKING FOUNTAINS 1 SERVICE SINK

## PROVIDED:

A-3, B, S-2 SPACES HAVE BE PROVIDED WITH:

TOTAL WATER CLOSETS (7 UNISEX) 3 TOTAL LAVATORIES (3 UNISEX) 1 DRINKING FOUNTAINS 1 SERVICE SINK

## **MEANS OF EGRESS**

**EXISTING** 

## FIRE PROTECTION SYSTEM

**EXISTING** 

## CODE SYMBOLS LEGEND

**ROOM SQUARE FOOTAGE ROOM NUMBER** CODE USE GROUP

---- TRAVEL DISTANCE

TACTILE EXIT SIGN PER ANSI A117.1, SECTION 703. MOUNT ON WALL ADJACENT TO DOOR AS REQUIRED PER ANSI SECTION 703. SEE DETAIL(S) ON G-SERIES SHEET(S)

TACTILE MEN OR WOMEN SIGN WITH CORRESPONDING FIGURE SYMBOLS PER ANSI A117.1 SECTION 703. MOUNT ON WALL ADJACENT TO DOOR AS REQUIRED PER ANSI SECTION 703. SEE DETAIL(S) ON G-SERIES SHEET(S)

TACTILE MAXIMUM BUILDING OCCUPANCY SIGN PER ANSI A117.1 SECTION 703. MOUNT ON WALL ADJACENT TO DOOR AS REQUIRED PER ANSI SECTION 703. SEE DETAIL(S) ON G-SERIES

OS2 TACTILE MAXIMUM ROOM OCCUPANCY SIGN PER ANSI A117.1 SECTION 703. MOUNT ON WALL ADJACENT TO DOOR AS REQUIRED PER ANSI SECTION 703. SEE DETAIL(S) ON G-SERIES SHEET(S)

PROVIDE BUILDING ADDRESS ON BUILDING PER CITY REQUIREMENTS. FONT/SIZE OF LETTERS PER CITY/FIRE DEPARTMENT REQUIREMENTS. VERIFY LOCATION WITH ARCHITECT & JURISDICTION AUTHORITY PRIOR TO PLACEMENT IN



A-12385

**OWNER** 

3029 FITCHRONA ROAD

FITCHBURG, WI 53719

PROJECT TEAM

STRUCTURAL ENGINEER

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3855 S JEFFERSON AVE SPRINGFIELD, MO 65807

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**DIVENTURES SCUBA & SWIM CENTERS** 



**PROFESSIONAL SEAL** 

BRENT M. STEVENS, AIA NCARB

PROFESSIONAL TITLE: ARCHITECT

1 ADD-01 12/20/2017	NC	D. DESCRIPTION	DATE
	1	ADD-01	12/20/2017

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### PROJECT TITLE **RENOVATION TO DIVENTURES -FITCHBURG**


PROJECT ADDRESS: 3029 FITCHRONA ROAD FITCHBURG, WISCONSIN 53719

## **CODE REVIEW**

PROJECT NO.: 17-033 DRAWN BY: Author REVIEWED BY: Checker DATE: 12.08.2017

**CODE REVIEW** 

scale: 1/8" = 1'-0"

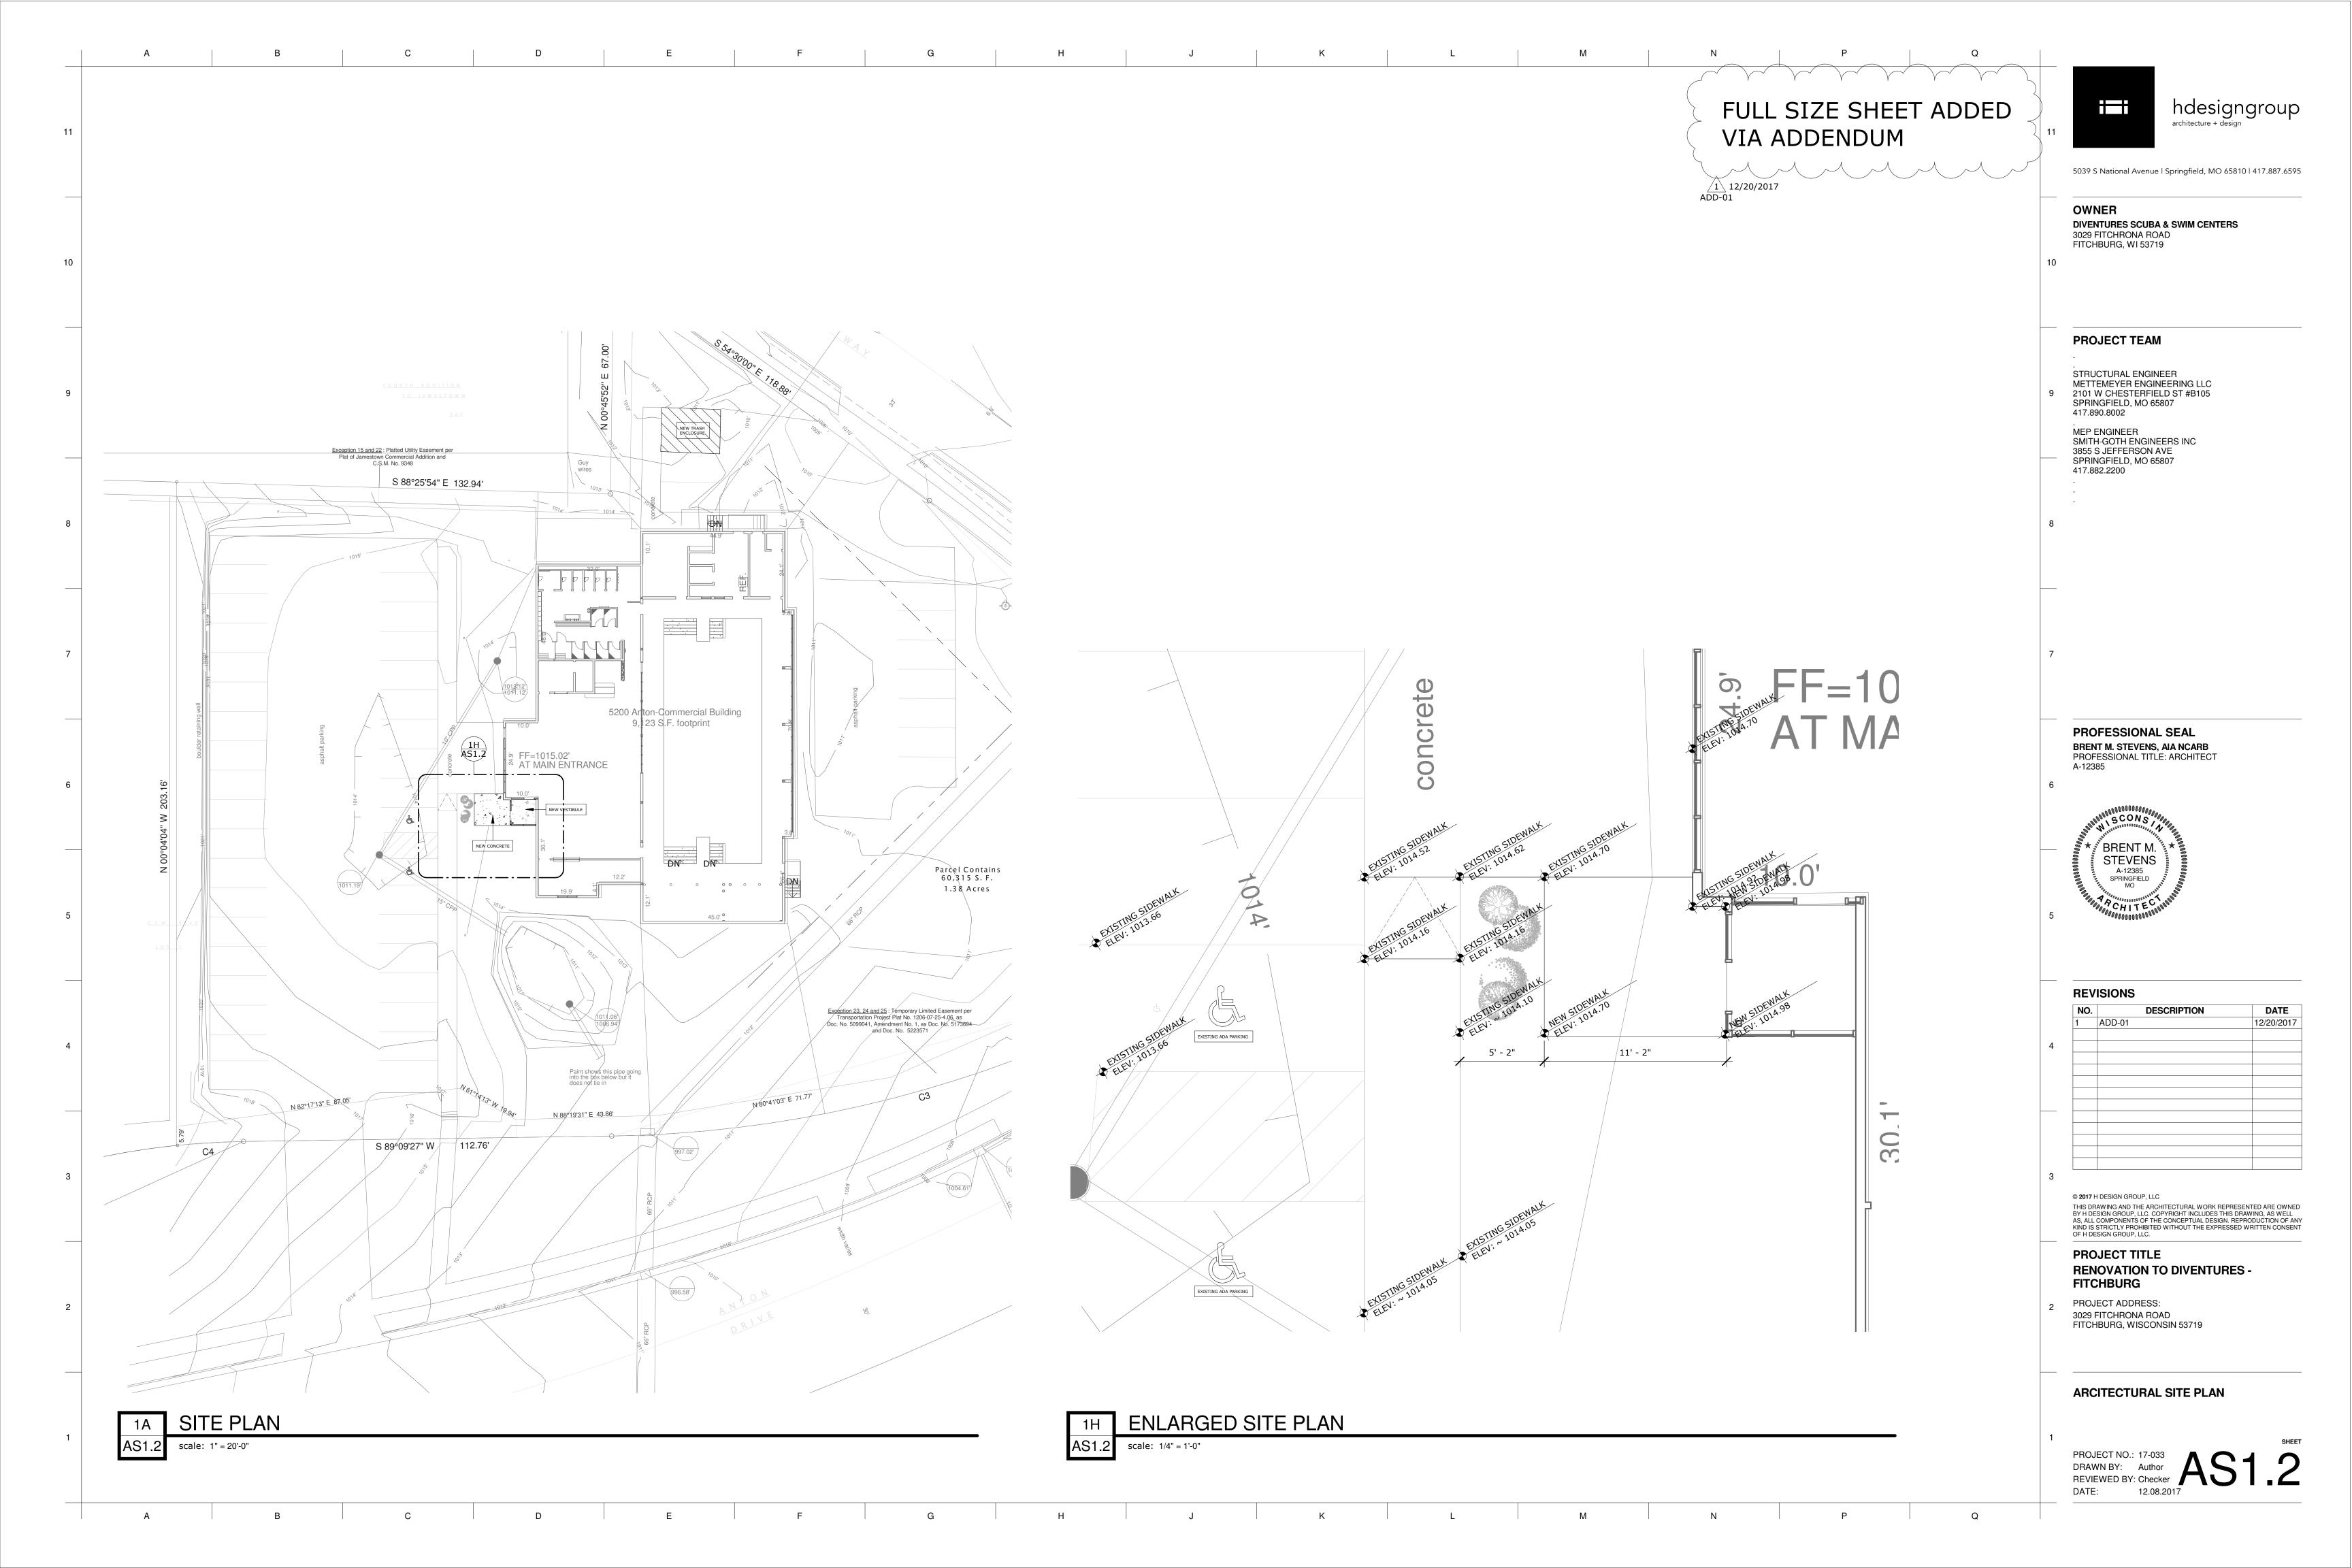

(A6) (A3) (A5) 1 12/20/2017 ADD-01 DN

	DEMOLITION KEYNOTES	
Character	Note Text	
A1	REMOVE EXISTING FRAME AND DOOR. SEE STRUCTURAL FOR REMOVAL OR ADDITION OF ANY LOAD BEARING MEMBERS.	
A2	REMOVE EXISTING WALLS. PATCH REMAINING EXISTING INTERIOR WALLS WITH GYPSUM BOARD AS REQUIRED. SEE STRUCTURAL INFORMATION ON REMOVAL OF LOAD BEARING WALLS AND ADDITION OF SUPPORT HEADER.	
A3	CUT AND REMOVE EXISTING SLAB IN THIS AREA - REMOVE, REPAIR AND/OR INSTALL PLUMBING LINES AND ELECTRICAL CONDUIT (EMT) AND OTHER PIPING AS NECESSARY, ACCORDING TO MEP DRAWINGS, RECOMPACT DISTURBED SOIL, TERMITE TREAT, ADD 15 MIL VAPOR BARRIER AND POUR NEW SLAB. NEW SLAB TO BE MIN. 4" THICK W/ 6X6X10 W.W.F. MATCH EXISTING SLAB DEPTH IF DEEPER.	
A4	REMOVE EXISTING CABINETRY, COUNTERTOP, APPLIANCES, SINKS, PLUMBING AND ELECTRICAL FIXTURES. PLUMBING AND ELECTRICAL CONNECTIONS EXPOSED BY DEMOLITION TO BE CAPPED OR REROUTED AS NECESSARY, REFER TO MEP DRAWINGS. CONSULT OWNER FOR SALVAGE INFORMATION.	
A5	DOWEL & EPOXY ANCHOR #3 REBAR X 2'-0" LONG @ 24" O.C. W/ MIN. 8" EMBED INTO EXISTING CONCRETE SLAB (MID DEPTH). ANCHOR W/ HILTI HY 150 DOWELLING SYSTEM, OR EQUAL, TYP. AT ALL TRENCHED LOCATIONS.	
A6	REMOVE EXISTING WALL FINISH DOWN TO WALL FRAMING. CONSULT INTERIOR FINISH PLAN FOR NEW FINISHES.	
A7	REMOVE EXISTING LIGHTING & SAVE PER OWNER REQUIREMENTS	
A8	REMOVE EXISTING STOREFRONT. PATCH & REPAIR ADJACENT WALLS, FLOOR AND ENTIRE PERIMETER OF REMOVED STOREFRONT. REPLACE OPENING WITH SIMILAR CONSTRUCTION INCLUDING, BUT NOT LIMITED TO WALL FRAMING, EXTERIOR SHEATHING, INSULATION, WEATHER BARRIER, INTERIOR GYPSUM BOARD, AND EXTERIOR FINISH. WEATHER BARRIER IS TO BE APPLIED TO PROVIDE POSITIVE DRAINAGE IN THE EVENT OF INFILTRATION. USE ZIP SYSTEM TAPE OR SIMILAR PRODUCT AT ALL NEW WEATHER BARRIER JOINTS.	
A9	REMOVE EXISTING SUSPENDED TILE CEILING, GYPSUM CEILING AND SOFFITS, CONSULT OWNER FOR SALVAGE INFORMATION.	
A10	REMOVE EXISTING FLOORING THROUGHOUT - PATCH SLAB AS REQUIRED TO COVER SLAB CRACKS TYP. PREP FLOOR AS REQUIRED FOR FLOORING SHOWN IN ARCHITECTURAL SHEETS.	
A11	REMOVE EXISTING DIFFUSERS AND/OR DUCTWORK AND REUSE IF	

## **DEMOLITION NOTES:**

POSSIBLE PER MECHANICAL PLANS.

1. TYPICAL SLABS ON GRADE SHALL BE 4" THICK NORMAL WEIGHT CONCRETE, REINFORCED WITH 6x6-W1.4xW1.4 WELDED WIRE FABRIC (WWF) OVER 15 MIL VAPOR BARRIER OVER A MINIMUM OF 4" FREE-DRAINING GRANULAR BASE, COMPACTED WITH THREE PASSES OF A VIBRATORY DRUM BEFORE PLACEMENT OF SLAB. MAINTAIN WWF 1"-2" BELOW TOP SURFACE OF SLABS ON GRADE. PROVIDE BOLSTERS, CHAIRS OR OTHER MEANS APPROVED IN WRITING BY THE ENGINEER TO PROPERLY LOCATE REINFORCING. GRANULAR BASE SHALL BE #57 STONE OR APPROVED EQUAL. REFER TO ASTM D448 FOR GRADATION. THICKEN SLAB EDGES 8" AND PROVIDE A #4 BAR CONTINUOUS AROUND THE PERIMETER. DOWEL SLAB EDGES TO FOUNDATION WALLS WITH #4 DOWELS 30" LONG AT 18" O.C. DRILL & EPOXY 4" MINIMUM INTO THE STEM WALL.

CONCRETE FOR INTERIOR SLABS ON GRADE SHALL HAVE 28-DAY COMPRESSIVE STRENGTH OF 3000 PSI. THE MAXIMUM WATER TO CEMENT RATIO SHALL BE 0.52 2. BY WEIGHT WITH A SLUMP OF 4"±1". IF ADDITIONAL FLOWABILITY IS REQUIRED FOR PLACEMENT OF ANY CONCRETE MIX, A WATER-REDUCING ADDITIVE CONFORMING TO ASTM C494, TYPE A, D, E OR F SHALL BE USED. NO ADDITIONAL WATER MAY BE ADDED TO THE MIX AT THE SITE. SLUMP FOR CONCRETE CONTAINING WATER-REDUCING OR HIGH-RANGE WATER-REDUCING ADMIXTURE SHALL NOT EXCEED 8" AFTER ADMIXTURE IS ADDED TO CONCRETE WITH A 2"-4" SLUMP. INTERIOR SLABS SHALL HAVE SMOOTH TROWELLED FINISH AND EXTERIOR SLABS SHALL HAVE LIGHT BROOM FINISH, UNO. ALL SLABS SHALL HAVE A CURING COMPOUND COMPLYING WITH ASTM C309 APPLIED TO SURFACE. EXCEPTIONS ARE WHERE FLOOR FINISHES REQUIRE SCRATCH FINISH AND WHERE CURING COMPOUNDS ARE NOT COMPATIBLE WITH ADHESIVES, ETC. CONTRACTOR SHALL COORDINATE ALL CONCRETE SEALERS, CURING COMPOUNDS, ETC TO ENSURE COMPATIBILITY WITH FLOORING ADHESIVES FOR FLOORING INDICATED IN THE FLOOR PLANS AND FLOOR FINISH PLANS AS APPLICABLE.

PROVIDE CONSTRUCTION JOINTS IN SLABS ON GRADE AS REQUIRED TO MAINTAIN THE QUALITY AND INTEGRITY OF THE FINISHED PRODUCT. PROVIDE CONTROL JOINTS IN SLABS ON GRADE AT APPROXIMATELY 12'-6" ON CENTER IN

3. EACH DIRECTION. JOINTS SHALL FORM NEARLY SQUARE SHAPES. CONTRACTOR SHALL COORDINATE JOINT LOCATIONS WITH TILE LAYOUT AS SHOWN IN THE FLOOR PLANS AND FLOOR FINISH PLANS AS APPLICABLE. SAWN CONTROL JOINTS SHALL BE PLACED AS SOON AS CONCRETE IS ABLE TO BE SAWN WITHOUT PULLING OUT AGGREGATE FROM FLOOR. SLABS SHALL NOT BE LEFT OVERNIGHT, OR ANY REASONABLE AMOUNT OF TIME, WITHOUT SAWING JOINTS. WEATHER IS CRITICAL TO SCHEDULE OF SAWN JOINTS. IF LARGE AREAS OF SLAB ARE POURED AT ONE TIME, SEVERAL SAWS MAY BE REQUIRED TO PROVIDE JOINTS IN TIME TO PREVENT SHRINKAGE CRACKING. PROPER JOINTING OF SLAB IS CRITICAL. REFER TO ACI MANUAL OF CONCRETE PRACTICE FOR PROPER JOINTING TECHNIQUES.



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PROFESSIONAL SEAL BRENT M. STEVENS, AIA NCARB PROFESSIONAL TITLE: ARCHITECT A-12385



	NO.	DESCRIPTION	DATE
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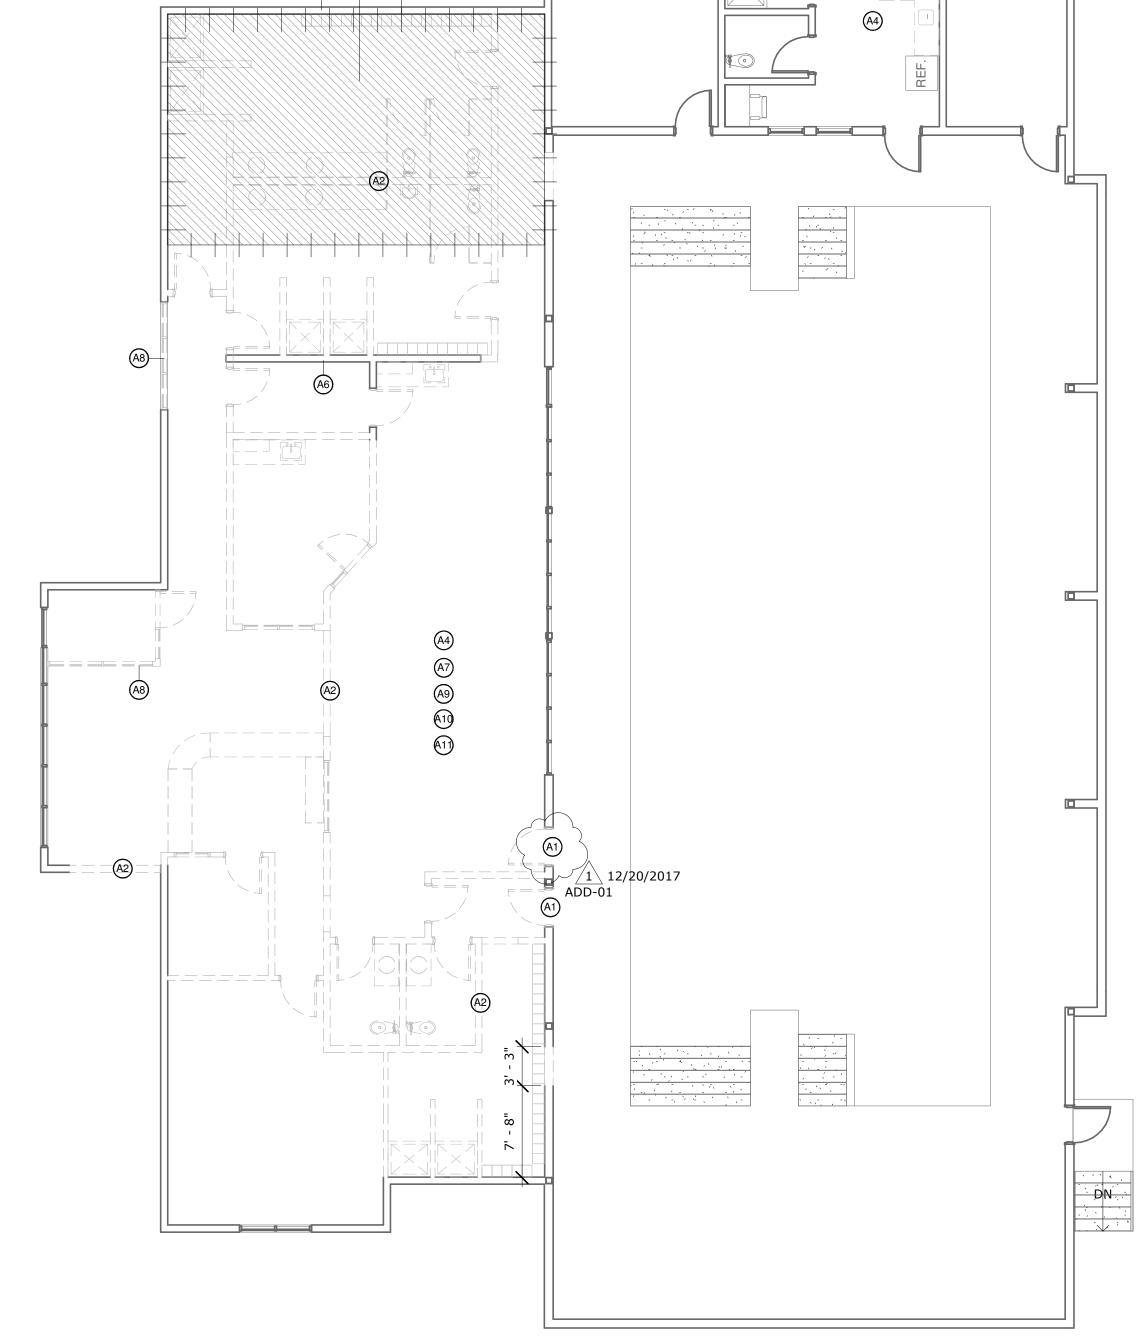
#### **PROJECT TITLE RENOVATION TO DIVENTURES -FITCHBURG**

PROJECT ADDRESS: 3029 FITCHRONA ROAD FITCHBURG, WISCONSIN 53719

## **DEMO FLOOR PLAN**


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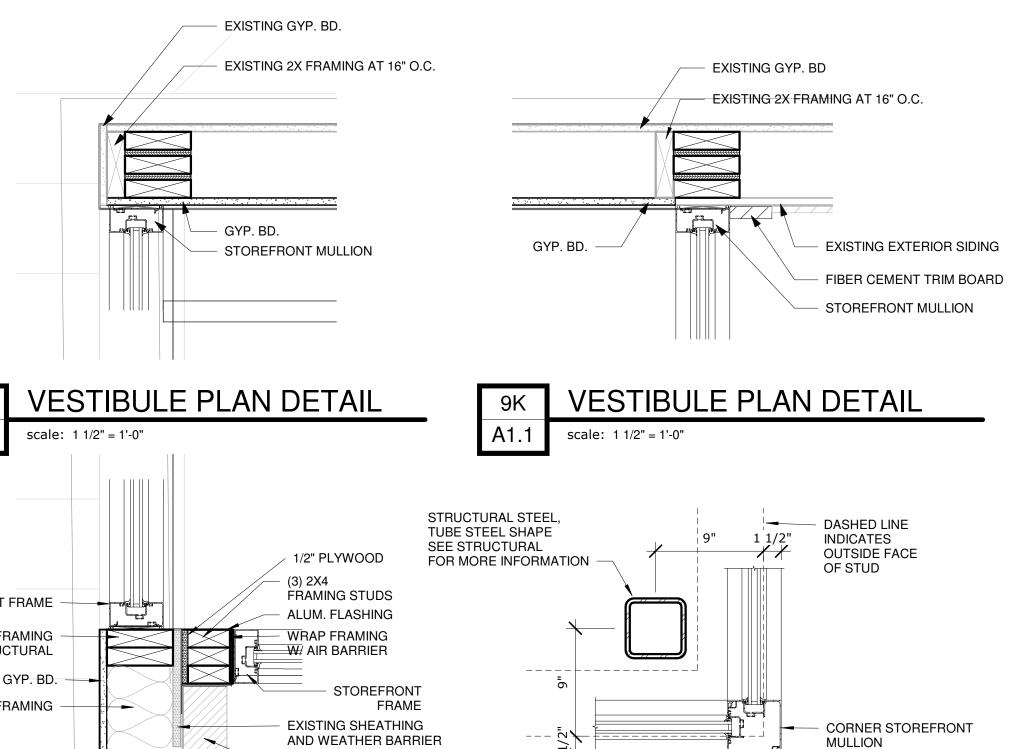
DATE: 12.08.2017



DEMO FLOOR PLAN

scale: 1/8" = 1'-0"



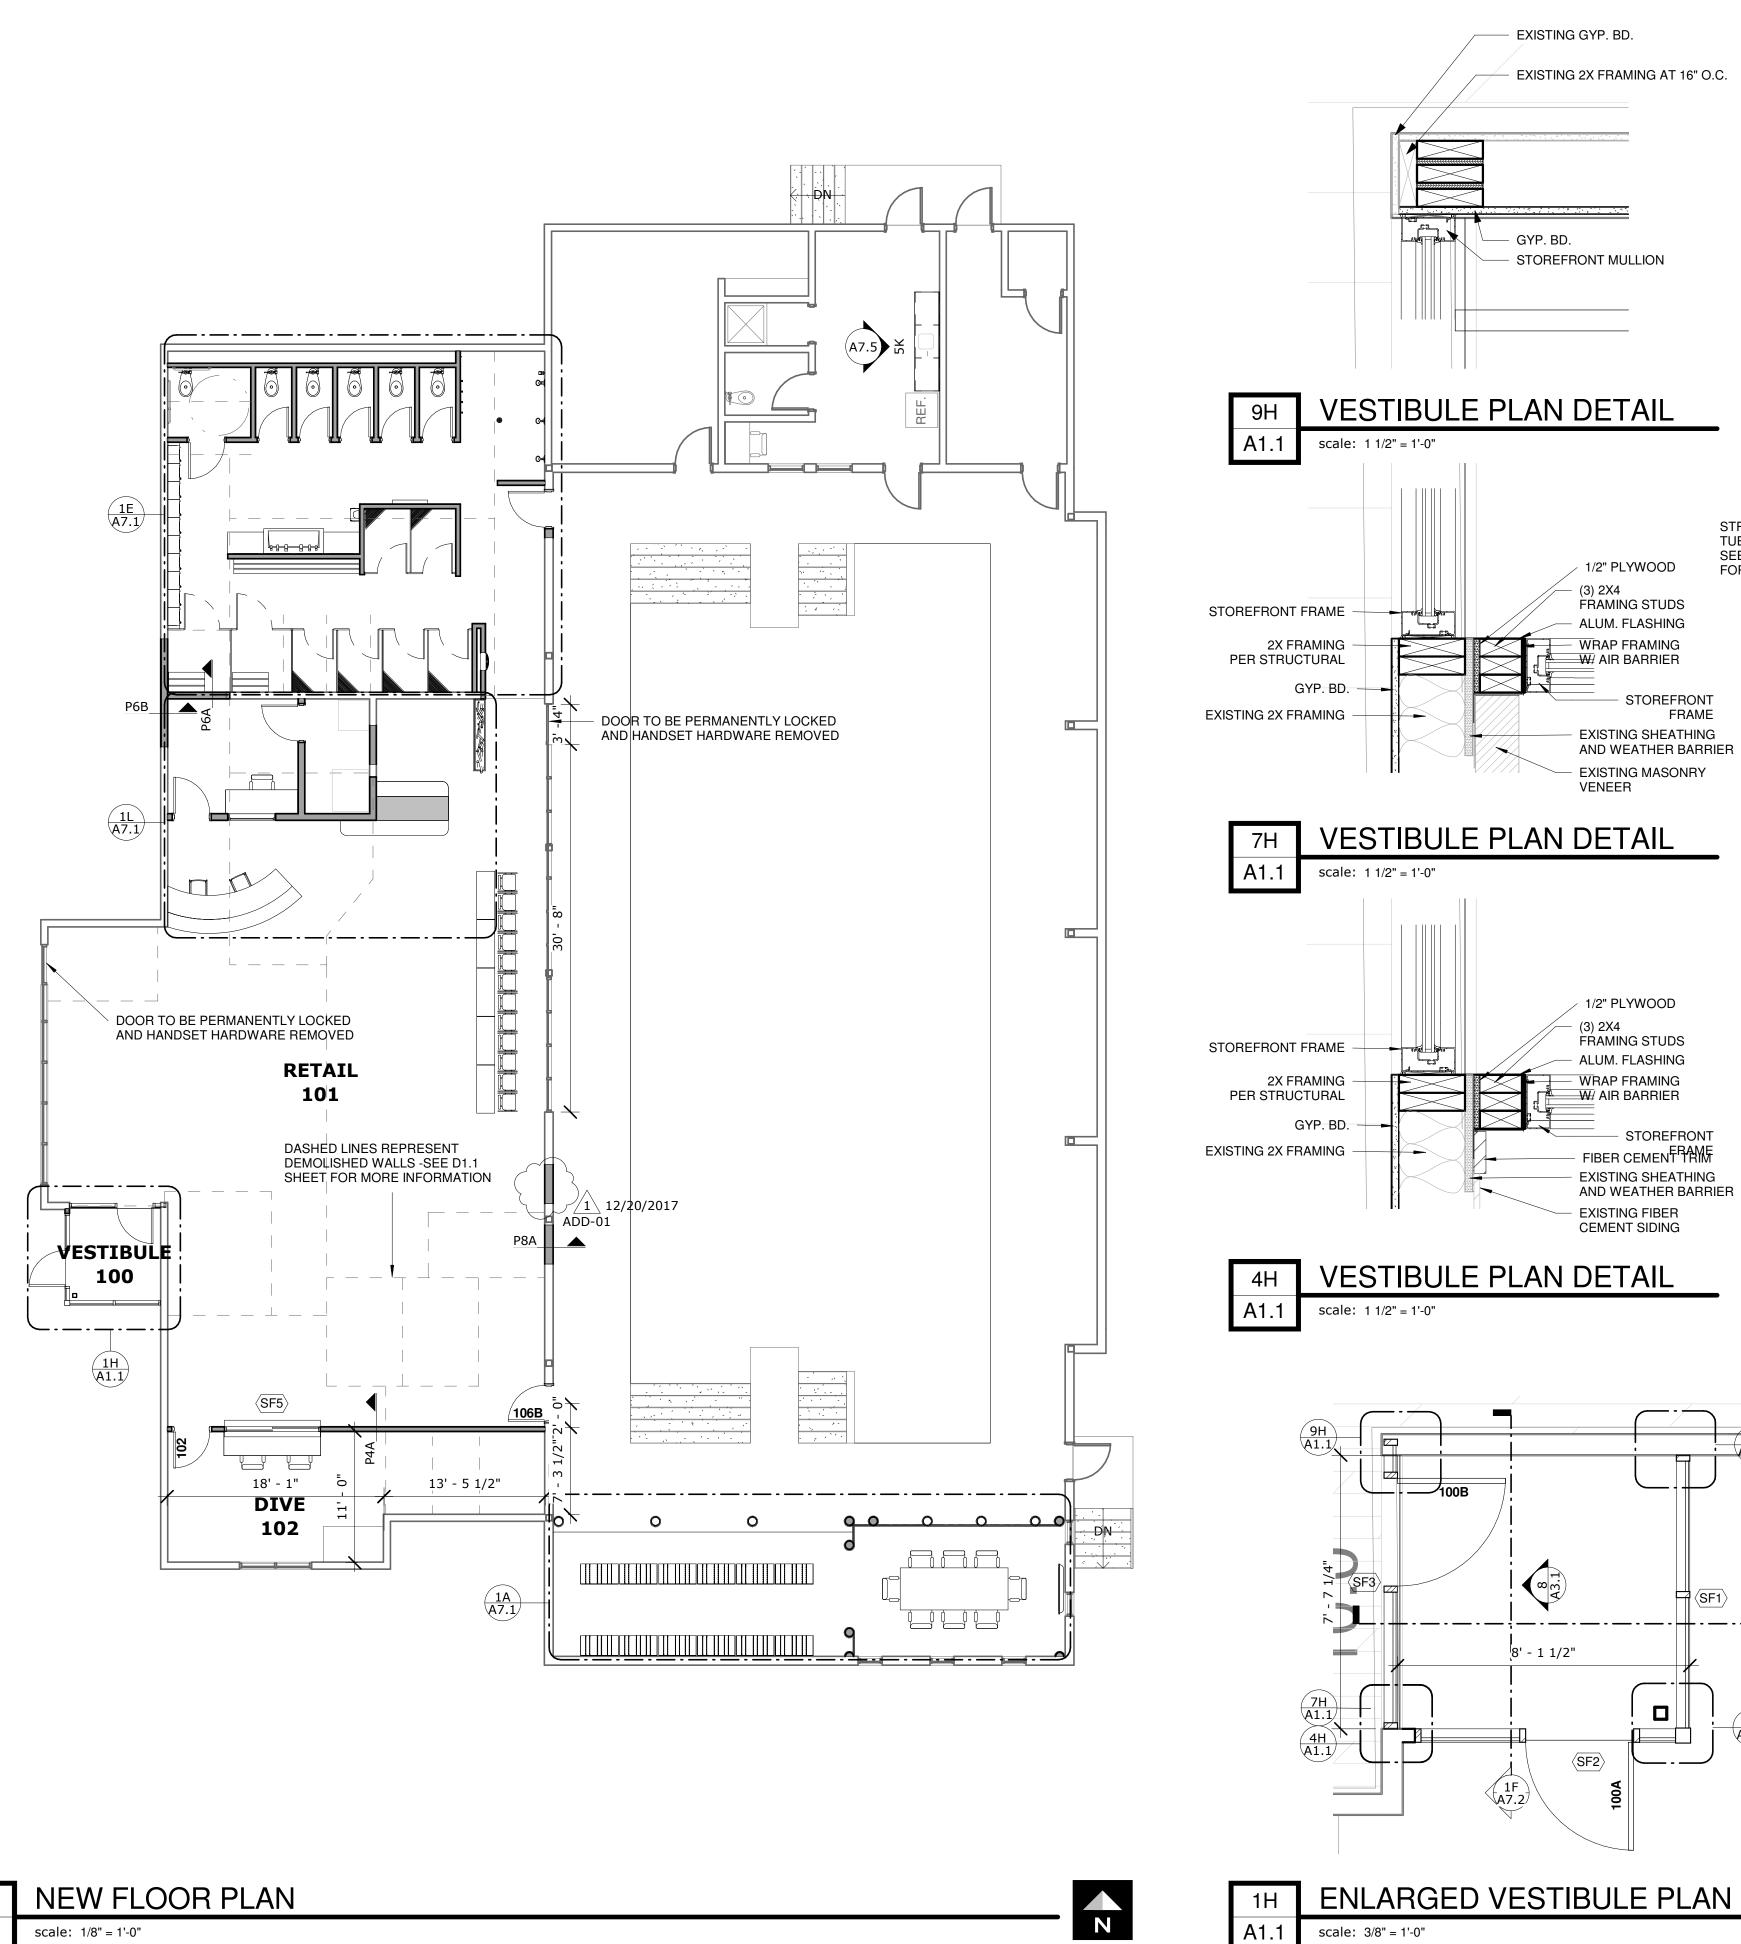

STOREFRONT CORNER DETAIL scale: 1 1/2" = 1'-0"

OUTSIDE FACE -2X4 WOOD STUDS @ 16" O.C. FILL WITH SOUND BATT INSULATION -5/8" GYPSUM BOARD (WET WALLS, SEE NOTE #8) INSIDE FACE

OUTSIDE FACE WALLS, SEE NOTE #8) -2X6 WOOD STUDS @ 16" O.C. FILL WITH SOUND BATT INSULATION WALLS, SEE NOTE #8)

P8A

OUTSIDE FACE WALLS, SEE NOTE #8) -2X8 TIMBERSTRAND STUDS @ 16" O.C. FILL WITH SOUND BATT INSULATION WALLS, SEE NOTE #8)

## PARTITION TYPE **GENERAL NOTES**

- ARCHITECTS RECOMMENDATION ON RESTROOM PARTITIONS: ALL PARTITION TYPES TO RECEIVE ACOUSTIC SEALANT ON BOTH SIDES OF THE WALL AT TOP AND
- BOTTOM. ALL PARTITIONS TO RECEIVE WALL BASE ON BOTH SIDES OF WALL. REFER TO INTERIOR DESIGN SHEETS FOR MORE
- INFORMATION. ANY WALL CONSTRUCTION NOT NOTED WITH A PARTITION TYPE WALL TAG SHALL BE CLARIFIED FOR INTERPRETATION BY
- ARCHITECT PRIOR TO BIDDING. CONTRACTOR SHALL COORDINATE WALL FRAMING ABOVE FINISHED CEILINGS WITH FRAMING, PLUMBING, AND HVAC CONTRACTORS. FRAMING CONTRACTOR SHALL PROVIDE NECESSARY ROUGH OPENING FRAMING REQUIRED TO FACILITATE PIPING OR DUCTWORK PENETRATIONS - REFER TO MEP **ENGINEERING DRAWINGS FOR LOCATIONS** OF LOCATIONS OF NEW DUCTS, PIPING, ETC. SOME WALL FRAMING / BRACING MAY REQUIRE ADJUSTMENT OR RE-LOCATION TO ALLOW FOR DUCT / PIPE ROUTING. REFER TO U.L. DESIGN DIRECTORY FOR LISTED DESIGN NUMBERS NOT INDICATED.
- ALL PENETRATIONS AND CRACKS WITH ACOUSTICAL SEALANT. WALL SECTIONS INDICATE PRIMARY WALL TYPE. OVERLAID VENEERS, WAINSCOT, PILASTERS, PAINT, WALL COVERINGS ETC. ARE INDICATED ON FLOOR PLANS, FINISH PLANS, INTERIOR ELEVATIONS,

ASSEMBLIES SHOULD BE AIRTIGHT. SEAL

- SCHEDULES, SPECIFICATIONS OR OTHER ALL WALLS WITH PLUMBING FIXTURES SHALL RECEIVE MOISTURE AND MOLD RESISTANT GYPSUM BOARD-BASIS OF DESIGN 5/8" FIRE RESISTANT GYPSUM BOARD (GOLDBOND BRAND XP GYP. BD WITH SPORGUARD OR EQUAL), BOTH SIDES OF WALL TYP. UNLESS ABUTTING
- REFERENCE I.D. SHEETS AND A7 SHEETS FOR THE HEIGHTS OF FINISH MATERIALS (I.E. - TILE, WOOD PLANKS, ETC.)

\*SEE G-SERIES SHEETS FOR RATED WALLS/PARTITIONS

> OUTSIDE FACE -5/8" GYPSUM BOARD (WET WALLS, SEE NOTE #8) -2X4 WOOD STUDS @ 16" O.C. FILL WITH SOUND BATT INSULATION -5/8" GYPSUM BOARD (WET WALLS, SEE NOTE #8) INSIDE FACE

-5/8" GYPSUM BOARD (WET -5/8" GYPSUM BOARD (WET INSIDE FACE

-5/8" GYPSUM BOARD (WET -5/8" GYPSUM BOARD (WET INSIDE FACE

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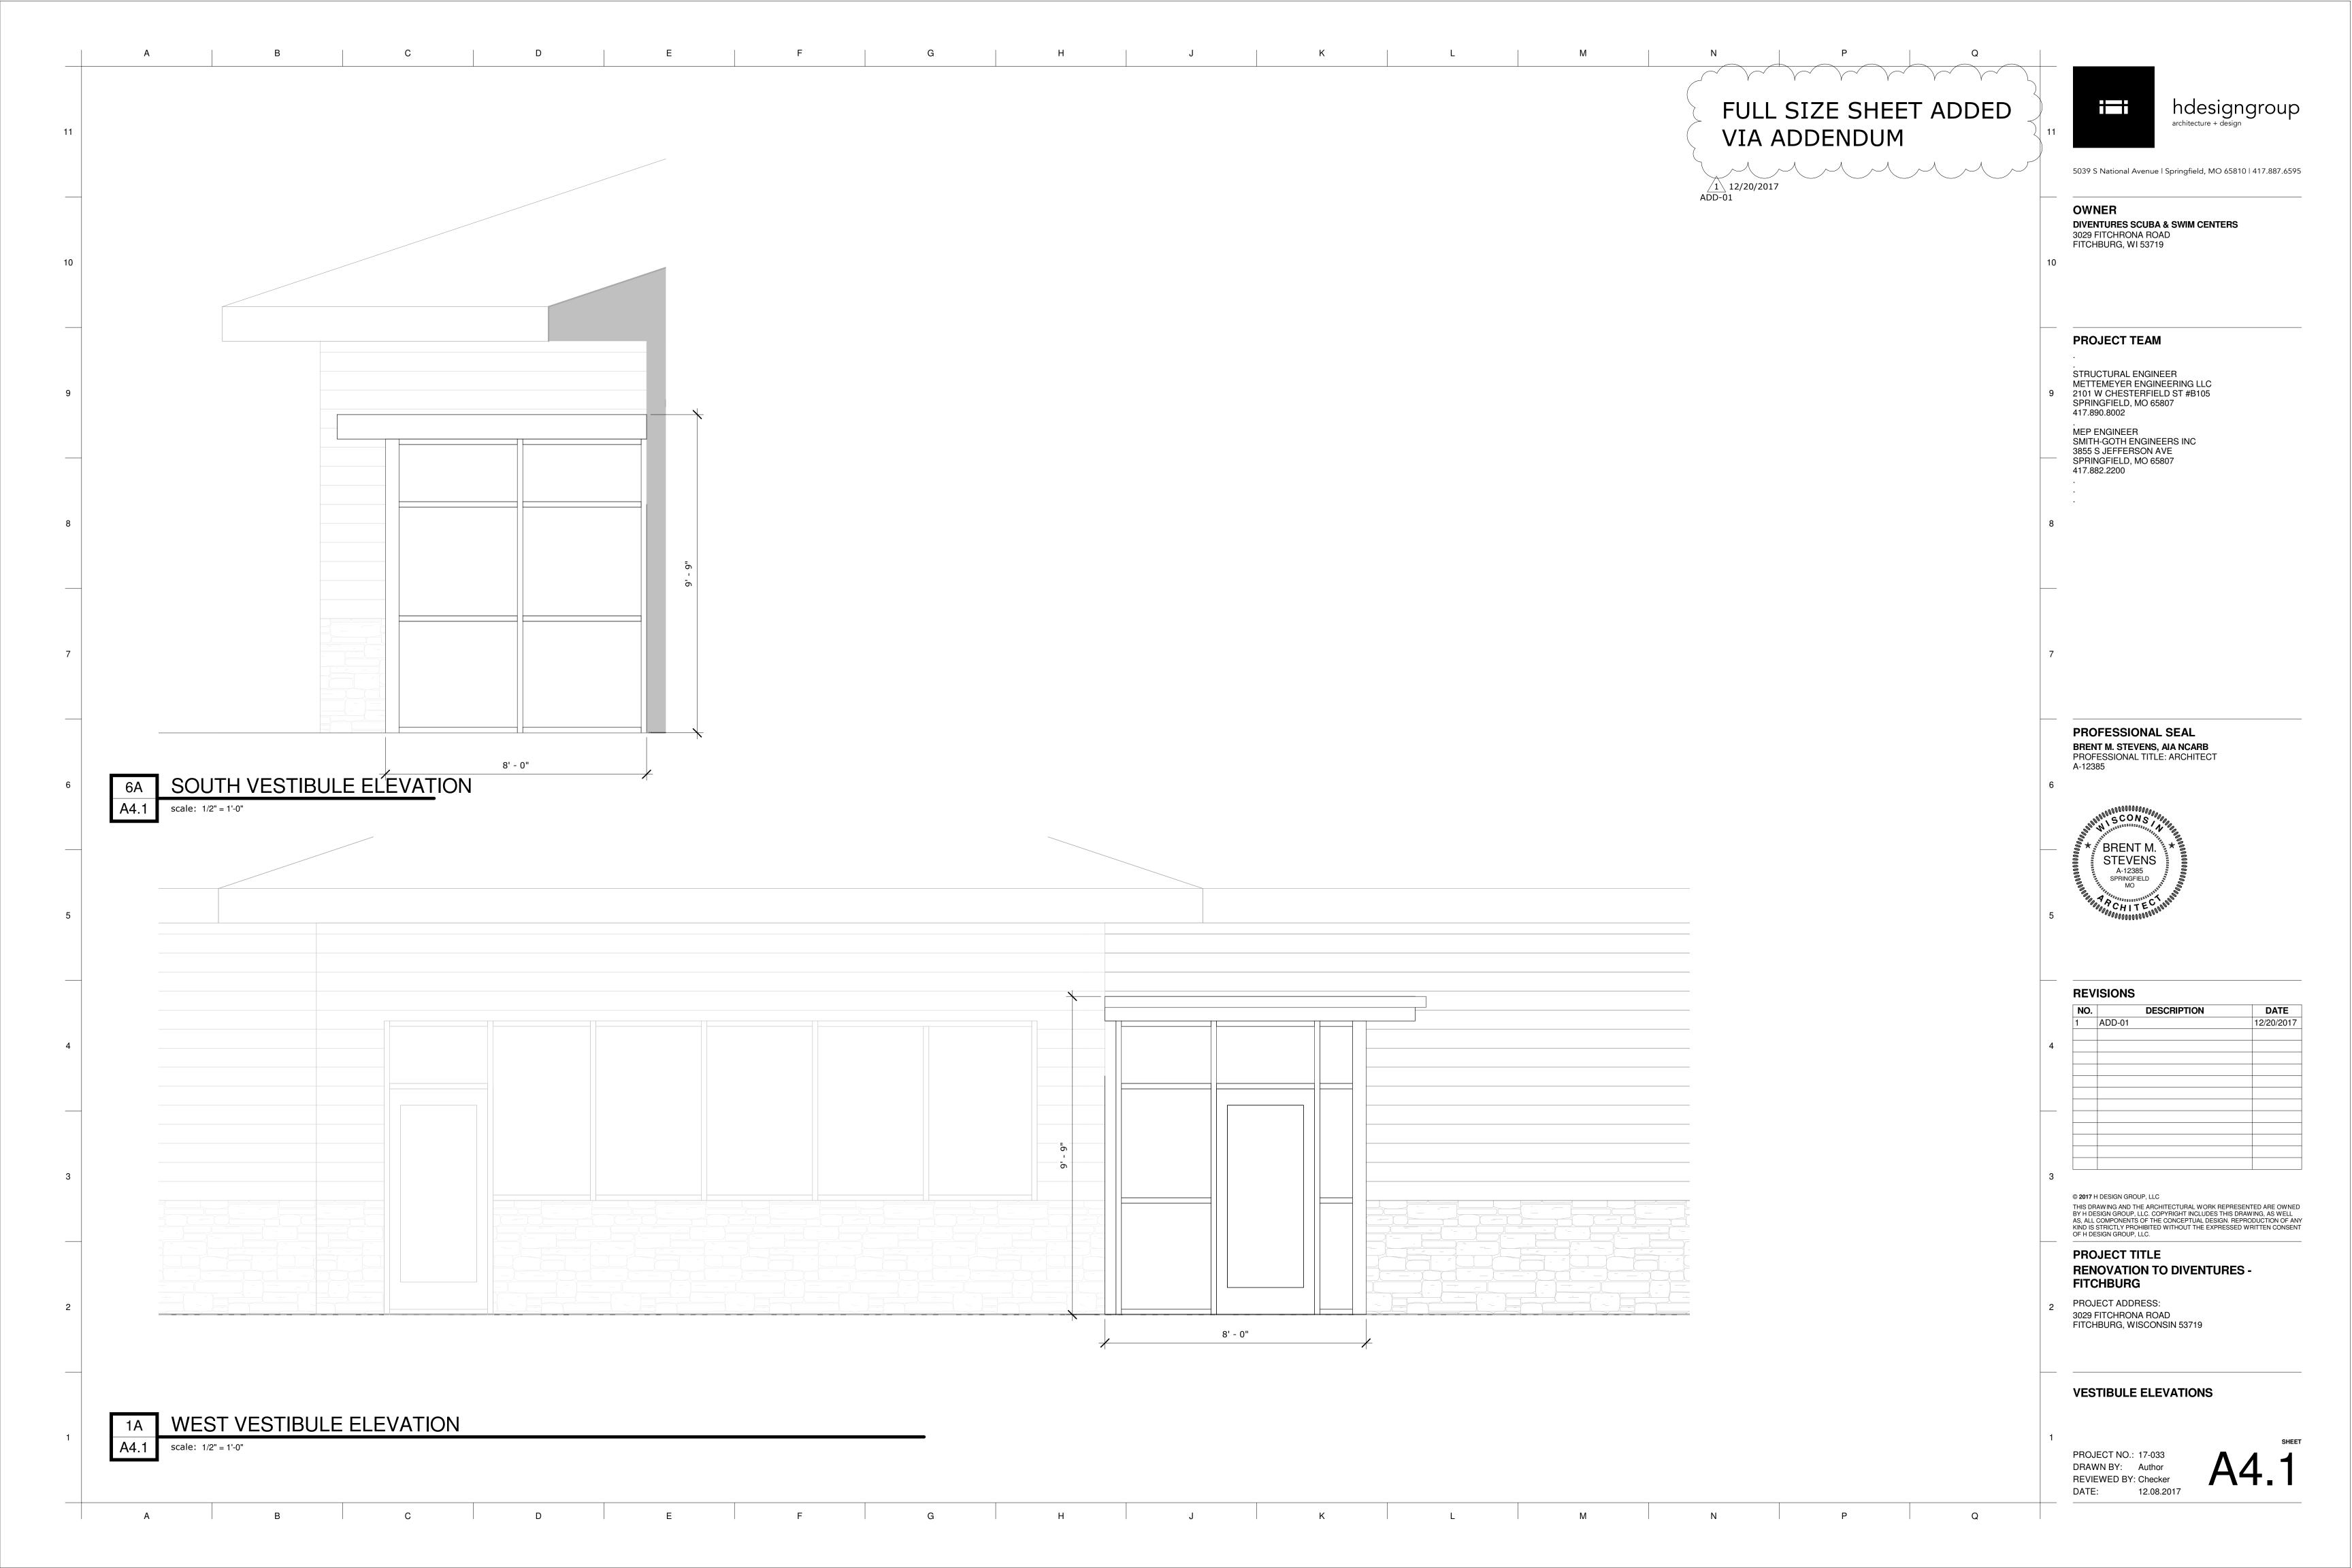
PROJECT TITLE **RENOVATION TO DIVENTURES -FITCHBURG** 


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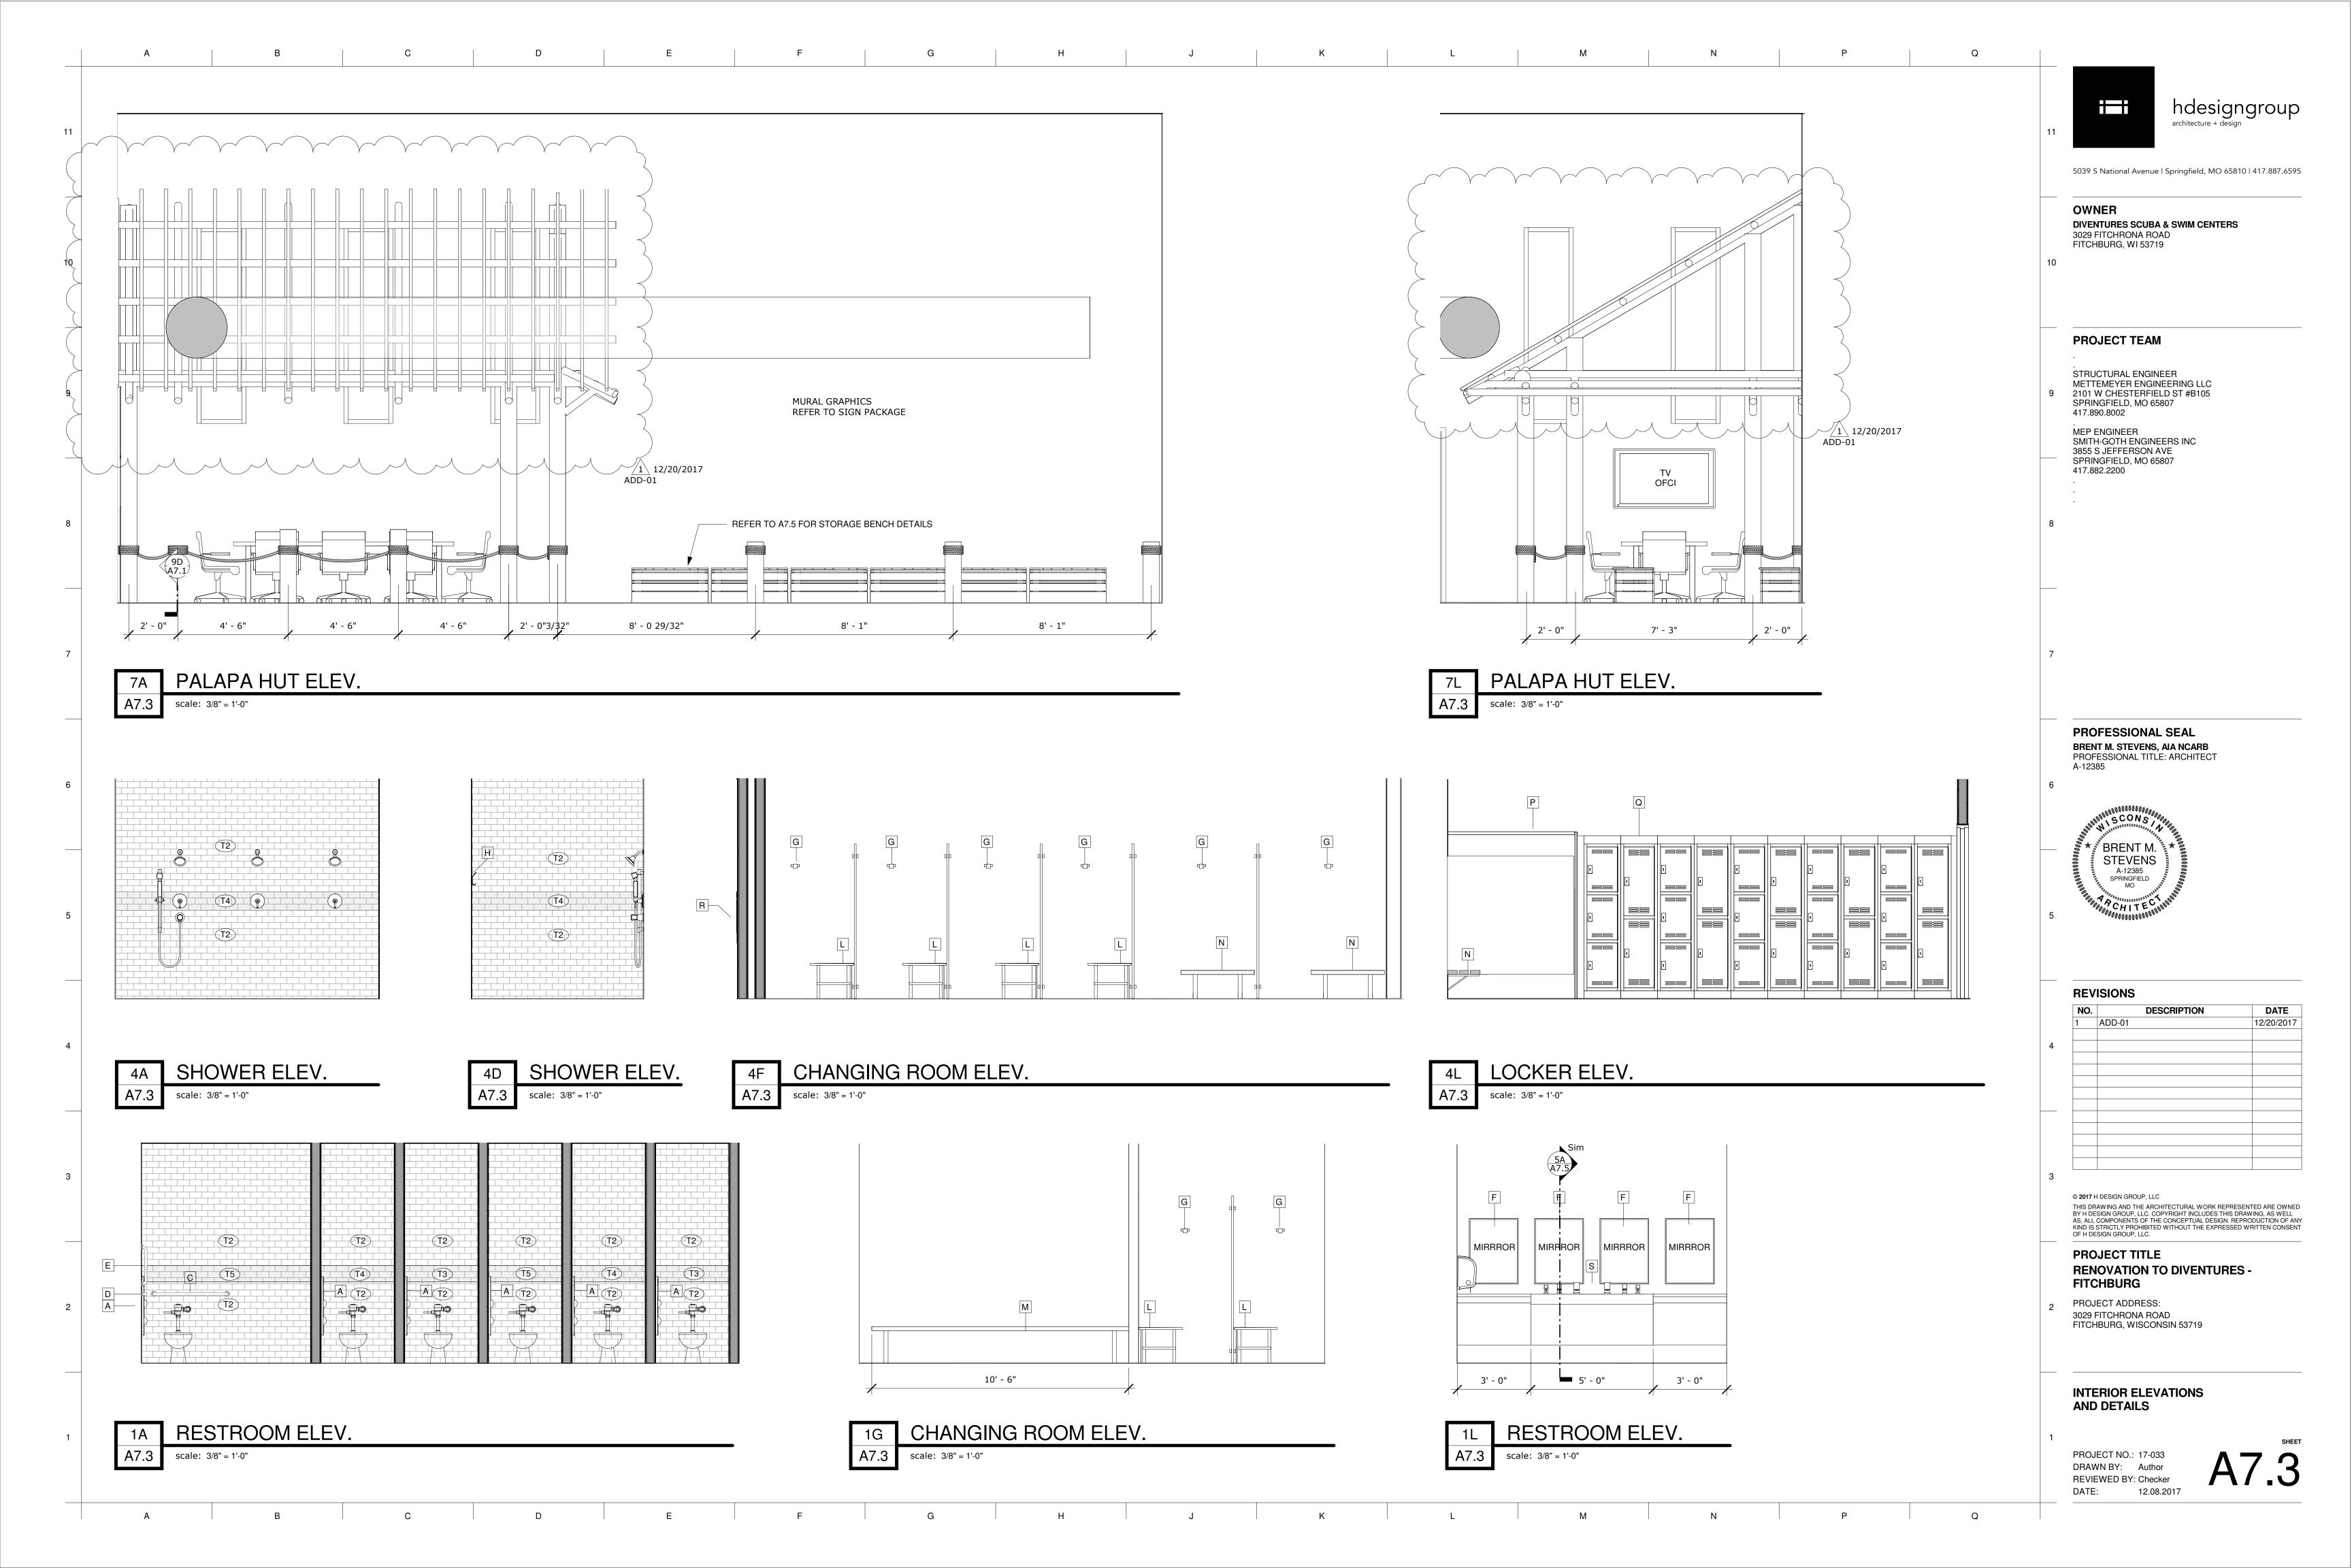
**NEW FLOOR PLAN** 

PROJECT NO.: 17-033 DRAWN BY: Author REVIEWED BY: Checker DATE:

12.08.2017






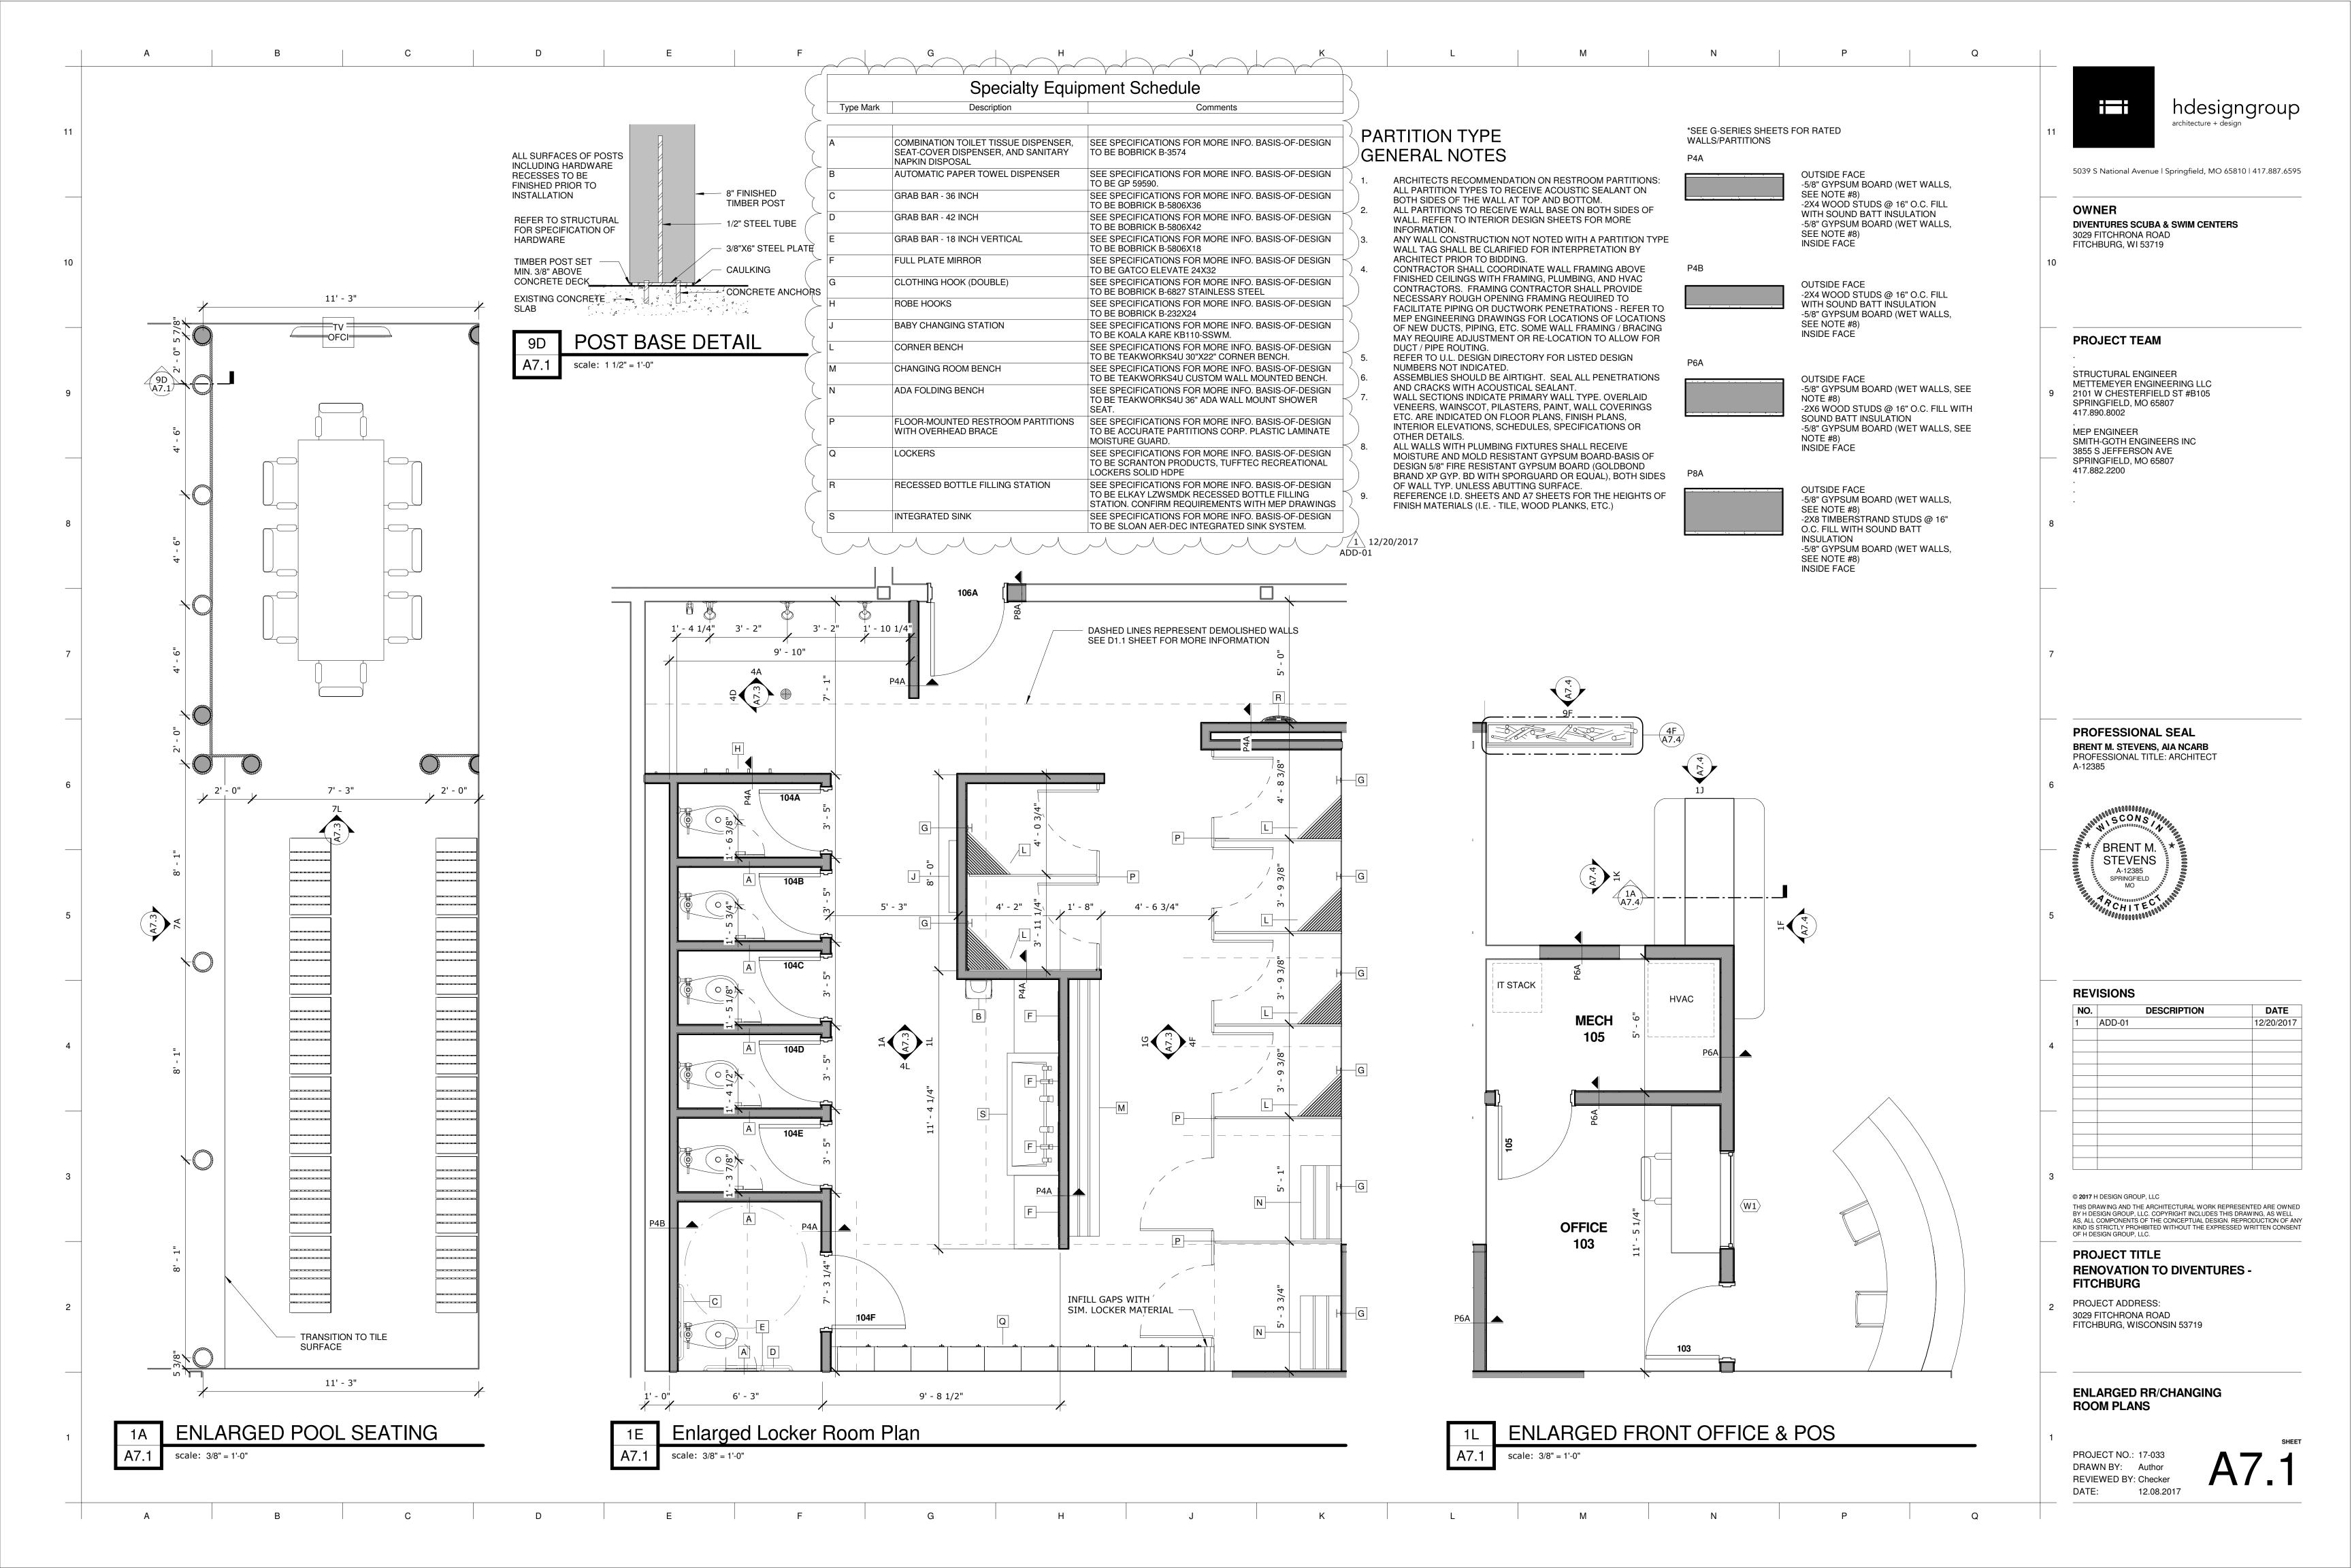

## REFLECTED CEILING PLAN LEGEND


GYP. BD. CEILING - SEE DETAILS, PAINT PER INTERIOR DESIGN INFORMATION

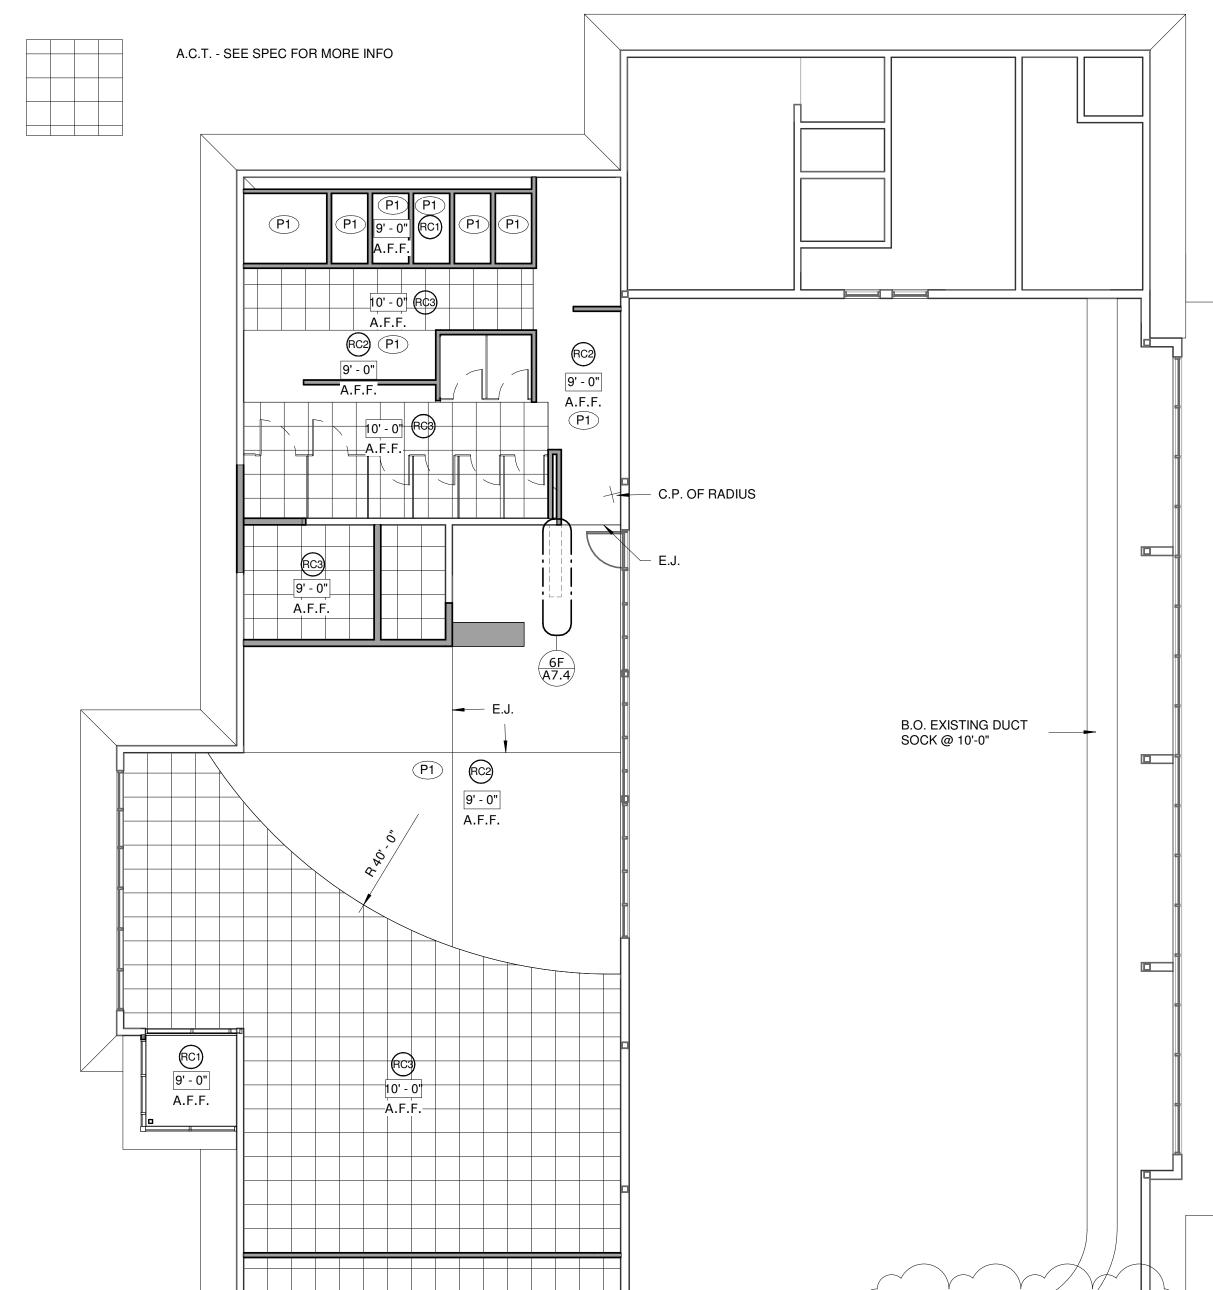


REFLECTED CEILING KEYNOTES Character GYPSUM GOARD SOFFIT. 5/8" GYPSUM ON WOOD STUD FRAMING. REFER TO INTERIOR ELEVATIONS FOR ADDITIONAL INFORMATION. PAINT. 5/8" GYPSUM BOARD ATTACHED TO DRYWALL CEILING SUSPENSION SYSTEM BELOW RATED ASSEMBLY. CEILING HEIGHT AS INDICATED. 2X2 SUSPENDED ACOUSTIC CEILING. REFER TO FINISH SCHEDULE.

## **CEILING PLAN GENERAL NOTES:**

- REFLECTED CEILING PLAN IS FOR LAYOUT OF GRID ONLY. SEE ELECTRICAL, MECHANICAL PLANS FOR QUANTITIES AND DETAILS OF REQUIRED EQUIPMENT.
- CEILING HEIGHT IS APPROXIMATE. UNFORESEEN ITEMS MAY PREVENT INSTALLATION AT SPECIFIED CEILING HEIGHT. COORDINATE WITH ARCHITECT FOR APPROVAL OF ANY MAJOR HEIGHT ADJUSTMENTS.
- BALANCE CEILING GRID AS SHOWN ON PLANS. ADJUSTMENTS OF GRID SHALL BE APPROVED BY ARCHITECT PRIOR TO INSTALLATION.
- ALL EXPOSED GYPSUM BOARD TO BE PAINTED. SEE INTERIOR DESIGN SHEETS FOR MORE INFORMATION.

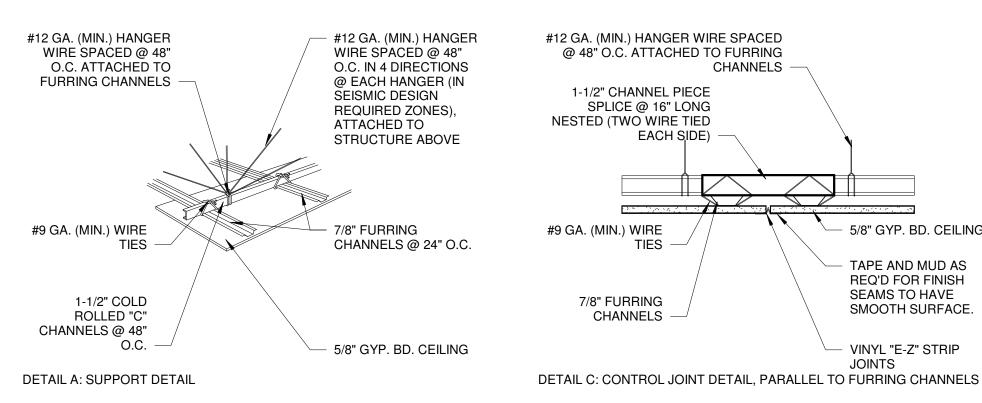

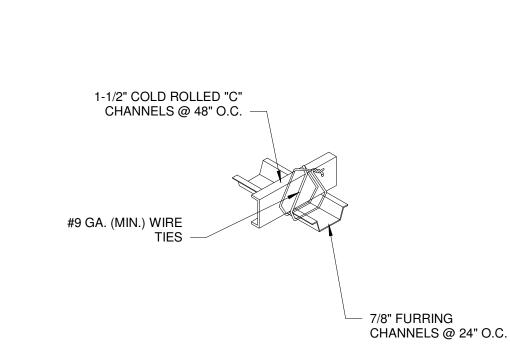

DETAIL B: CONTROL JOINT DETAIL, PERPENDICULAR TO FURRING CHANNELS DETAIL D: SADDLE TIE DETAIL

**JOINTS** 

5/8" GYP. BD. CEILING

TAPE AND MUD AS

REQ'D FOR FINISH

SMOOTH SURFACE.

SEAMS TO HAVE

VINYL "E-Z" STRIP

# SUSPENDED GYPSUM BOARD DETAILS

scale: 1 1/2" = 1'-0"

#12 GA. (MIN.) HANGER WIRE SPACED

SADDLE TIE

SHORT PIECE OF

**INVERTED FOR** 


**FURRING** CHANNEL CLIP OR WIRE

**FURRING** 

SPLICE

CHANNEL

@ 48" O.C. ATTACHED TO FURRING

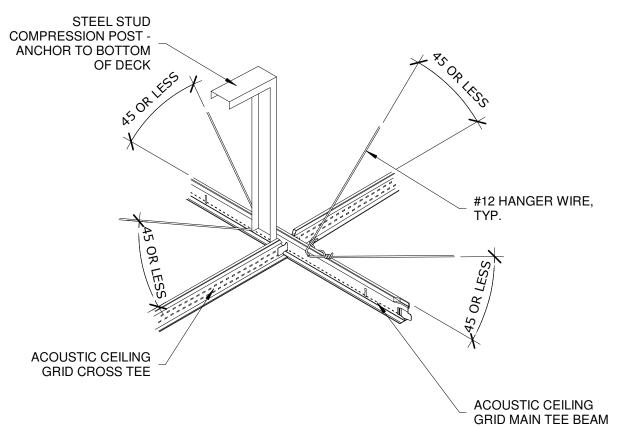

## GENERAL ACOUSTIC CEILING TILE SEISMIC NOTES:

5/8" GYP. BD. CEILING

TAPE AND MUD AS REQ'D FOR FINISH

SEAMS TO HAVE

- VINYL "E-Z" STRIP

**JOINTS** 

SMOOTH SURFACE.

GENERAL ACOUSTIC CEILING TILE SEISMIC NOTES:

- ACOUSTIC CEILING TILE MUST BE INSTALLED TO MEET CISCA RECOMMENDATIONS.
- USE A MINIMUM 7/8" WALL MOLDING. A MINIMUM 3/8" CLEARANCE MUST BE MAINTAINED ON ALL SIDES
- BETWEEN WALL AND TILE. A MINIMUM 3/8" OVERLAP MUST BE MAINTAINED BETWEEN GRID
- AND WALL MOLDING. ENDS OF MAIN BEAMS AND CROSS TEES MUST BE TIED
- TOGETHER TO PREVENT THEIR SPREADING WITH STABILIZER
- BARS, ENTIRE PERIMETER OF CEILING. SAFETY WIRES FOR LIGHT FIXTURES ARE REQUIRED - SEE MEP DRAWINGS FOR MORE INFORMATION.
- USE SEISMIC CLIPS BETWEEN WALL MOLDING AND GRID TEES. TWO ADJACENT WALLS MUST USE THE TEES. THE OTHER TWO WALLS MUST USE THE "UNATTACHED WALL" METHOD WHERE
- SEISMIC CLIPS ARE SECURED TO THE WALL MOLDING AND ARE ALLOWED TO MOVE FREELY THROUGH THE EXPANSION SLOT. THE FIRST WIRE HANGER MUST BE WITHIN 8" FROM WALL
- SURFACE. WIRE HANGERS IN (4) DIRECTIONS (90 DEGREES FROM EACH WIRE) MUST BE ATTACHED TO THE INTERSECTION OF THE GRID TEES AT INTERVALS OF 4'-0" ON CENTER BOTH DIRECTIONS AT NO MORE THAN A 45 DEGREE ANGLE FROM THE PLANE OF THE CEILING. SEE DETAIL FOR ANGULAR ALLOWANCES FOR WIRE HANGERS.
- 10. INTERSECTIONS BETWEEN CROSS TEES AND MAIN BEAMS MUST BE SECURED WITH CROSS TEE SEISMIC JOINT CLIP. 11. SPLICES MUST BE SECURED WITH SEISMIC SPLICE CLIP.



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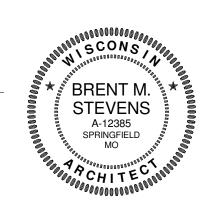
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## REFLECTED CEILING PLAN

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REFLECTED CEILING PLAN

A.F.F.

scale: 1/8" = 1'-0"

N

/1\ 12/20/2017

G