# **Two Wells Ave**

## Two Wells Ave, Newton, MA 02458

**PROJECT TEAM:** 

CLIENT **TWO WELLS AVENUE, LLC** 145 Rosemary Street Needham, MA, 02492

ARCHITECT SGA 200 High Street Boston, MA, 02110 857.300.2610



### LANDSCAPE ARCHITECT **RADNER DESIGN ASSOCIATES**

945 Concord Street, Suite 100 Framingham, MA 01701 508.736.6144

### STRUCTURAL ENGINEER **THORNTON-TOMASSETTI GROUP**


470 Atlantic Avenue, 4th Floor Boston, MA, 02110 617.273.8313


## Boston, MA 02210 617.210.1600

CIVIL ENGINEER **NITSCH ENGINEERING** 2 Center Plaza, Suite 430 Boston, MA 02108 857-206-8737

### MEP/FP ENGINEERS WSP | PARSONS BRINCKERHOFF

88 Black Falcon Avenue, Suite 210

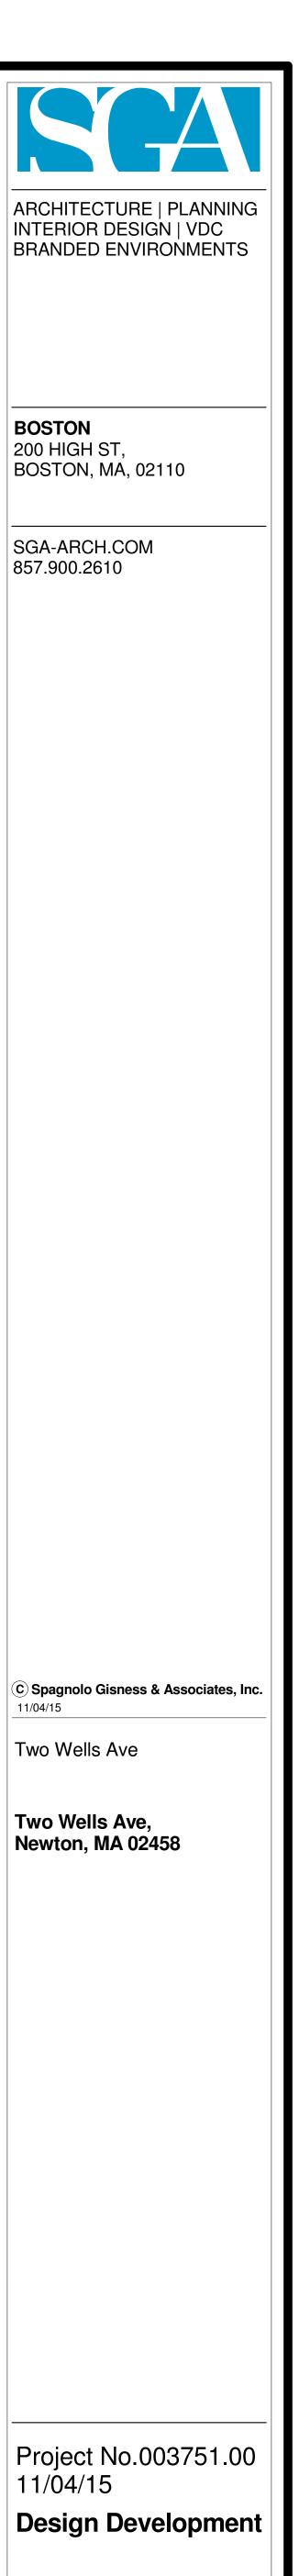


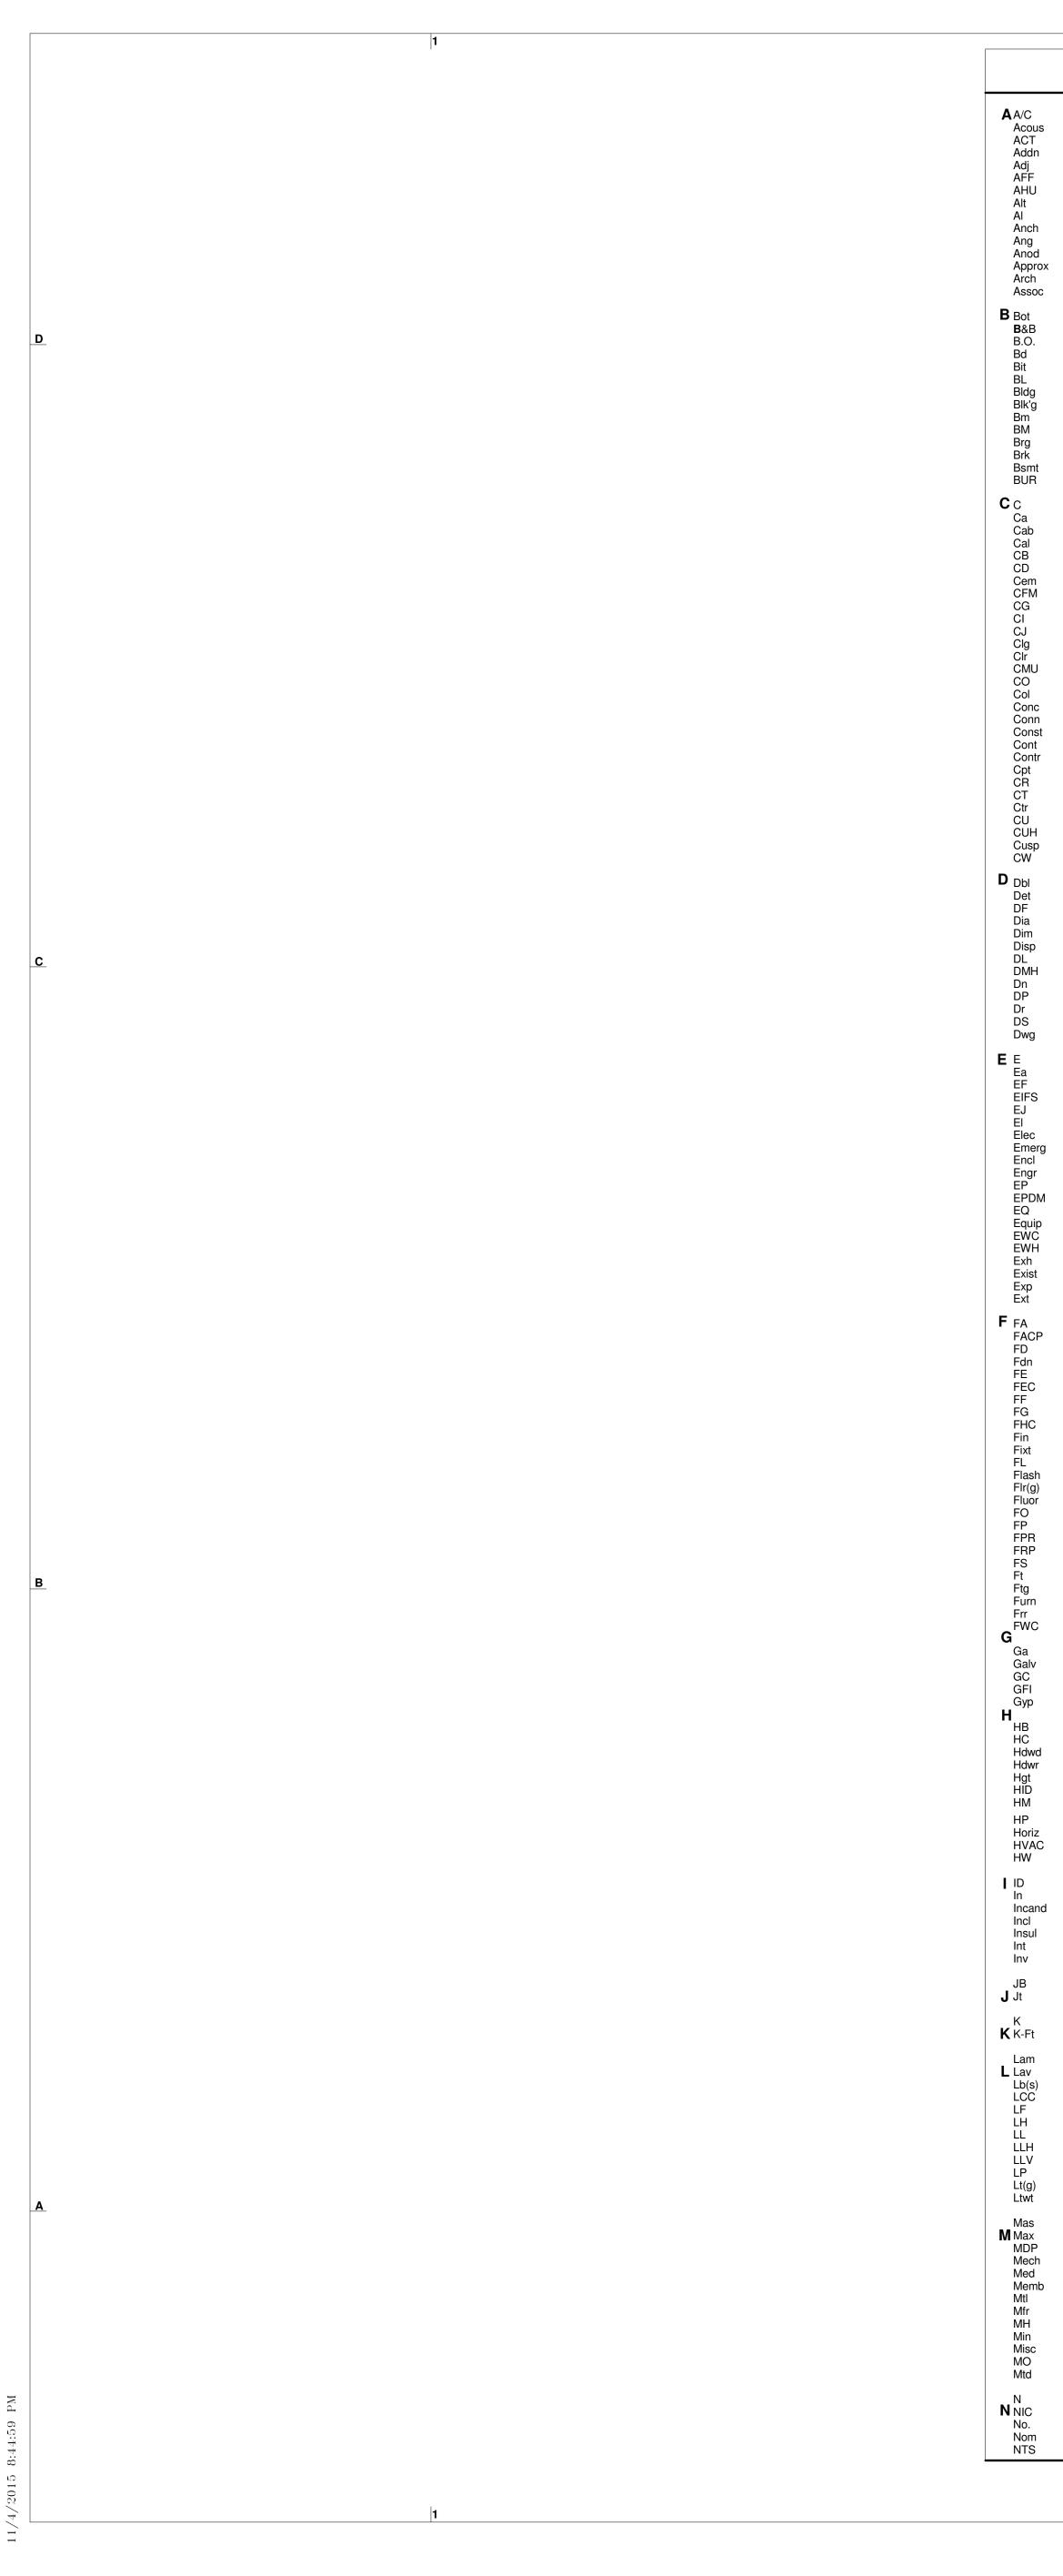



<sup>2</sup> Abbreviations				Tags & Symbols				
	Air Conditioning Acoustical	<b>O</b> OC	On Center(s)	General				
T In	Acoustical Ceiling Tile Addition Adjacent	OD OI Opg	Outside Diameter Open Item Opening	Sheet Number	0         Keynote Number			
= J	Above Finished Floors Air Handling Unit Alternate	Opp ORD Oz	Opposite Overflow Roof Drain Ounce	A512				
h	Aluminum Anchor Angle	P PA PCF	Project Architect Pounds Per Cubic Foot	Sheet Number	Annotation Text			
od prox	Anodized Approximate Architect	Perf Pl Plam	Perforated Plate Plastic Laminate	Category Number Discipline Letter				
60C	Associated Bottom	Plas Plbg PLF	Plaster Plumbing Pounds Per Linear Foot	Discipline	Annotation Tag Number- Boxed			
B ).	Balled and Bur Lapped Bottom of Board	Plywd Pnl Pol	Plywood Panel Polish(ed)	G GENERAL C CIVIL L LANDSCAPE	€ Center Line			
a	Bituminous Building Line Building	PP Pr Proj	Power Panel Pair Project	S STRUCTURAL A ARCHITECTURAL	د Center Line			
g	Block(ing) Beam Bench Mark	Prtn PSF PSI	Partition Pounds Per Square Foot Pounds Per Square Inch	-AD DEMOLITION -AF FINISHES	Align Symbol			
nt	Bearing Brick Basement	Pt Ptd PV	Point Painted Plumbing Vent	F FIRE PROTECTION P PLUMBING				
R	Built-up Roofing Door Contact	PVC Pvmt	Polyvinyl Chloride Pavement	M MECHANICAL E ELECTRICAL	$(s) \rightarrow$ Sealant Symbol			
D	Card Reader Cabinet Caliper	Q QT Qty	Quarry Tile Quantity	T TELECCOMMUNICATION	Dresk Line			
n	Catch Basin Ceiling Diffuser Cement	R RB RCP	Radius Rubber Base Reflected Ceiling Plan	<u>Category</u>	Break Line			
M	Cubic Feet Per Minute Corner Guard Cast Iron	RD Re Recpt	Roof Drain Refer Receptacle	000 General 100 Floor Plans	Project North			
	Control Joint Ceiling Clear	Ref Reinf Req	Reference Reinforce(d)/(ing) Required	200 Elevations 300 Sections	True North			
U	Concrete Masonry Unit Clean Out	Resil Rev Rfg	Resilient Revisions, Revised Roofing	400 Large Scale Views 500 Details				
าท	Column Concrete Connection	RH Rm RO	Right Hand Room Rough Opening	600 Schedules & Diagrams 700 User Defined (typical Details)				
nst nt ntr	Construction Continuous Contract(or)	ROW Rr RTU	Right of Way Restroom Roof Top Unit	800 User Defined 900 3d Representations	1 / A101 View Reference			
	Carpet Ceiling Register Ceramic Tile	RWL RV	Rain Water Leader Roof Vent	<u>Tags</u>				
Н	Center Condensing Unit Cabinet Unit Heater	San	South Sanitary Suspended Acoustical Tile	Room name	Revision Tag			
	Cuspidor Cold Water	SAT SC Sched	Solid Core Schedule	Name	$\langle \zeta \rangle$			
	Double Detail Drinking Fountain	SD Sect Serv	Storm Drain Section Service	101 C1 Room Tag With	Specialty Equipment			
ו ס	Diameter Dimension Dispenser	SF Sht Sim	Square Feet Sheet Similar	B1 Finishes P1	Tag Standard			
Н	Dead Load Drainage Manhole Down	SMH SOV Spec	Sanitary Manhole Spray on Vinyl Specifications	Building Section	(1)(1.2) (2)			
	Distribution Panel Door Downspout	Sq SS SSTL	Square Solid Surface Stainless Steel	1 SIM 1 SIM				
g	Drawing	Std Stl Stor	Standard Steel Storage	A101 A101	(A) - + - + +			
S	Each Epoxy Flooring Exterior Insulation Finish System	Struc Susp Sym	Structural Suspended Symmetrical	Wall Section	(A.5) $  +$ $         -$			
	Expansion Joint Elevation Electrical	Syst <b>T</b> ⊤	System Tread	1 SIM A101				
	Emergency Enclosure Engineer	T.O. T&G Tel	Top Of Tongue and Groove Telephone	Detail Section				
,	Electrical Panel Ethylene Propylene Diene Monomer	Temp Thk Thres	Temperature, Tempered Thick Threshold	1 SIM				
uip C	Equal Equipment Electric Water Cooler	TP TS	Toilet Partition Transition Strip	A101	(101) Door Tag			
'H n st	Electric Water Heater Exhaust Existing	Typ TV	Typical Television		A Window Tag			
)	Exterior	U UG UH UNO	Underground Unit Heater Unless Noted Otherwise	SIM	ESF			
CP	Fire Alarm Fire Alarm Control Panel Floor Drain	Unfin UV	Unfinished Ultra Violet		Storefront / Curtain Wall Tag			
ı C	Foundation Fire Extinguisher Fire Extinguisher Cabinet	V VCT Vert Vent	Vinyl Composition Tile Vertical Ventilator		Type Number			
	Finished Floor Finished Grade Fire Hose Cabinet	VIF VWC	Verify in Field Vinyl Wall Covering		Curtain Panel Wall Tag			
		W w w/ w/o	west with without	Name Elevation Tag	Fire Rating Wall Construction Stud Size			
sh g) or	Flashing Floor(ing) Fluorescent	wc wd wh	water Closet wood water Heater	Elevation	Specialty Construction			
	Face Of Fireproof Fire Proof	wp wpt wr	waterproof work Point water Resistant	• 4-0 Spot Elevation	1G3A Wall/Partition Tag			
	Fiber Reinforced Panel Floor Sink Foot, Feet	wsct wt wv	wainscot weight water Valve					
n	Footing Furnish(ed)	wwf	welded Wire Fabric	1 <u>View Name</u> 1/8" = 1'-0"	GYP 1'-0" Ceiling Tag With Height			
С	Furring Fabric Wall Covering	<b>Y</b> yd	yalu	View Title	Type Name Ceiling Height			
V	Gauge, Gage Galvanized General Contractor			-	20 R @ 7 1/2" Stair Tag			
)	Ground Fault Interrupter Gypsum			Interior Elevation Mark				
vd	Hose Bibb Hollow Core Hardwood			~ <b>r</b> .	1iSpecialty EquipmentTag Boxed			
vr )	Hardware Height High Intensity Discharge				1i Case Work Tag Boxed			
iz	Hollow Metal High Point Horizontal			- A202 - Exterior Elevation Mark	1i Case Work Tag Boxed			
AC	Heat, Vent, A/C Hot Water							
and	Inside Diameter Inch Incandescent			Material Cut Patterns				
	Include(d)/(ing) Insulat(ed)/(ion) Interior							
	Junction Box			Concrete				
	Joint			Earth Compacted				
	Kip (1,000 Pounds) Kip Feet			Earth Undisturbed				
s)	Laminated Lavatory Pound(s)			Gravel				
ر	Lead Coated Copper Linear Feet Left Hand			Gypsum Wall Board				
H /	Live Load Long Leg Horizontal Long Leg Vertical							
J) t	Low Point Light(ing) Lightweight							
x	Masonry Maximum			Masonry-brick				
P ch d	Main Distribution Panel Mechanical Medium			Masonry-conc Block				
	Membrane Metal Manufacturer			Masonry-stone				
	Manhole Minimum Miscellaneous			Metal- Steel				
-	Masonry Opening Mounted			Wood-finish				
	North Not In Contract Number							
n S	Nominal Not to Scale			Veneer Core Plywood				

Sheet Number	Sheet Name	10/09/15 Demo & Enabling	11/04/15 DD Set
1) General	Sneet Name	7	÷
G-000 G-001	Cover Drawing List, Symbols, and Abbreviations		•
G-003 2) Civil	Overall Plan		٠
C-0.0 C-1.0	Notes, Abbreviations, And Legend           Area Wide Plan And Key Plan		•
C-2.0 C-2.1	Layout And Materials Plan Layout And Materials Plan Layout And Materials Plan		•
C-2.2 C-2.3 C-2.4	Layout And Materials Plan Layout And Materials Plan Fire Access Plan		•
C-2.5 C-2.6	Soil Test Pit Data (Form 11) Soil Test Pit Data (Form 11)		•
C-3.0 C-3.1	Grading And Utility Plan Grading And Utility Plan		•
C-3.2 C-3.3	Grading And Utility Plan Grading And Utility Plan		•
C-3.4 C-4.0	Average Grade Plane Plan Erosion And Sedimentation Control Plan		•
C-5.0 C-5.1	Erosion And Sedimentation Control Details Erosion And Sedimentation Control Details		•
C-5.2 C-5.3	Civil Construction Details 1 Civil Construction Details 2		•
C-5.4 C-5.5	Civil Construction Details 3 Civil Construction Details 4		•
C-5.6 C-6.1	Civil Construction Details 5 Site Cross-Sections		•
EX-1.1 EX-1.2	Existing Conditions Plan Existing Conditions Plan		•
EX-1.3 EX-1.4	Existing Conditions Plan Existing Conditions Plan		•
EX-1.5 3) Landscaping			•
0.0 0.1 0.2	Tree Removal Plan 1 Tree Removal Plan 2 Tree Removal Plan 3		•
0.2 0.3 1.0	Tree Removal Plan 3 Tree Removal Plan 4 Planting Plan 1		•
1.0 1.1 1.2	Planting Plan 2 Planting Plan 3		•
_ 1.2 1.3 1.4	Planting Plan 4 Plant Schedule And Details		•
2.0 2.1	Lighting Plan 1 Lighting Plan 2		•
2.2 2.3	Lighting Plan 3 Lighting Plan 4		•
4) Demolition & DE-A-01		•	
DE-A-02 DE-A-03	Construction Plan Construction RCP	•	
DE-A-04 5) Architecture	Wall Sections	•	
A-101a A-101b	First Floor Construction Partial Plan - Wing A First Floor Construction Partial Plan - Wing B		•
A-101c A-102a	First Floor Construction Partial Plan - Wing C Second Floor Construction Partial Plan - Wing A		•
A-102b A-103a	Second Floor Construction Partial Plan - Wing B Third Floor Construction Partial Plan - Wing A		•
A-103b A-104a	Third Floor Construction Partial Plan - Wing B Roof Construction Partial Plan - Wing A		•
A-104b A-106 A-107	Roof Construction Partial Plan - Wing B Typical Roof Details Soffit Plans		•
A-111b A-111c	First Floor Finish Plans & Schedule		
A-112b A-113b	Second Floor Finish Plans & Schedule Third Floor Finish Plans & Schedule		
A-121 A-122	First Floor Reflected Ceiling Plans & Details Second Floor Reflected Ceiling Plans & Details		•
A-123 A-131a	Third Floor Reflected Ceiling Plans & Details First Floor Edge of Foundation Wall Plan Wing A		•
A-131b A-132a	First Floor Edge of Foundation Wall Plan Wing B Second Floor Edge of Foundation Wall Plan Wing A		
A-132b A-133a	Second Floor Edge of Foundation Wall Plan Wing B Third Floor Edge of Foundation Wall Plan Wing A		
A-133b A-201	Third Floor Edge of Foundation Wall Plan Wing B North & South Exterior Elevations		•
A-202 A-203	East Exterior Elevations West Exterior Elevations		•
A-301 A-302	Building Sections Building Sections Tailet Plan Elevetions & Schedule		
A-405 A-420 A-501	Toilet Plan, Elevations, & Schedule Elevator Plans, Section, & Details Foundation Section Details		•
A-501 A-502 A-504	Foundation Section Details         Section Details         Roof Edge Section Details		•
6) Structural DE-S-01	DEMOLITION FOUNDATION PLAN	•	
DE-S-02 DE-S-03	DEMOLITION ROOF PLAN DEMOLITION SECTIONS & DETAILS	•	
S0-000 S0-001	Cover Sheet & Drawing List General Notes I		•
60-002 61-101a	General Notes II First Floor Foundation Plan-A		•
S1-101b S1-101c	First Floor Foundation Plan-B First Floor Foundation Plan-C		•
61-102a 61-102b	Second Floor Framing Plan-A Second Floor Framing Plan-B		•
S1-103a S1-103b	Third Floor Framing Plan-A Third Floor Framing Plan-B		•
S1-104a S1-104b	Roof Framing Plan-A Roof Framing Plan-B		•
S1-501 S2-103	Corridor Sections Typical Footing Details Typical Slab On Grade Details		•
S2-105 S2-106	Typical Slab On Grade Details Typical Slab On Grade Details Typical Foundation Wall Details		•
S2-108 S3-001	Typical Foundation Wall Details Reference Braced Frame Elevations And Notes		•
S3-100 S5-001 S5-100	Typical Braced Frame Connection Details Steel Column Schedule Typical Steel Column Details		•
65-100 65-101 65-200	Typical Steel Column Details         Typical Steel Column Details         Typical Steel Beam Details		•
55-200 55-201 55-202	Typical Steel Beam Details Typical Steel Beam Details Typical Steel Beam Details		•
65-202 65-300 65-301	Typical Composite Steel Deck Details Typical Composite Steel Deck Details		•
S5-302	Typical Composite Steel Deck Details		•


Sheet Number	Sheet Name	10/09/15 Demo & Enabling	11/04/15 DD Set
DE-F-01		•	_ <b></b>
DE-F-01 DE-F-11	FIRE PROTECTION LEVEL 1 DEMO	•	
DE-F-21 DE-F-31	FIRE PROTECTION LEVEL 1 PLAN FIRE PROTECTIO DETAILS	•	
F-001	Fire Protection Legend	•	•
F-101a	Fire Protection First Floor Plan - Wing A		•
F-101b F-101c	Fire Protection First Floor Plan - Wing B Fire Protection First Floor Plan - Wing C		•
F-102a	Fire Protection Second Floor Plan - Wing A		•
F-102b F-103a	Fire Protection Second Floor Plan - Wing B Fire Protection Third Floor Plan - Wing A		•
F-103b	Fire Protection Third Floor Plan - Wing A		•
F-104a	Fire Protection Roof Plan - Wing A		•
F-104b F-200	Fire Protection Roof - Wing B Fire Protection Riser		•
F-300	Fire Protection Details		•
8) Plumbing DE-P-01	PLUMBING LEGEND	•	
DE-P-11	PLUMBING LEVEL 1 DEMO PLAN	•	
DE-P-21 DE-P-31	PLUMBING LEVEL 1 PLAN PLUMBING DETAILS	•	
DE-P-31 DE-P-41	PLUMBING DETAILS PLUMBING SCHEDULES	•	
P-001	Plumbing Legend		•
P-101a P-101b	Plumbing First Floor Plan - Wing A Plumbing First Floor Plan - Wing B		•
P-101c	Plumbing First Floor Plan - Wing C		•
P-102a P-102b	Plumbing Second Floor Plan - Wing A Plumbing Second Floor Plan - Wing B		•
P-1026 P-103a	Plumbing Third Floor Plan - Wing A		•
P-103b	Plumbing Third Floor Plan - Wing B		•
P-104a P-104b	Plumbing Roof Plan - Wing A Plumbing Roof Plan - Wing B		•
P-200	Plumbing Water, San & Vent Riser Diagrams		•
P-201 9) Mechanical	Plumbing Storm Riser Diagram & Schedules		•
DE-M-01	MECHANICAL LEGEND & ABBREVIATIONS	•	
DE-M-02		•	
DE-M-11 DE-M-12	MECHANICAL DEMOLITION - LEVEL 1 MECHANICAL DEMOLITION - ROOF	•	
DE-M-21	MECHANICAL NEW WORK PLAN - LEVEL 1	•	
DE-M-22 DE-M-31	MECHANICAL NEW WORK PLAN - ROOF MECHANICAL DETAILS 1	•	
DE-M-32	MECHANICAL DETAILS 1	•	
DE-M-41		•	
DE-M-51 DE-M-52	MECHANICA CONTROL LEGEND 1 MECHANICAL CONTROL LEGEND 2	•	
DE-M-53	MECHANICAL GENERAL CONTROLS	•	
DE-M-54 M-001	HOT WATER PLANT CONTROLS Mechanical Legend And Abbreviations	•	•
M-002	Mechanical Schedules		•
M-101A	Mechanical 1st Floor Plan - Wing A		•
M-101B M-101C	Mechanical 1st Floor Plan - Wing B Mechanical 1st Floor Plan - Wing c		•
M-102A	Mechanical 2nd Floor Plan		•
M-102B M-103A	Mechanical 2nd Floor Plan - Wing B Mechanical 3rd Floor Plan - Wing A		•
M-103A M-103B	Mechanical 3rd Floor Plan - Wing B		•
M-104A	Mechanical Roof Plan - Wing A		•
M-104B M-200	Mechanical Roof Plan - Wing B Mechanical Details 1		•
M-201	Mechanical Details 2		•
M-300 M-301	Mechanical Controls Legend Mechanical Controls RTU-1 & RTU-2		•
M-302	Mechanical Controls RTU-3		•
M-303 10) Electrical	Mechanical General Controls		•
DE-E-01	ELECTRICAL LEGEND & ABBREVIATIONS	•	
DE-E-02	ELECTRICAL NOTES	•	
DE-E-03 DE-E-04	ELECTRICAL SPECIFICATIONS ELECTRICAL SPECIFICATIONS	•	
DE-E-10	ELECTRICAL EXISTING LEVEL 1	•	
DE-E-20 DE-E-21	ELECTRICAL LEVEL 1 POWER & LIGHTING ELECTRICAL ROOF POWER AND LIGHTING	•	
DE-E-22	ELECTRICAL LEVEL 1 FIRE ALARM	•	
DE-E-40	ELECTRICAL SCHEDULES & DETAILS	•	
E-001 E-002	Electrical Legend And Notes Electrical Notes		•
E-003	Electrical Site Plan		•
E-101a E-101b	Electrical Level 1 Power Plan - A Electrical Level 1 Power Plan - B		•
E-101c	Electrical Level 1 Power Plan - C		•
E-102a E-102b	Electrical Level 2 Power Plan - A Electrical Level 2 Power Plan - B		•
E-103a	Electrical Level 3 Power Plan - A		•
E-103b E-104a	Electrical Level 3 Power Plan - B		•
E-104a E-104b	Electrical Roof Power Plan - A Electrical Roof Power Plan - B		•
E-105	Electrical Roof Power Plan		•
E-201a E-201b	Electrical Level 1 Lighting Plan - A Electrical Level 1 Lighting Plan - B		•
E-201c	Electrical Level 1 Lighting Plan - C		•
E-202a	Electrical Level 2 Lighting Plan - A		•
E-202b E-203a	Electrical Level 2 Lighting Plan - B Electrical Level 3 Lighting Plan - A		•
E-203b	Electrical Level 3 Lighting Plan - B		•
E-301a E-301b	Electrical Level 1 Fire Alarm Plan - A Electrical Level 1 Fire Alarm Plan - B		•
E-3010 E-301c	Electrical Level 1 Fire Alarm Plan - C		•
E-302a E-302b	Electrical Level 2 Fire Alarm Plan - A		•
E-302b E-303a	Electrical Level 2 Fire Alarm Plan - B Electrical Level 3 Fire Alarm Plan - A		•
E-303b	Electrical Level 3 Fire Alarm Plan - B		•
E-400	Electrical Schedules		•

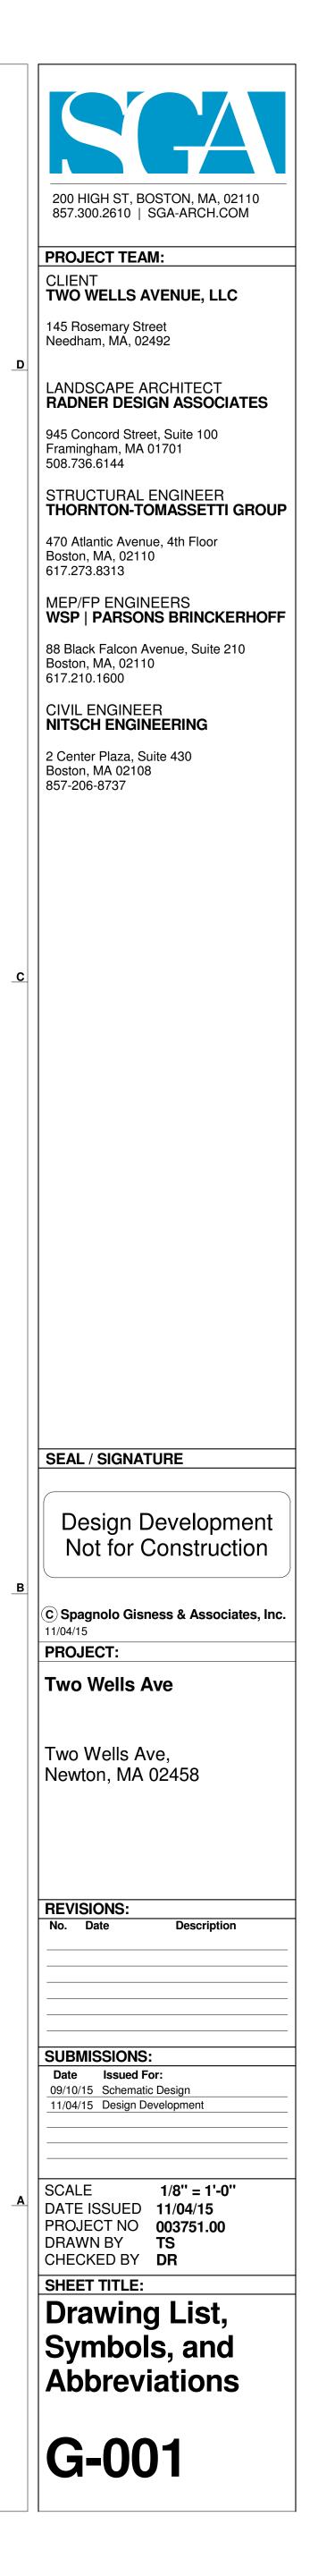

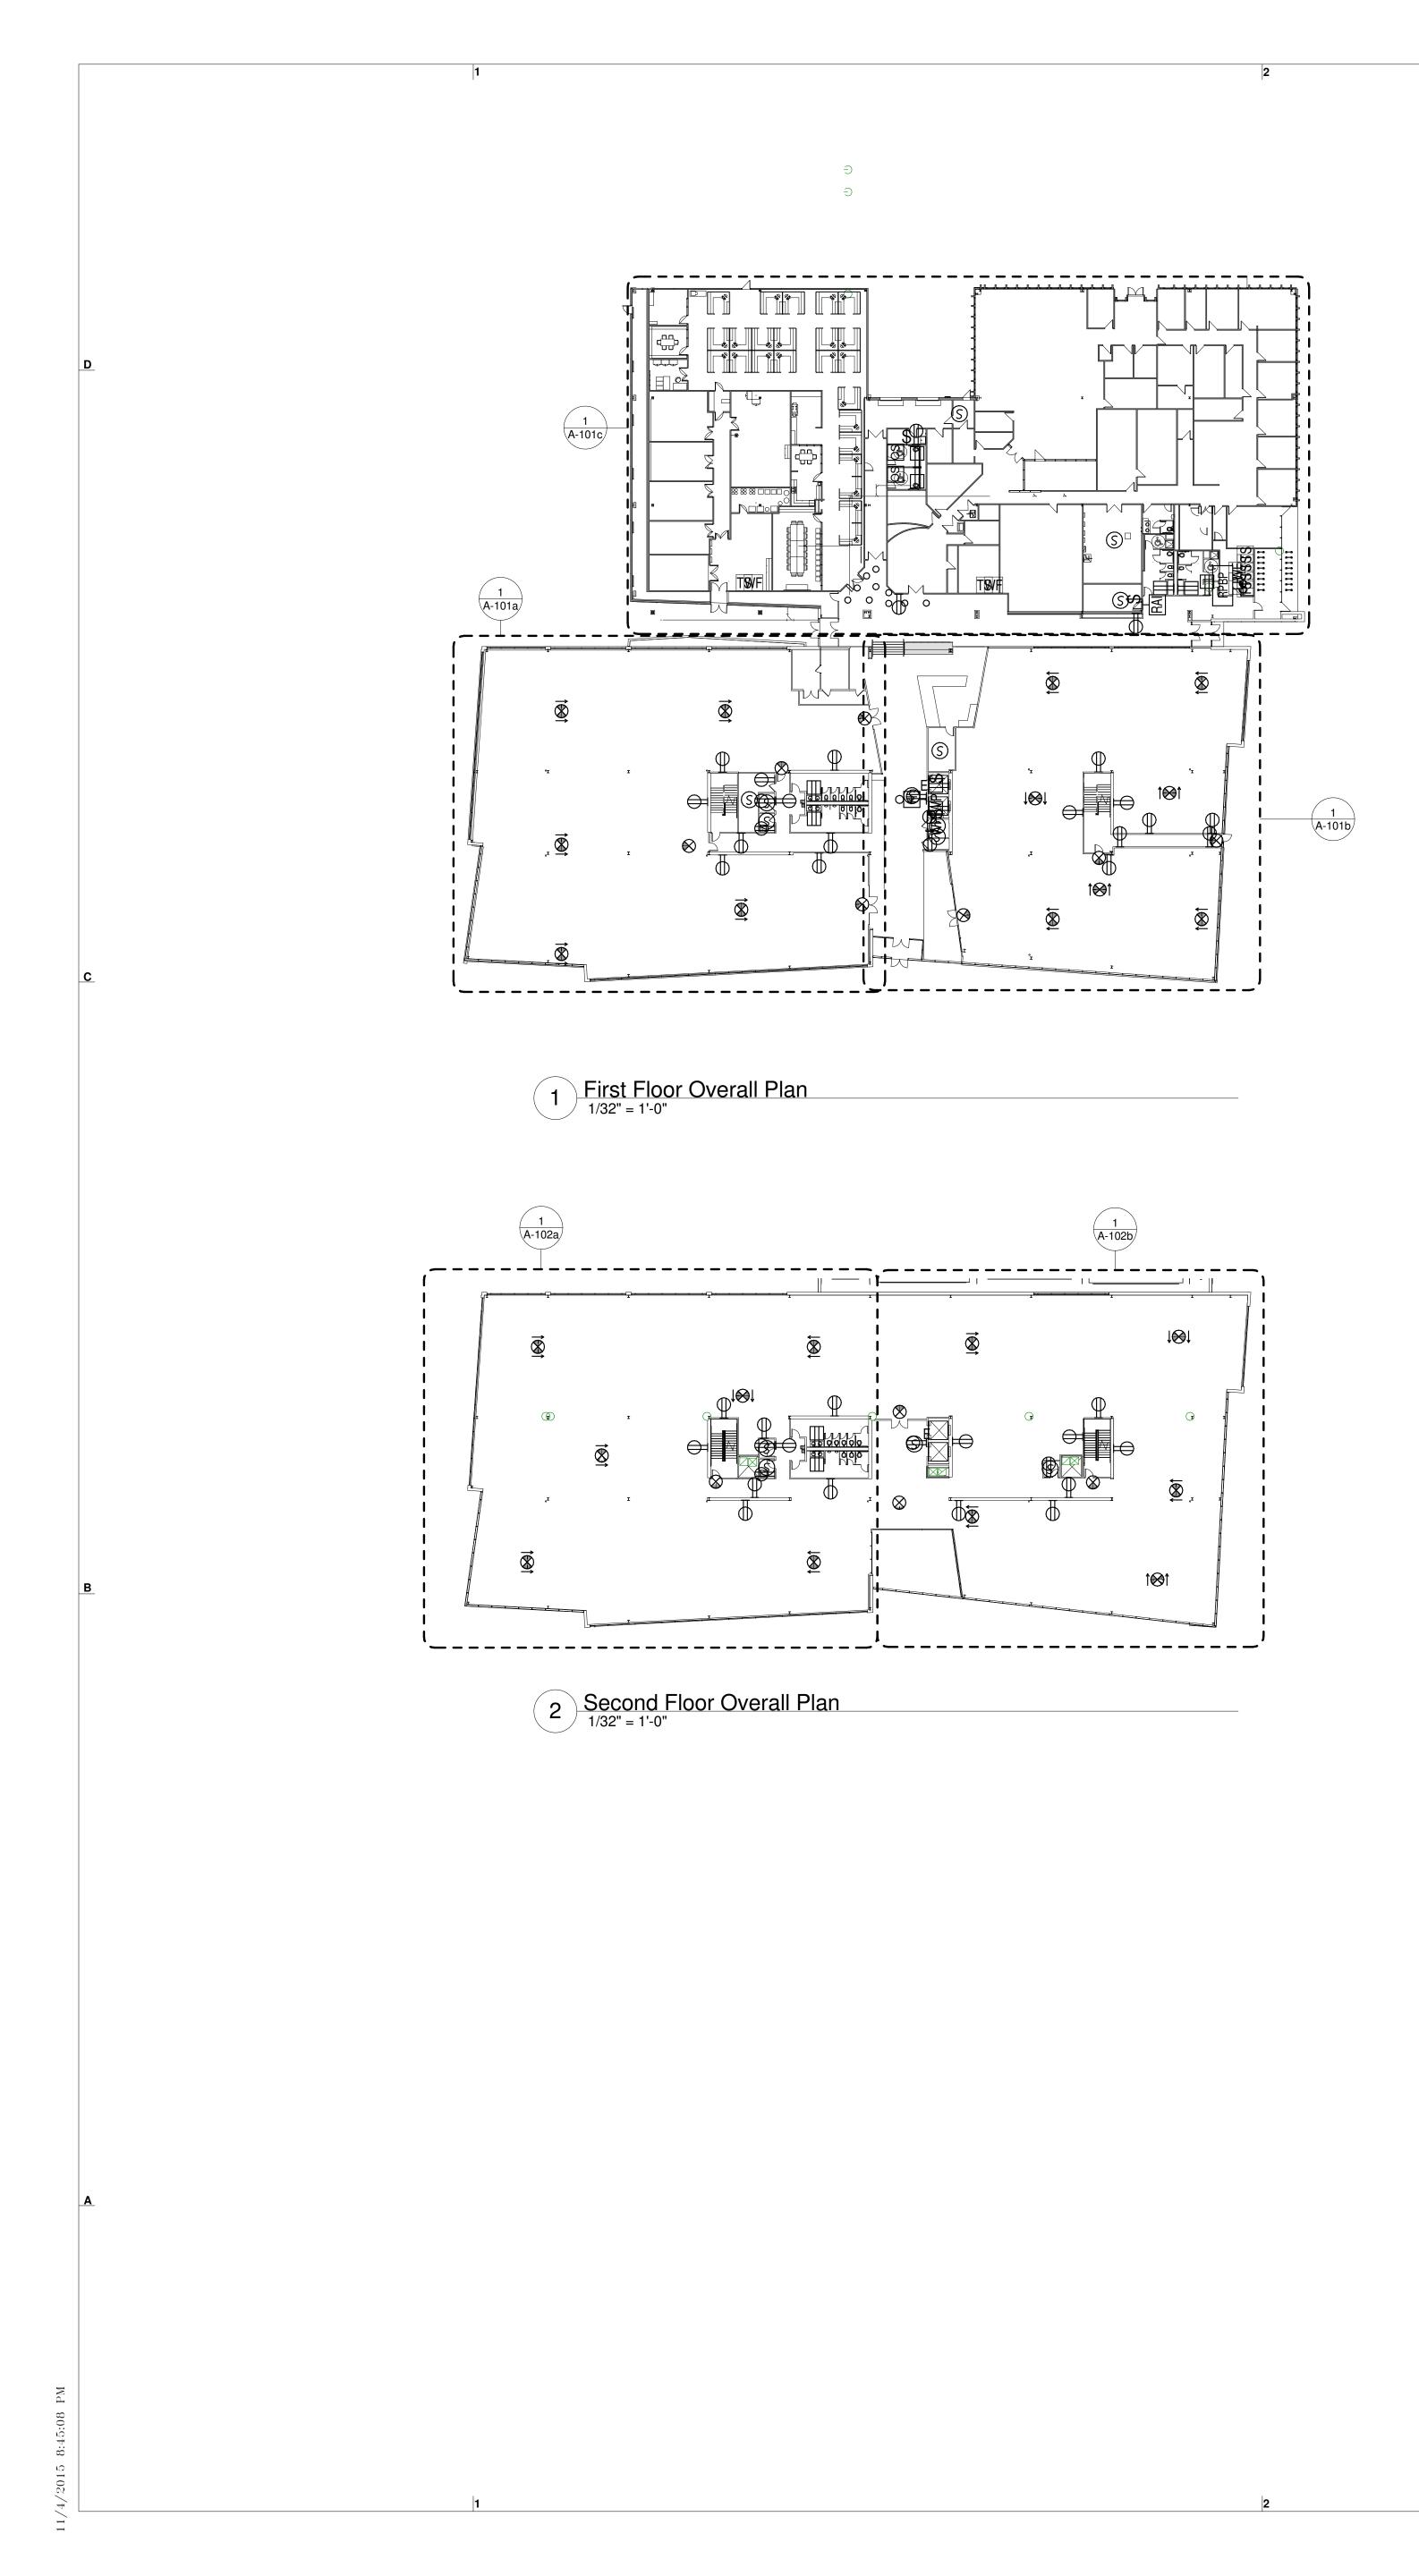

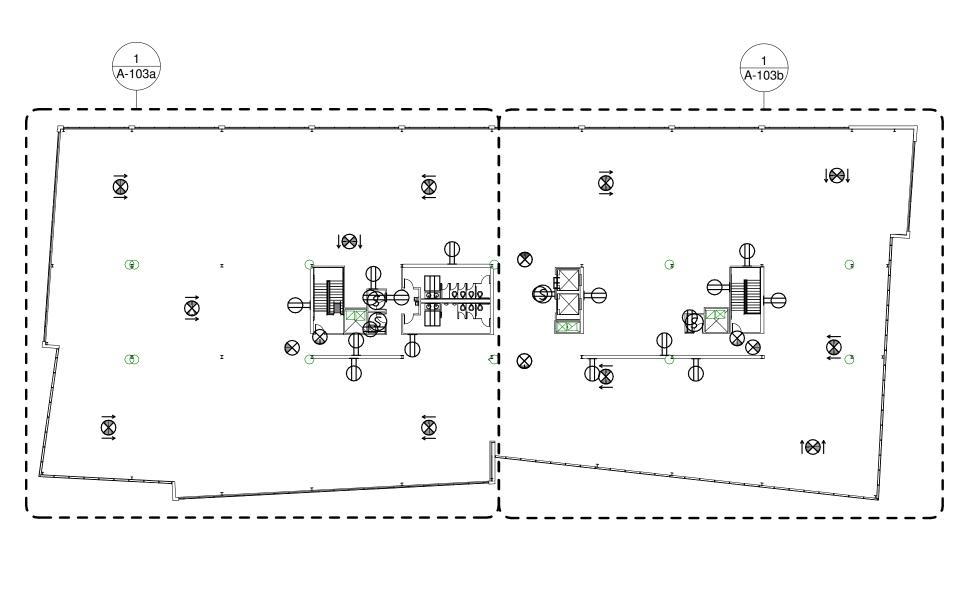



3 Third Floor Overall Plan 1/32" = 1'-0"

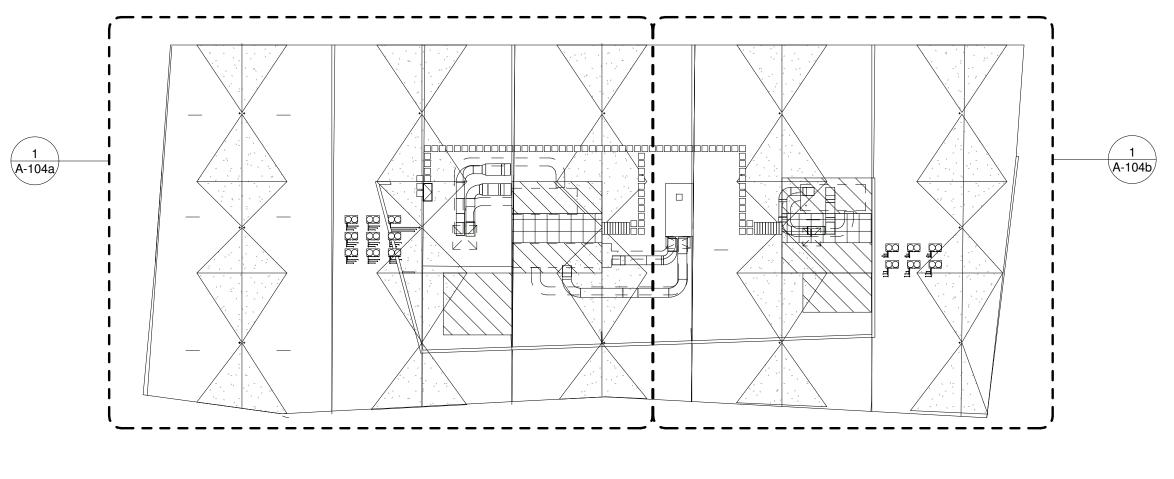

4 Roof Plan Overall Plan 1/32" = 1'-0"




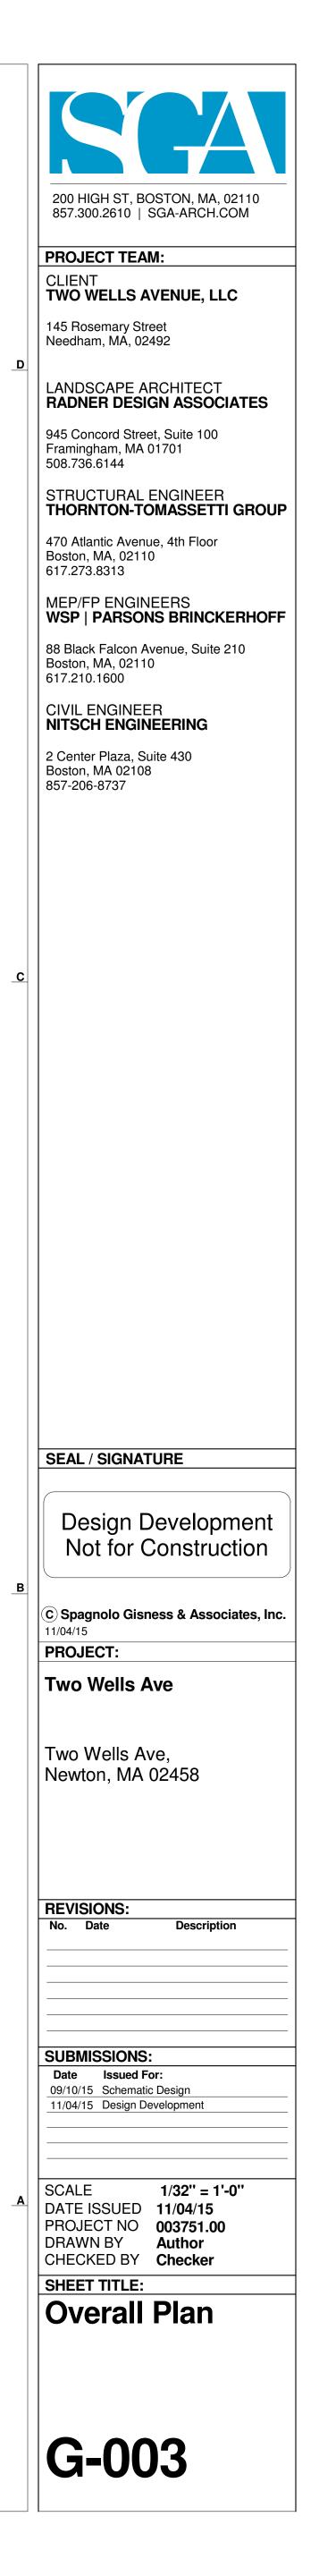


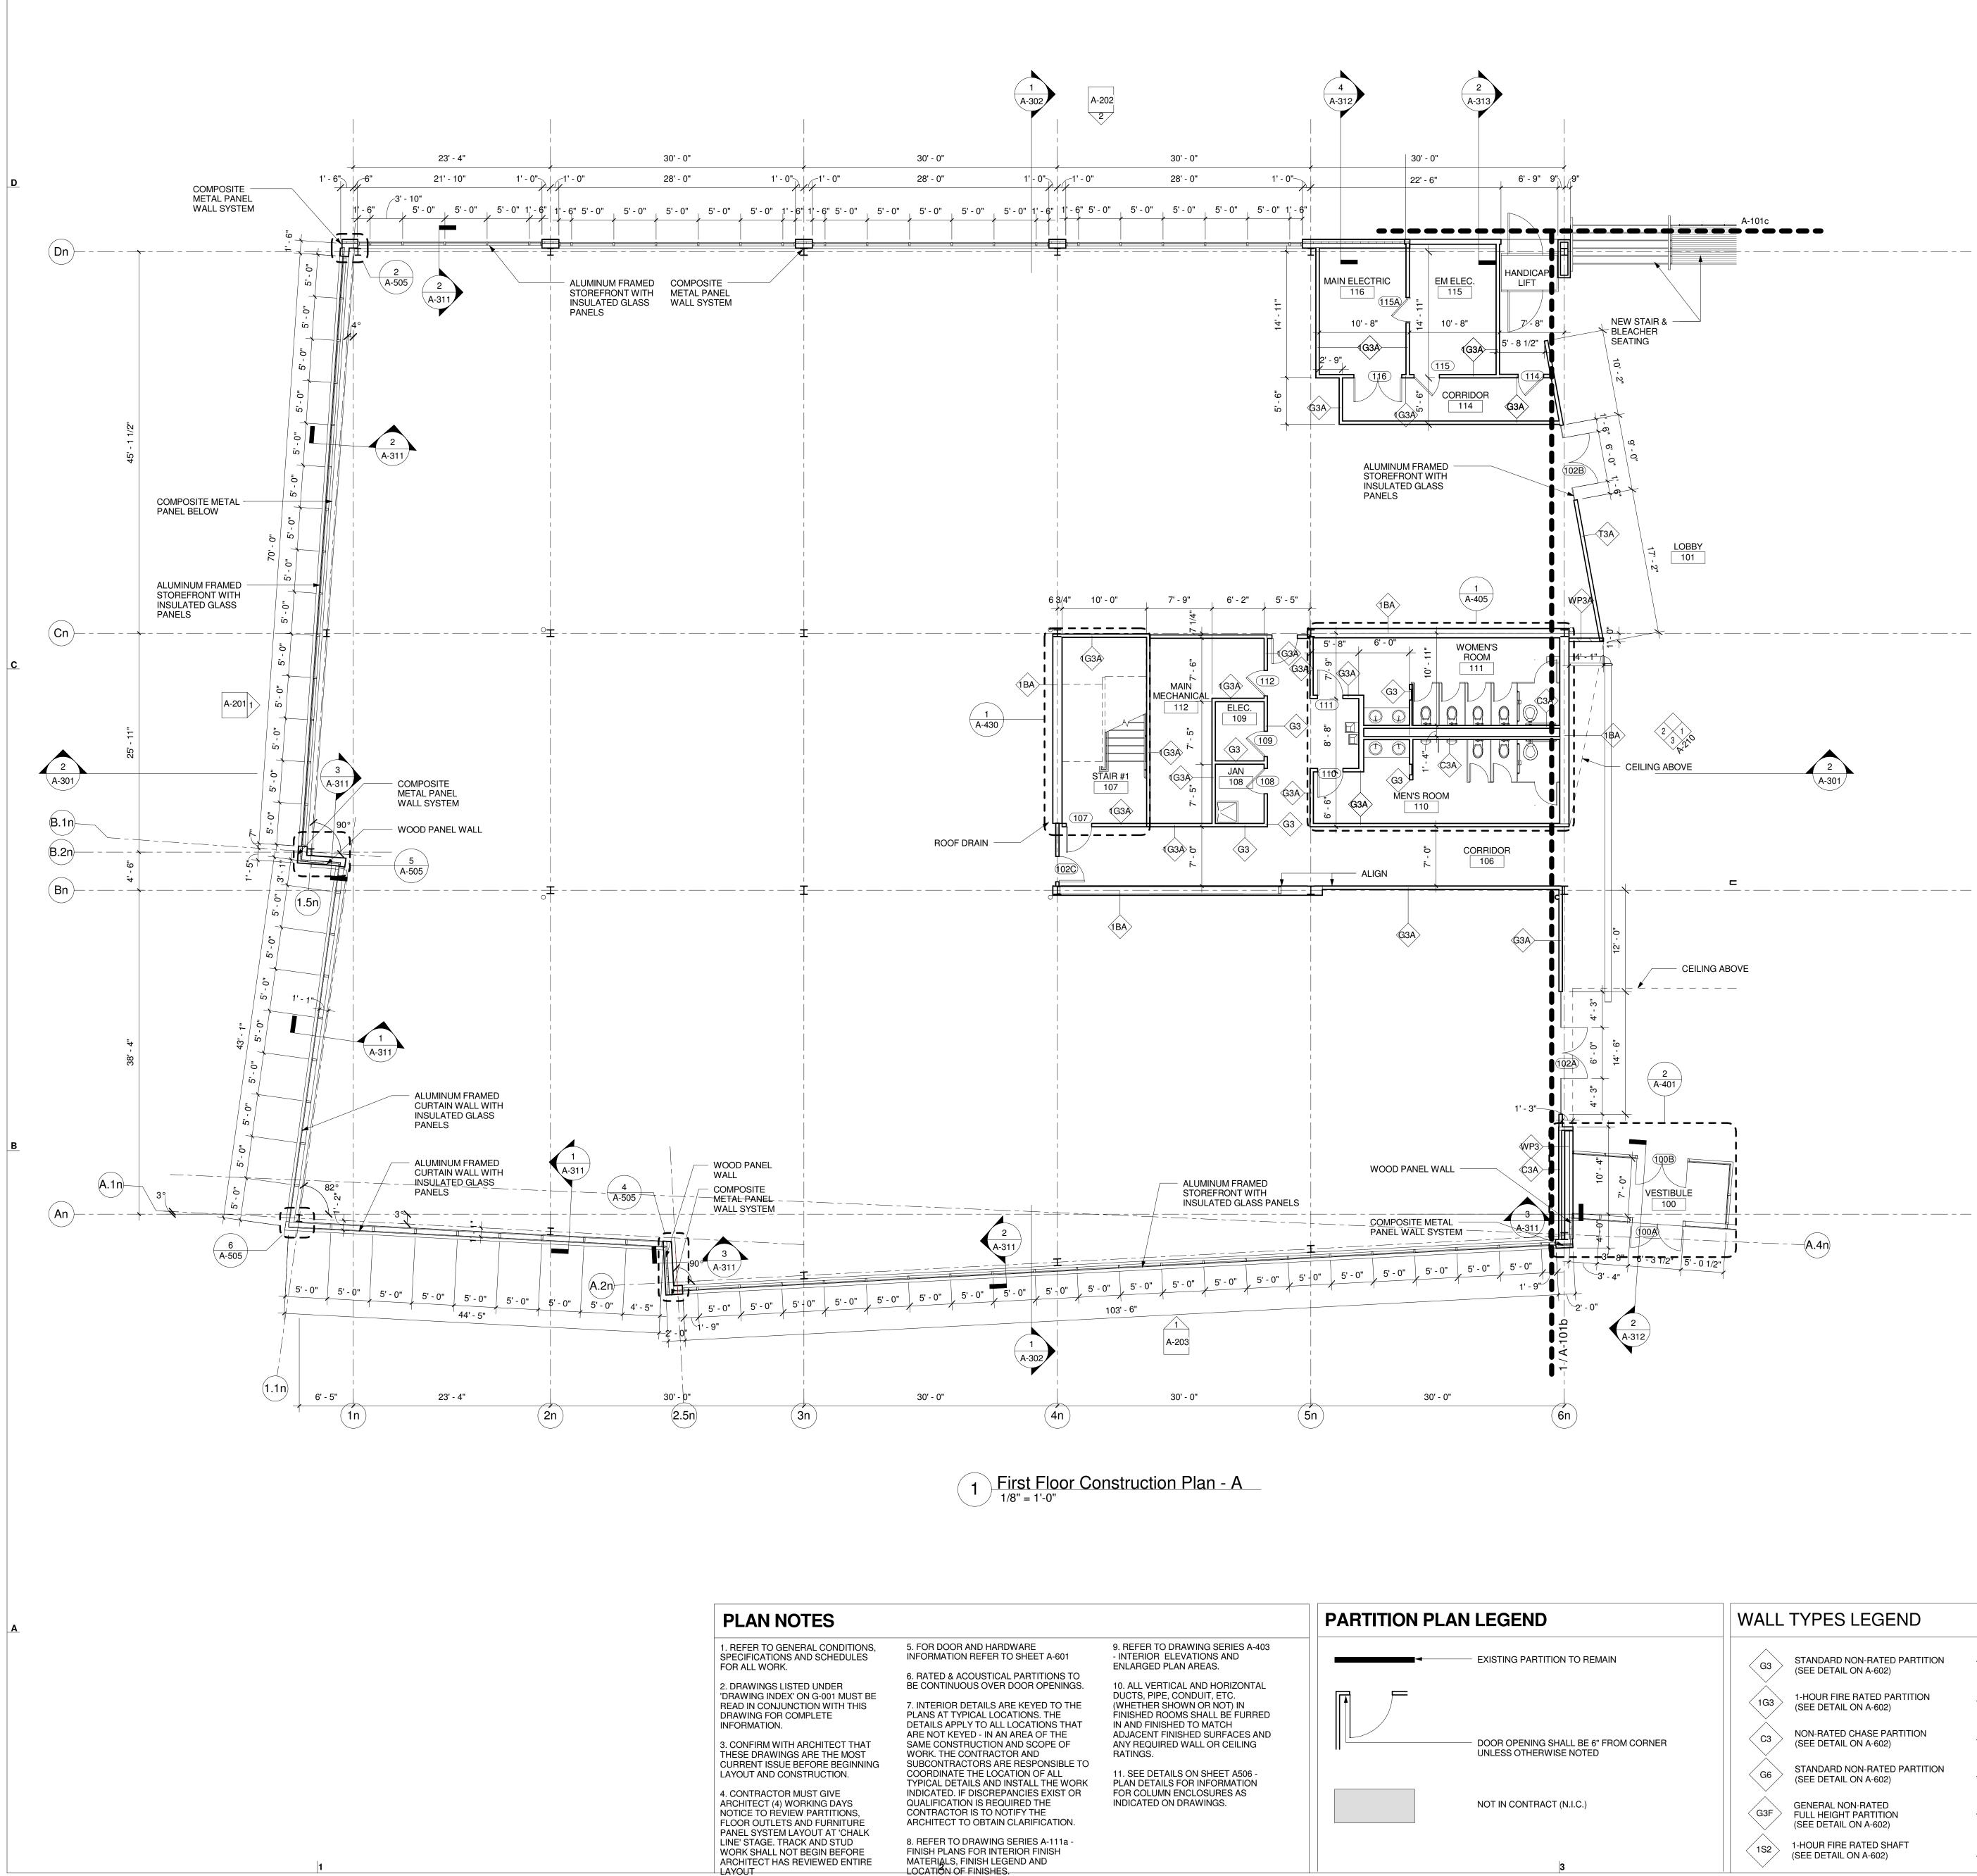

ARIIION PLAN LEGEND								
<	- EXISTING PARTITION TO REM							
	- DOOR OPENING SHALL BE 6" UNLESS OTHERWISE NOTED							


	WALL TYPES LEGEND	
N		USTIC NON-RATED PARTITION DETAIL ON A-602)
	$\langle 1G3 \rangle$ 1-HOUR FIRE RATED PARTITION $\langle 1G3A \rangle$ ACO	DUR FIRE RATED USTIC PARTITION E DETAIL ON A-602)
OM CORNER		USTIC NON-RATED CHASE WALL E DETAIL ON A-602)
		USTIC NON-RATED PARTITION DETAIL ON A-602)
	G3F FULL HEIGHT PARTITION	DUR FIRE RATED BRACE BEAM FT ENCLOSURE PARTITION E DETAIL ON A-602)
	(SEE DETAIL ON A-602) (SEE DETAIL ON A-602)	DUR FIRE RATED ACOUSTICAL CE BEAM ENCLOSURE PARTITION E DETAIL ON A-602) 4 0 4 8 12 16 24 32 48 (ft)

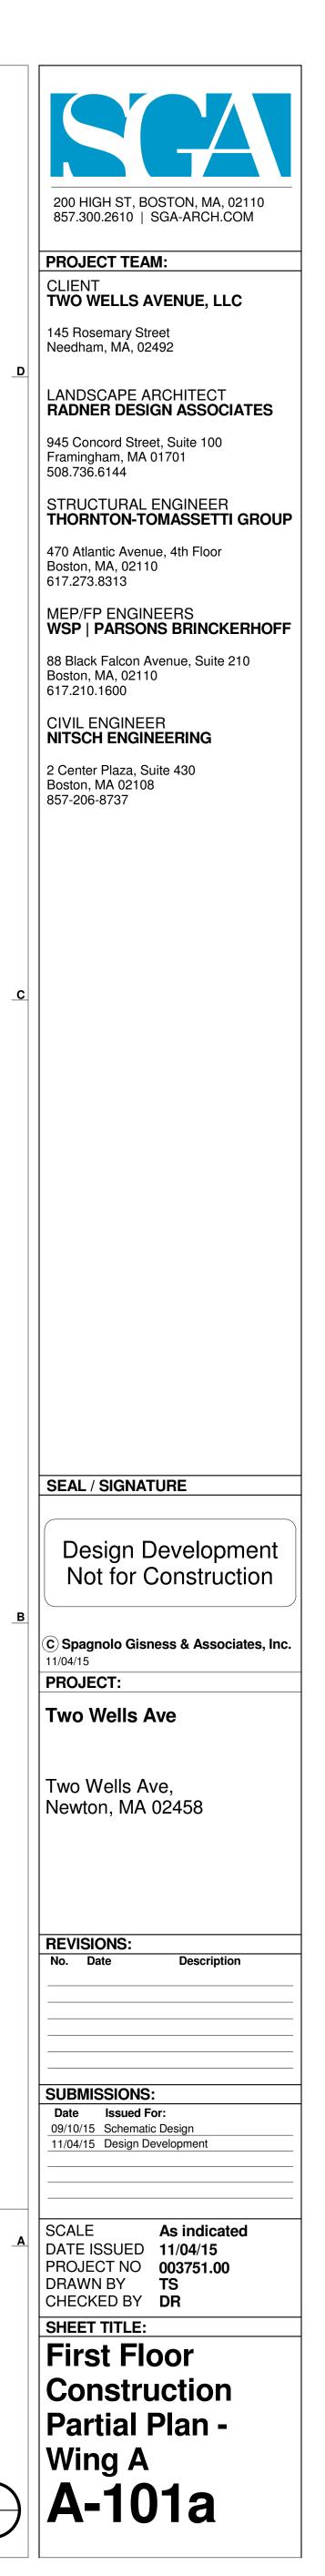


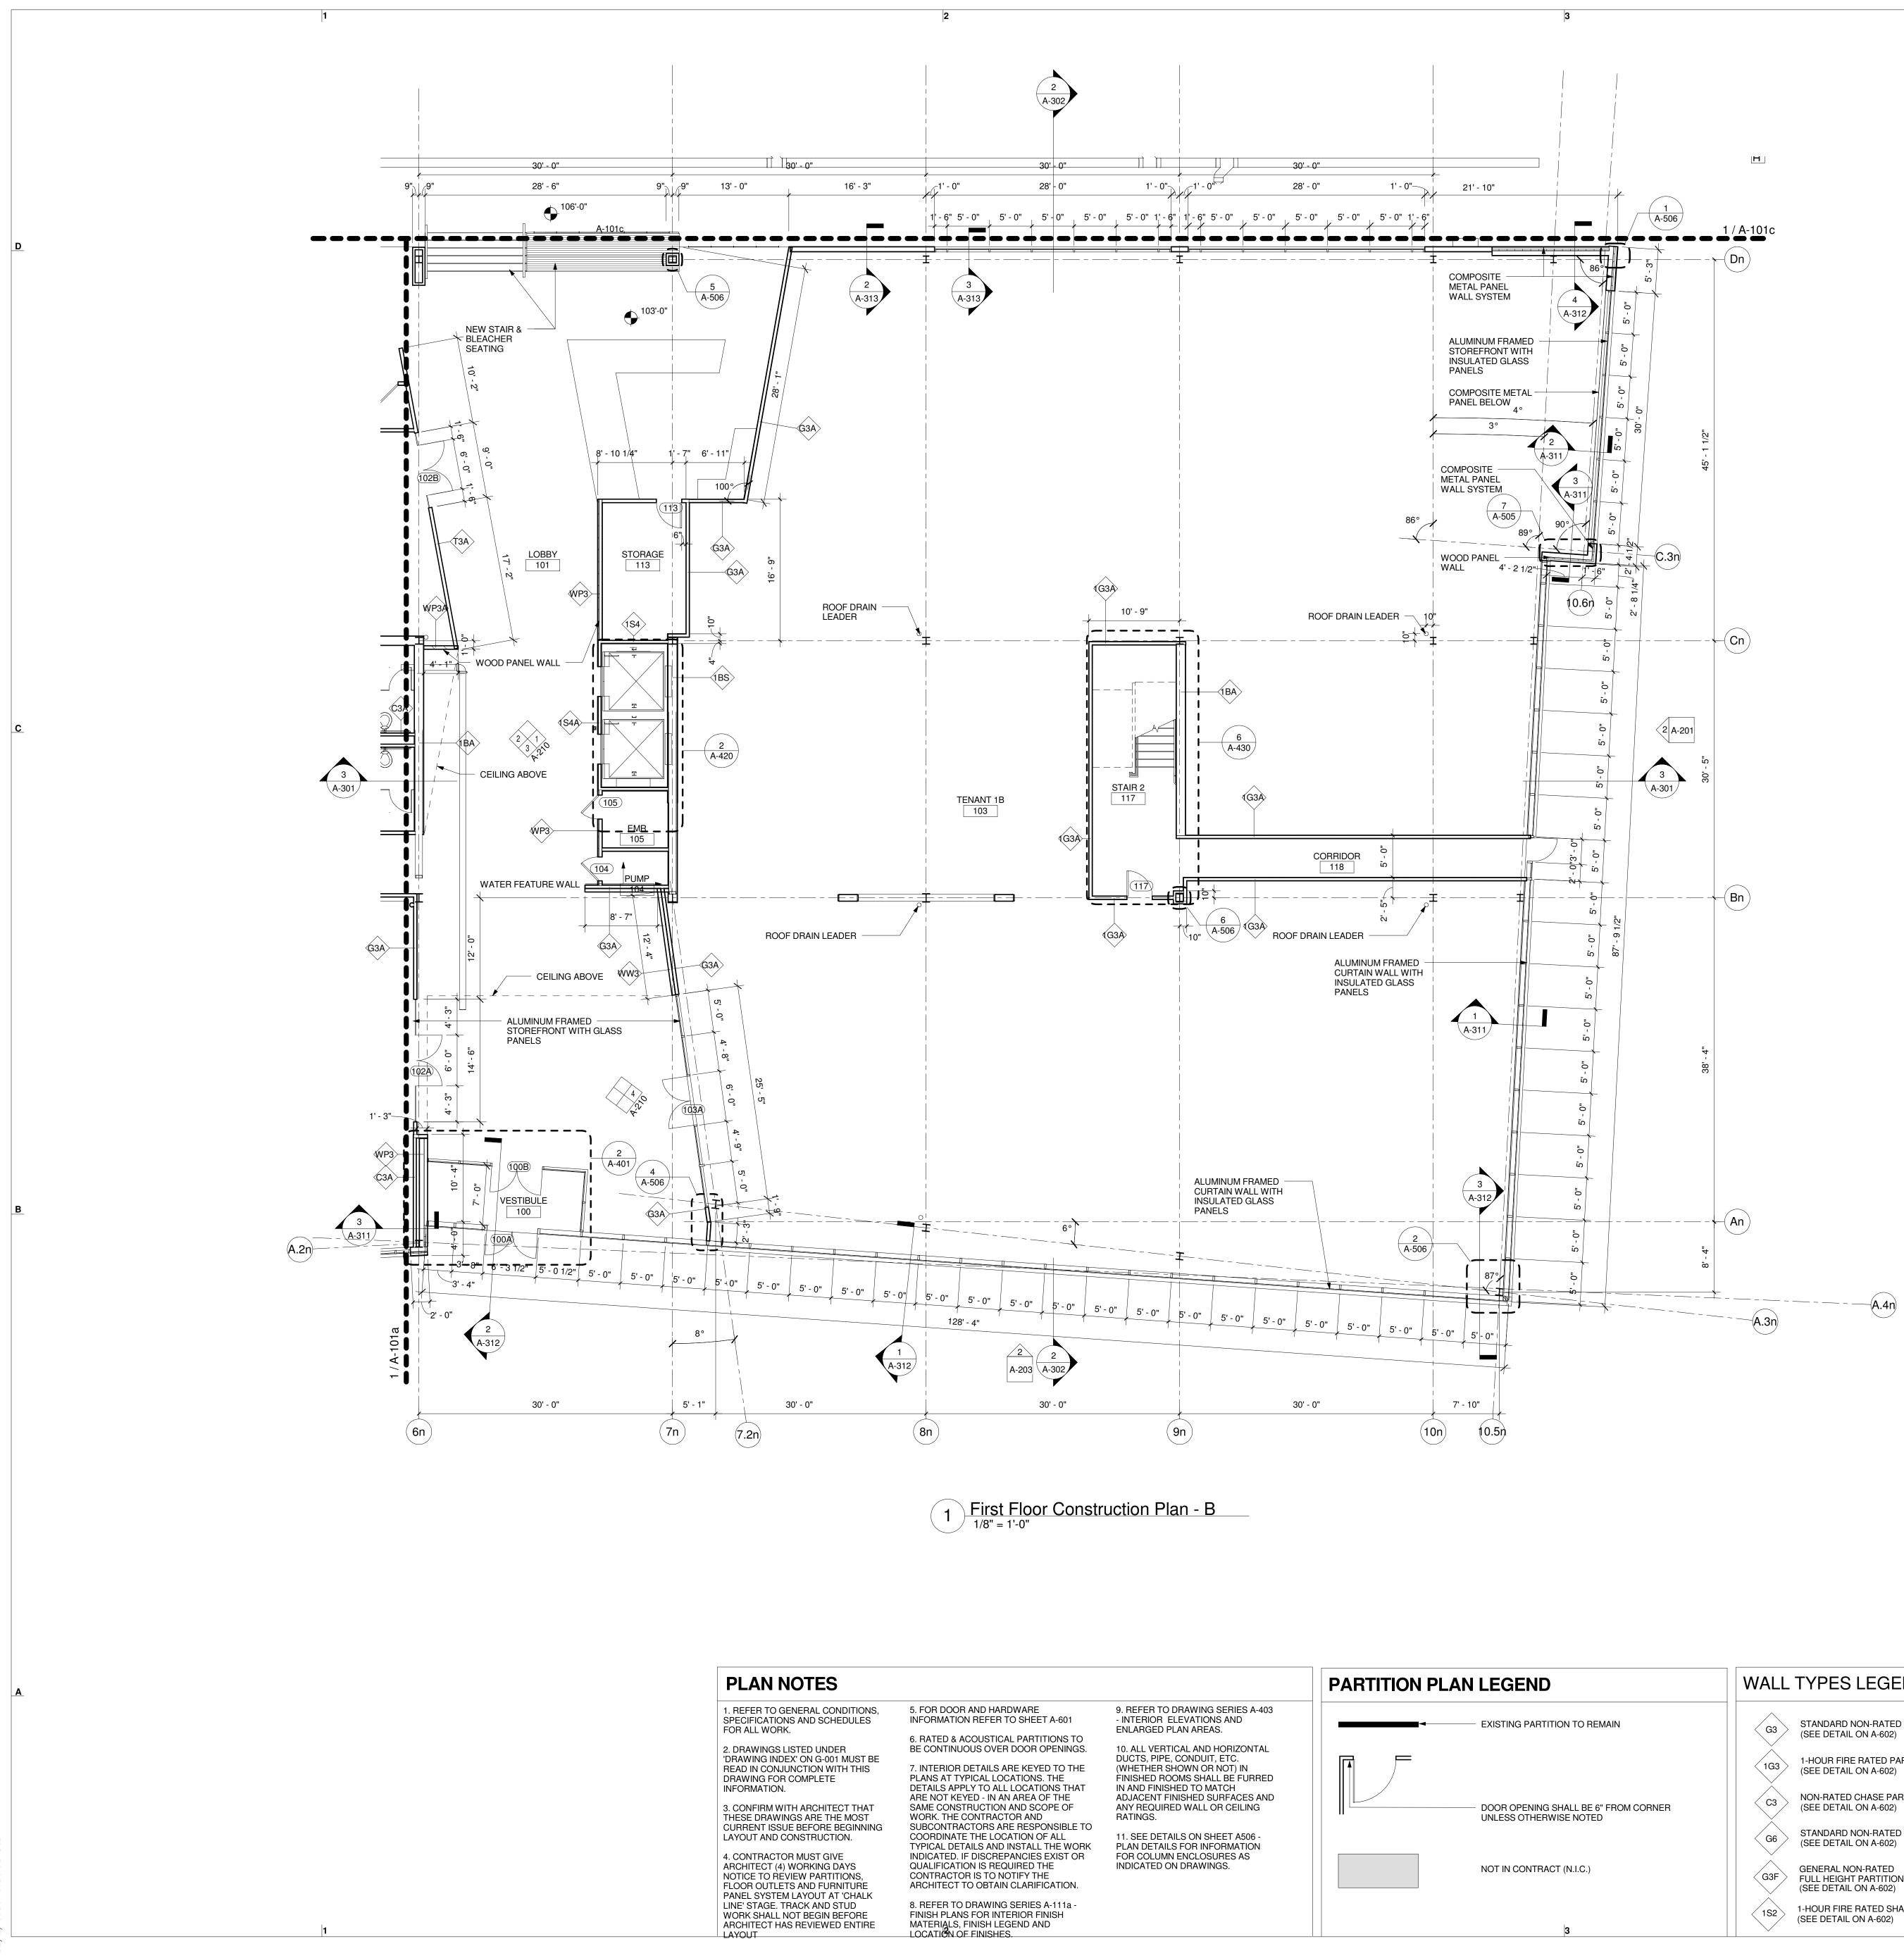



N NOTES			PARTITION PLAN LEGEND					
TO GENERAL CONDITIONS, ATIONS AND SCHEDULES WORK. NGS LISTED UNDER A INDEX' ON G-001 MUST BE CONJUNCTION WITH THIS FOR COMPLETE TION. MWITH ARCHITECT THAT RAWINGS ARE THE MOST ISSUE BEFORE BEGINNING AND CONSTRUCTION. ACTOR MUST GIVE CT (4) WORKING DAYS O REVIEW PARTITIONS, UTLETS AND FURNITURE STEM LAYOUT AT 'CHALK GE. TRACK AND STUD IALL NOT BEGIN BEFORE	<ul> <li>5. FOR DOOR AND HARDWARE INFORMATION REFER TO SHEET A-601</li> <li>6. RATED &amp; ACOUSTICAL PARTITIONS TO BE CONTINUOUS OVER DOOR OPENINGS.</li> <li>7. INTERIOR DETAILS ARE KEYED TO THE PLANS AT TYPICAL LOCATIONS. THE DETAILS APPLY TO ALL LOCATIONS THAT ARE NOT KEYED - IN AN AREA OF THE SAME CONSTRUCTION AND SCOPE OF WORK. THE CONTRACTOR AND SUBCONTRACTORS ARE RESPONSIBLE TO COORDINATE THE LOCATION OF ALL TYPICAL DETAILS AND INSTALL THE WORK INDICATED. IF DISCREPANCIES EXIST OR QUALIFICATION IS REQUIRED THE CONTRACTOR IS TO NOTIFY THE ARCHITECT TO OBTAIN CLARIFICATION.</li> <li>8. REFER TO DRAWING SERIES A-111a - FINISH PLANS FOR INTERIOR FINISH</li> </ul>	<ul> <li>9. REFER TO DRAWING SERIES A-403</li> <li>- INTERIOR ELEVATIONS AND ENLARGED PLAN AREAS.</li> <li>10. ALL VERTICAL AND HORIZONTAL DUCTS, PIPE, CONDUIT, ETC.</li> <li>(WHETHER SHOWN OR NOT) IN FINISHED ROOMS SHALL BE FURRED IN AND FINISHED TO MATCH ADJACENT FINISHED SURFACES AND ANY REQUIRED WALL OR CEILING RATINGS.</li> <li>11. SEE DETAILS ON SHEET A506 - PLAN DETAILS FOR INFORMATION FOR COLUMN ENCLOSURES AS INDICATED ON DRAWINGS.</li> </ul>		EXISTING PARTITION TO REMA				
CT HAS REVIEWED ENTIRE	MATERIALS, FINISH LEGEND AND LOCATION OF FINISHES.			3				


WALL TYPES LEGEND									
G3 STANDARD NON-RATED PARTITION (SEE DETAIL ON A-602)	G3A	ACOUSTIC NON-RATED PARTITION (SEE DETAIL ON A-602)					С		
1G3 1-HOUR FIRE RATED PARTITION (SEE DETAIL ON A-602)	1G3A	1-HOUR FIRE RATED ACOUSTIC PARTITION (SEE DETAIL ON A-602)							
C3 NON-RATED CHASE PARTITION (SEE DETAIL ON A-602)	C3A	ACOUSTIC NON-RATED CHASE WALL (SEE DETAIL ON A-602)			A			в	
G6 STANDARD NON-RATED PARTITION (SEE DETAIL ON A-602)	G6A	ACOUSTIC NON-RATED PARTITION (SEE DETAIL ON A-602)			7				
G3F GENERAL NON-RATED FULL HEIGHT PARTITION (SEE DETAIL ON A-602)	1BSA	1-HOUR FIRE RATED BRACE BEAM SHAFT ENCLOSURE PARTITION (SEE DETAIL ON A-602)							T
1S2 1-HOUR FIRE RATED SHAFT (SEE DETAIL ON A-602)	1BA	1-HOUR FIRE RATED ACOUSTICAL BRACE BEAM ENCLOSURE PARTITION (SEE DETAIL ON A-602) 4	0 4	8	12 16	24	32	48 (ft)	J

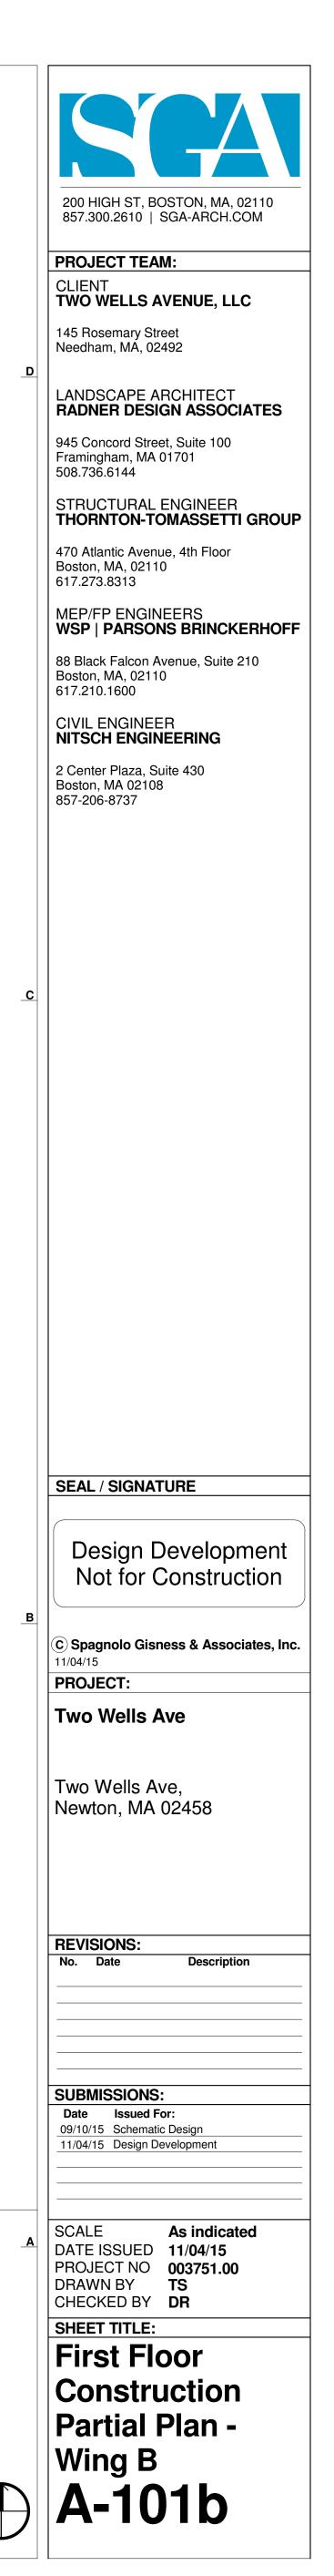


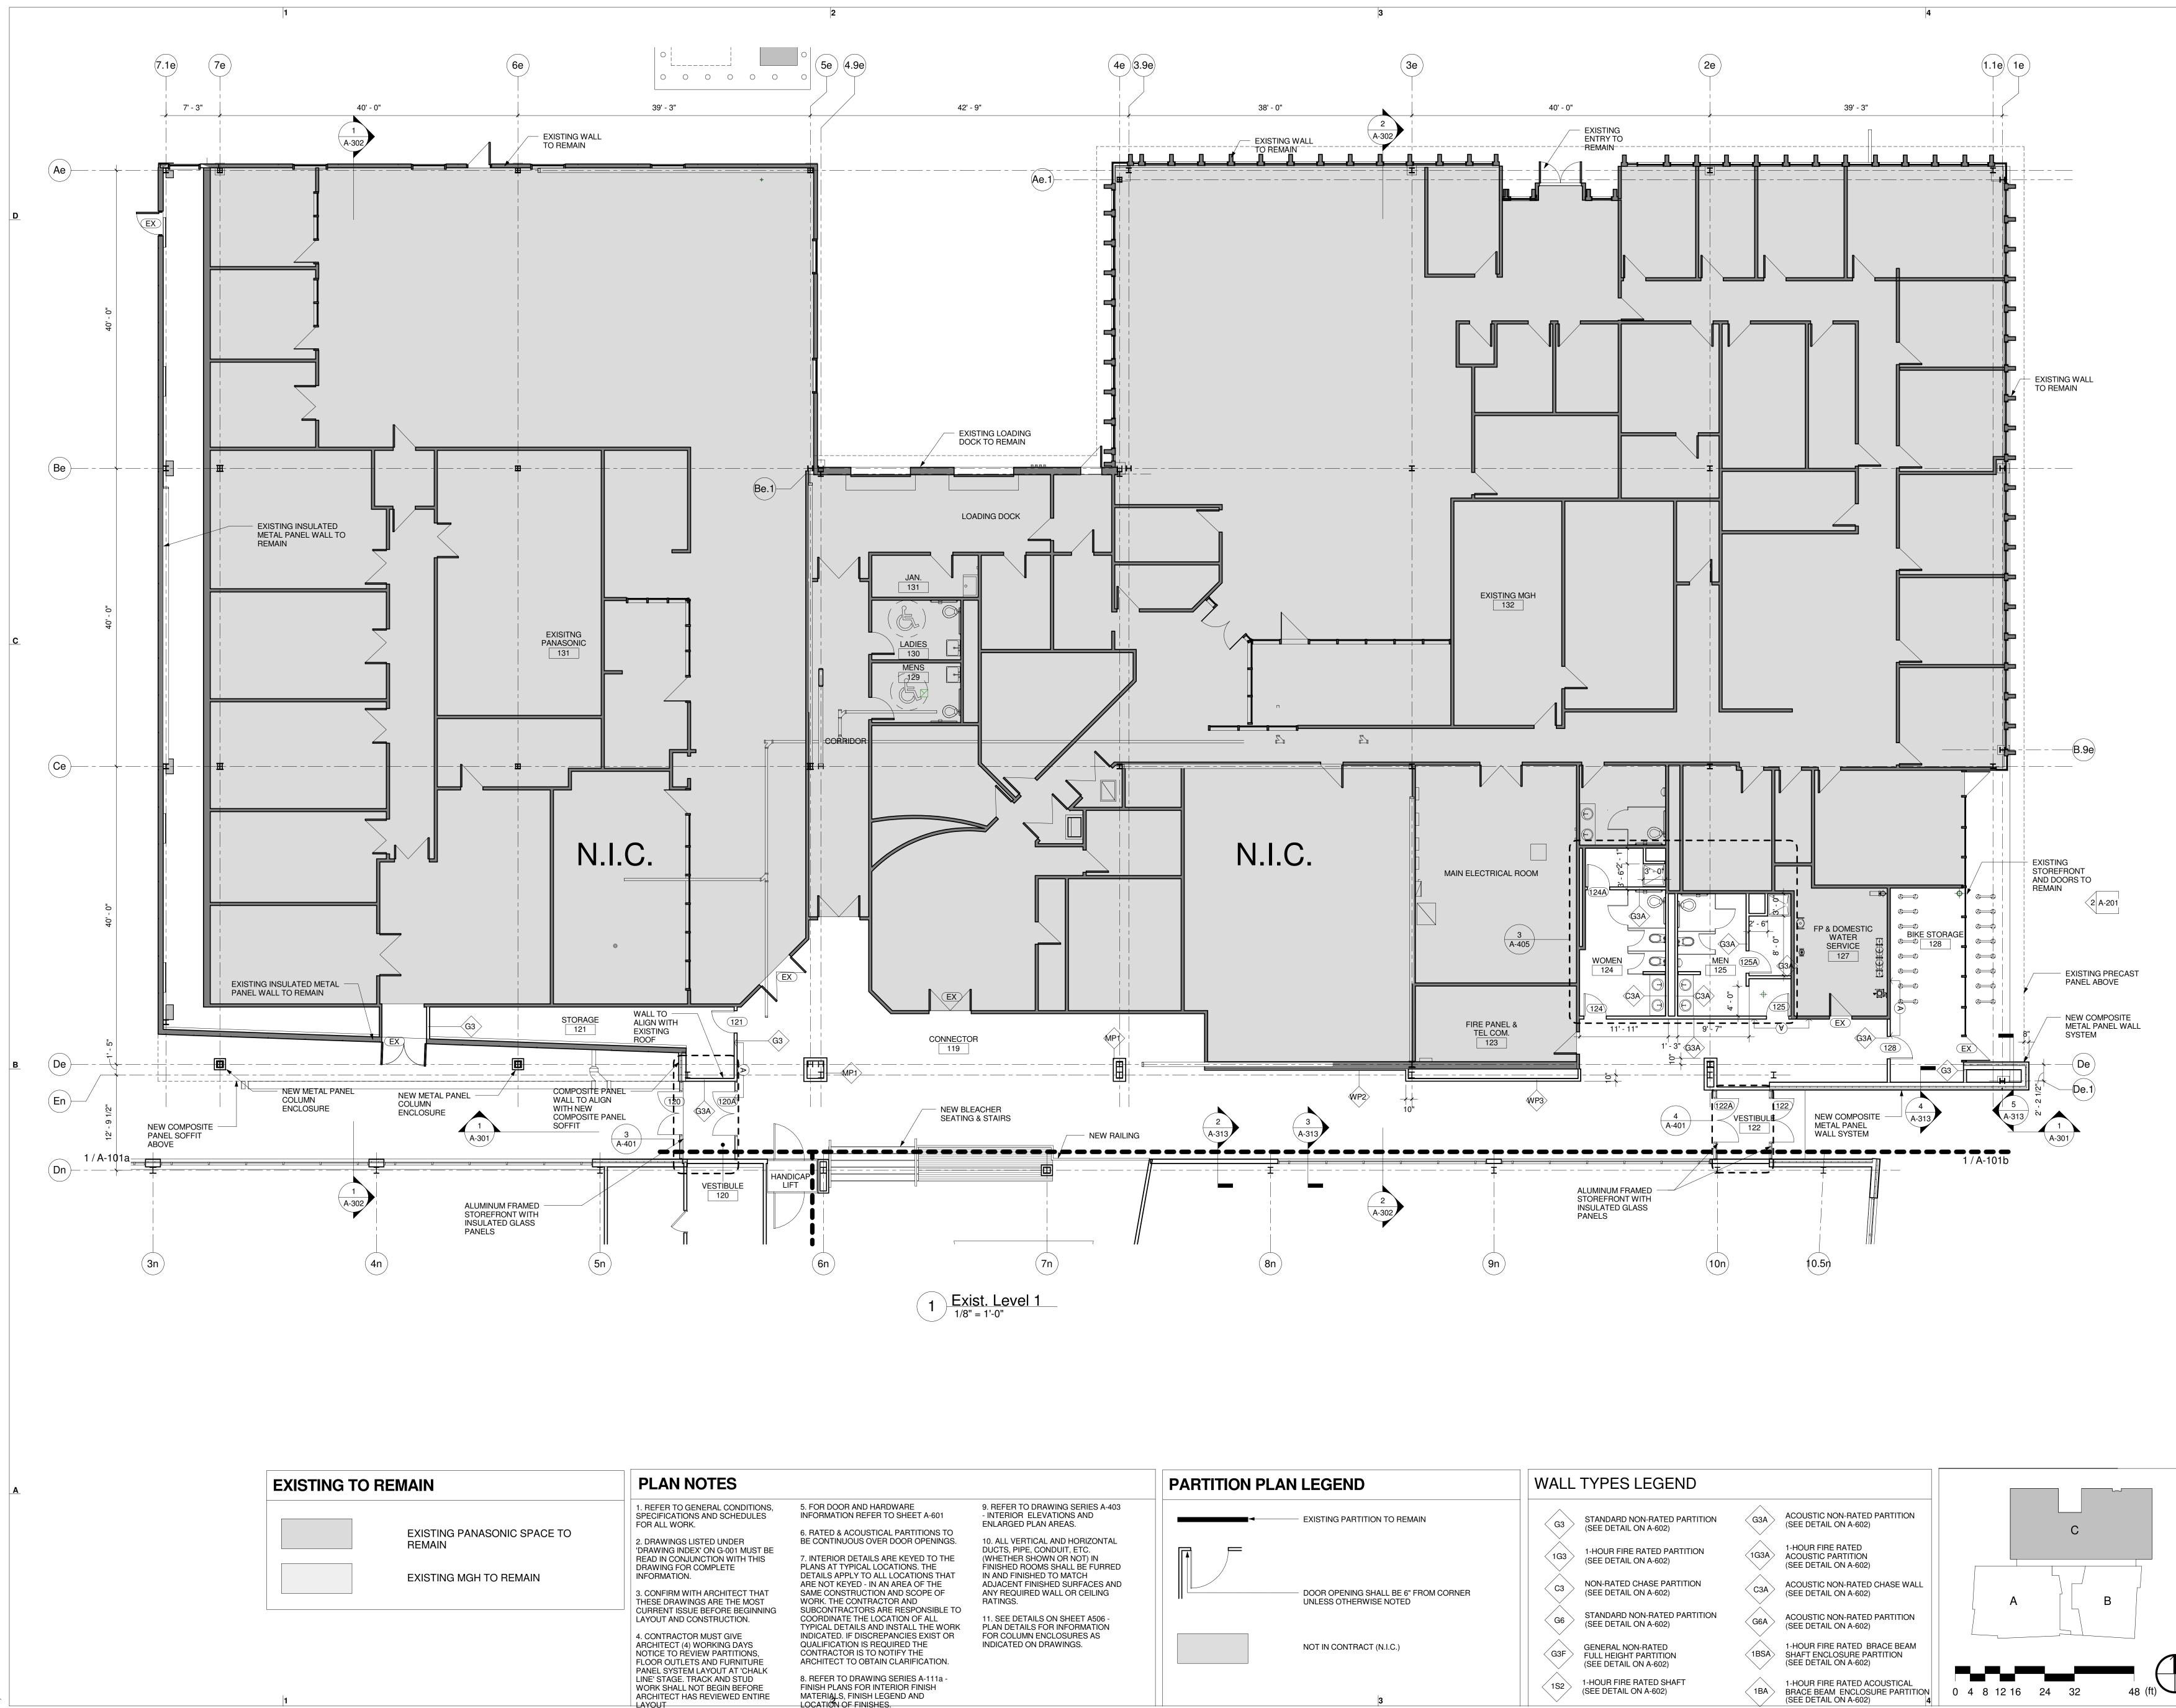

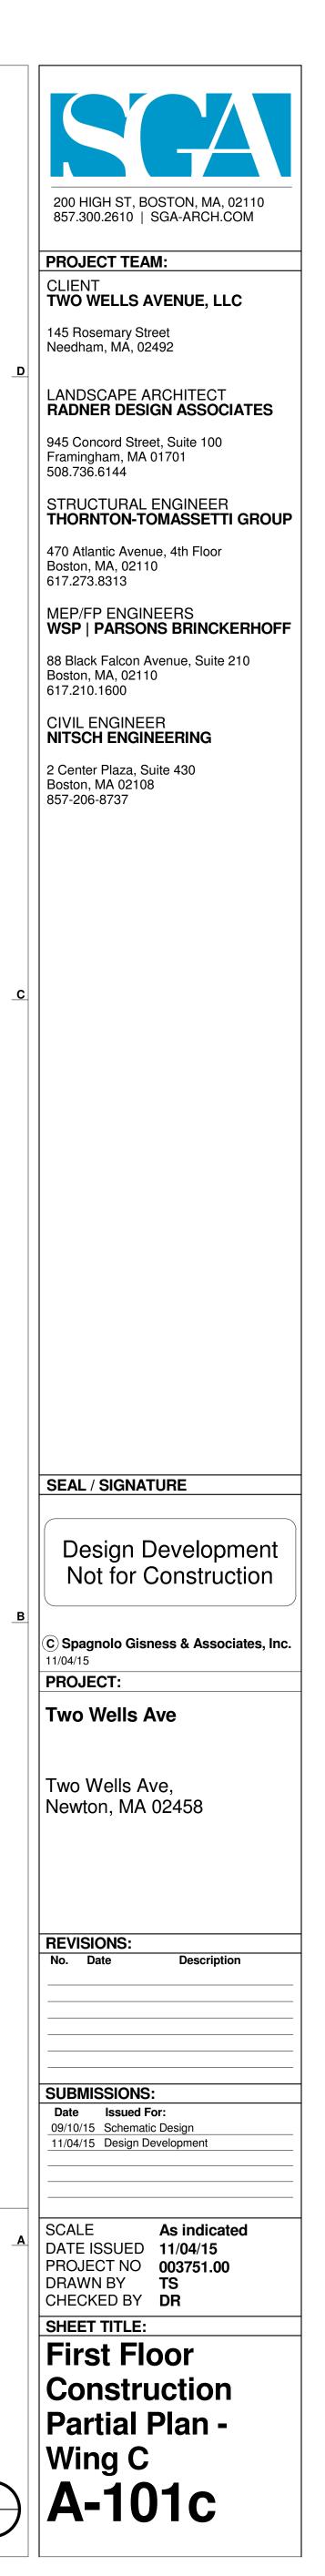

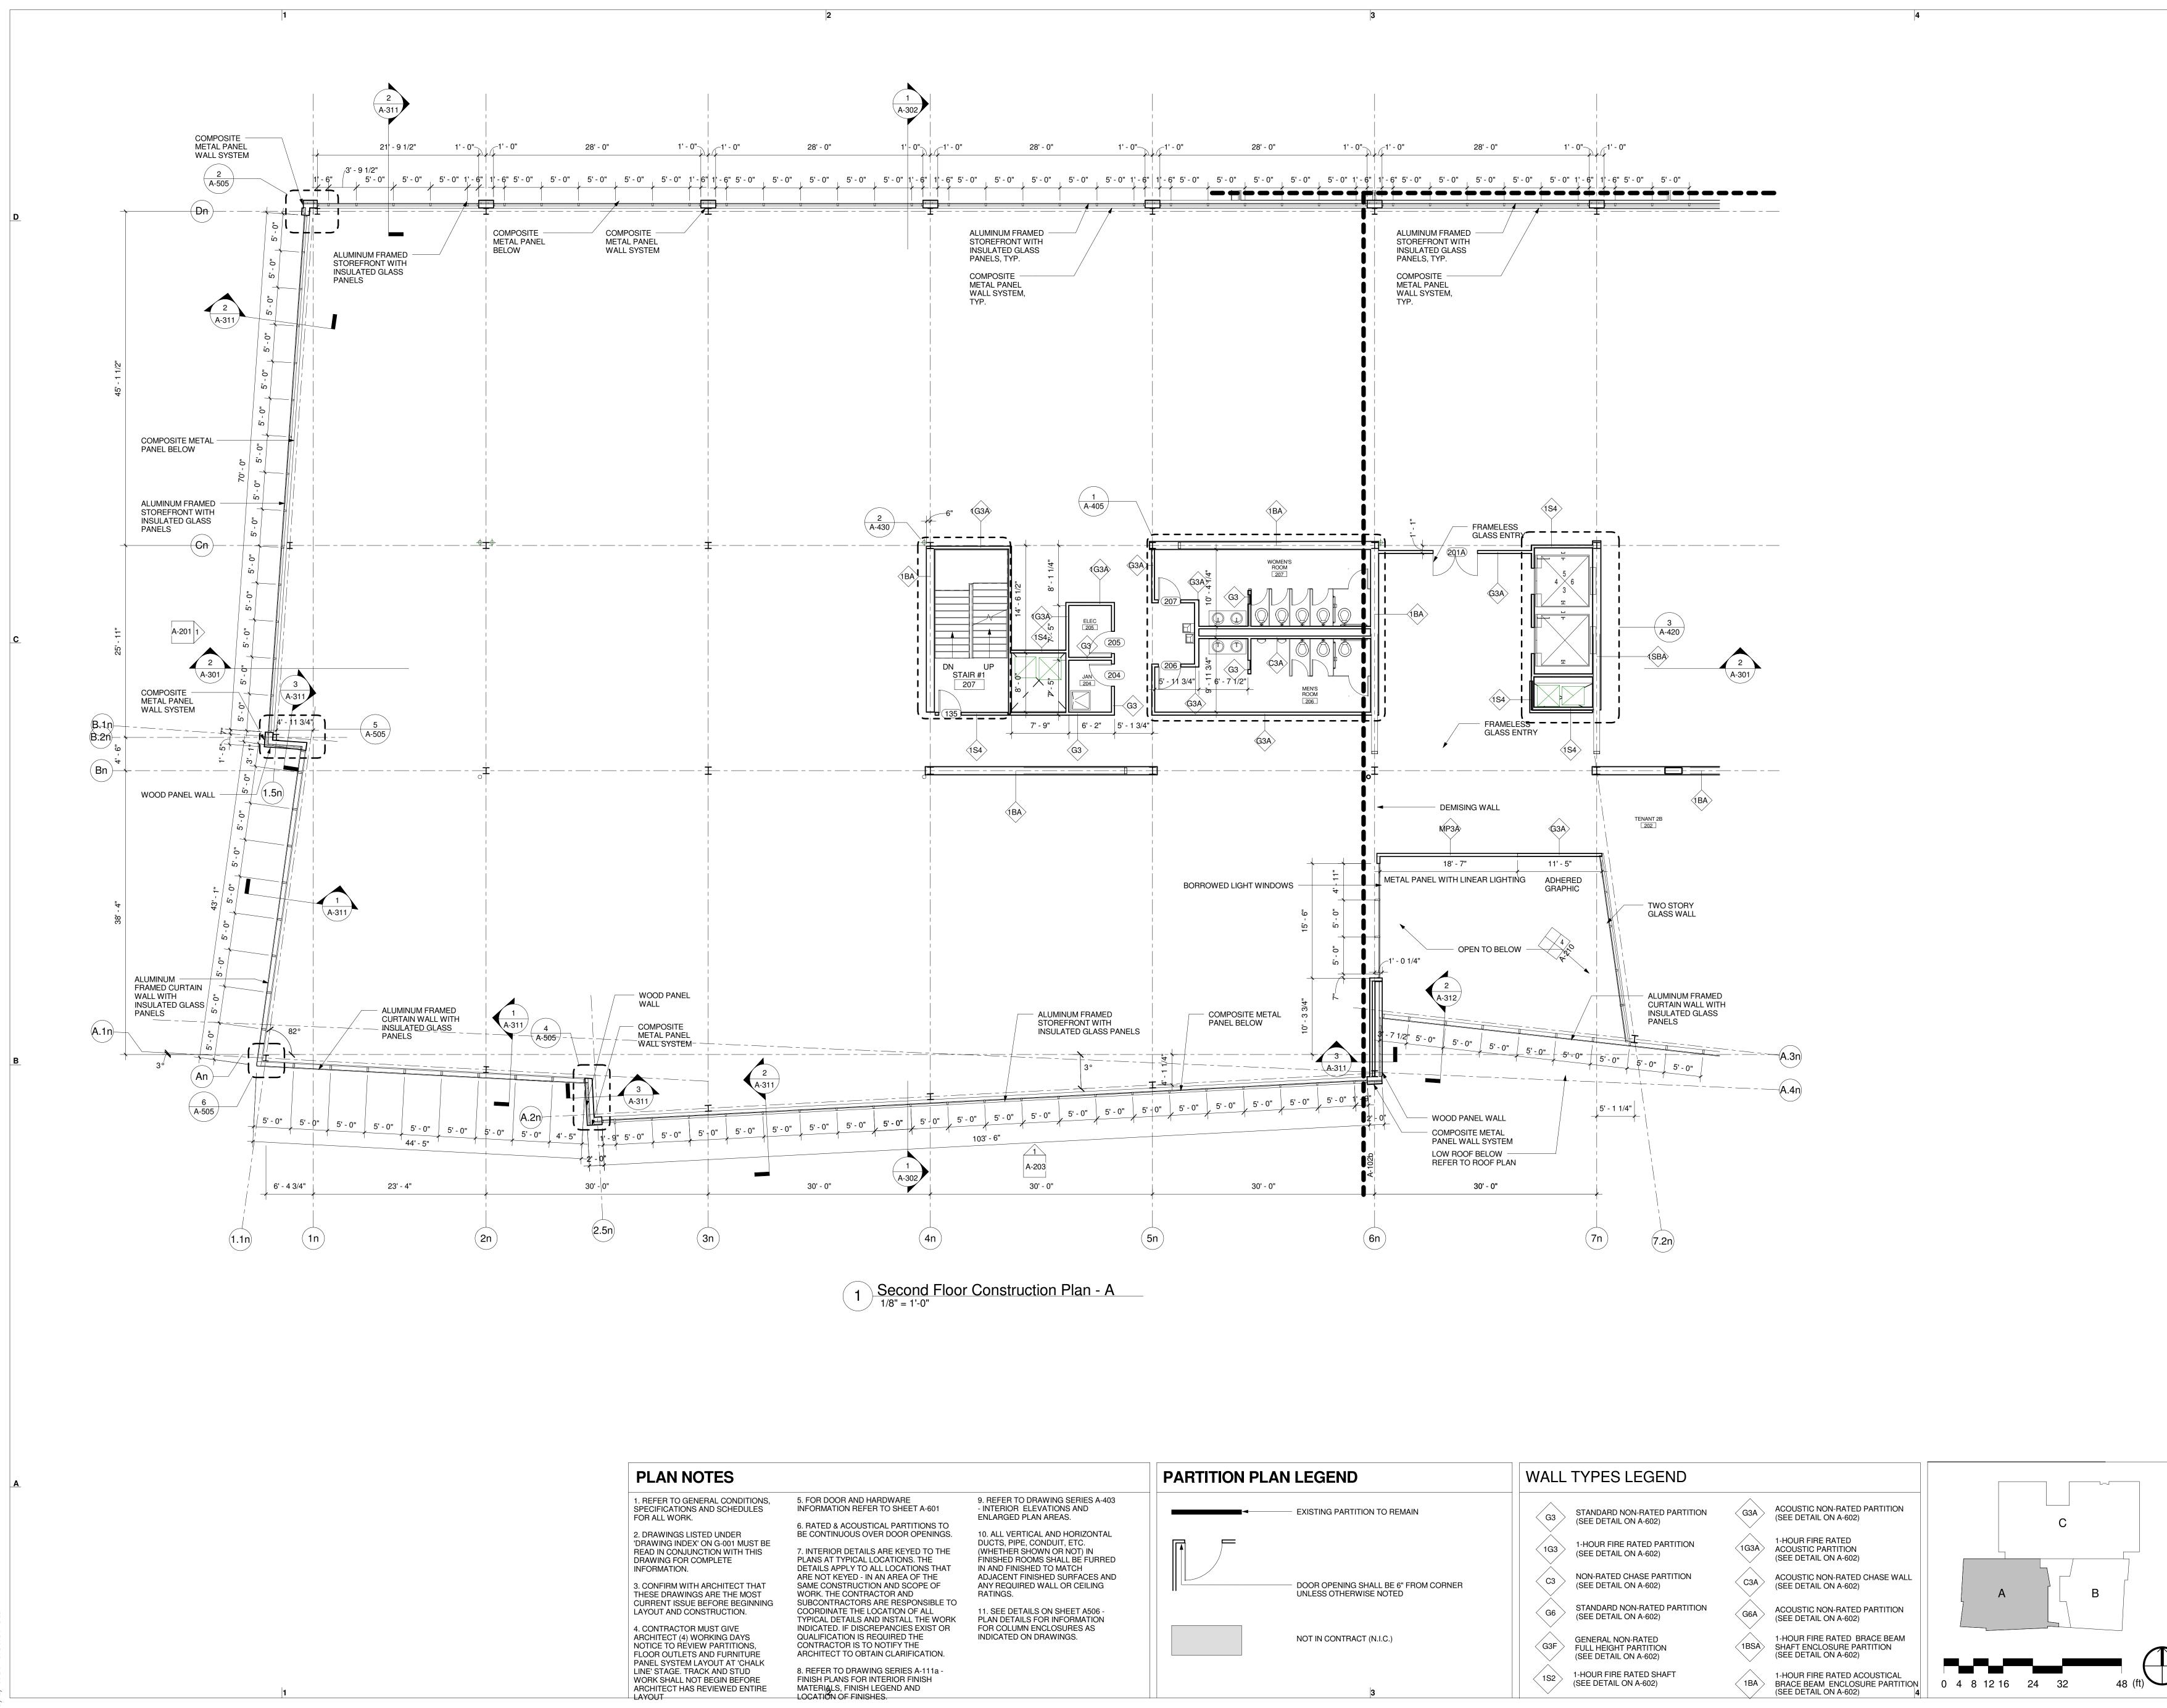

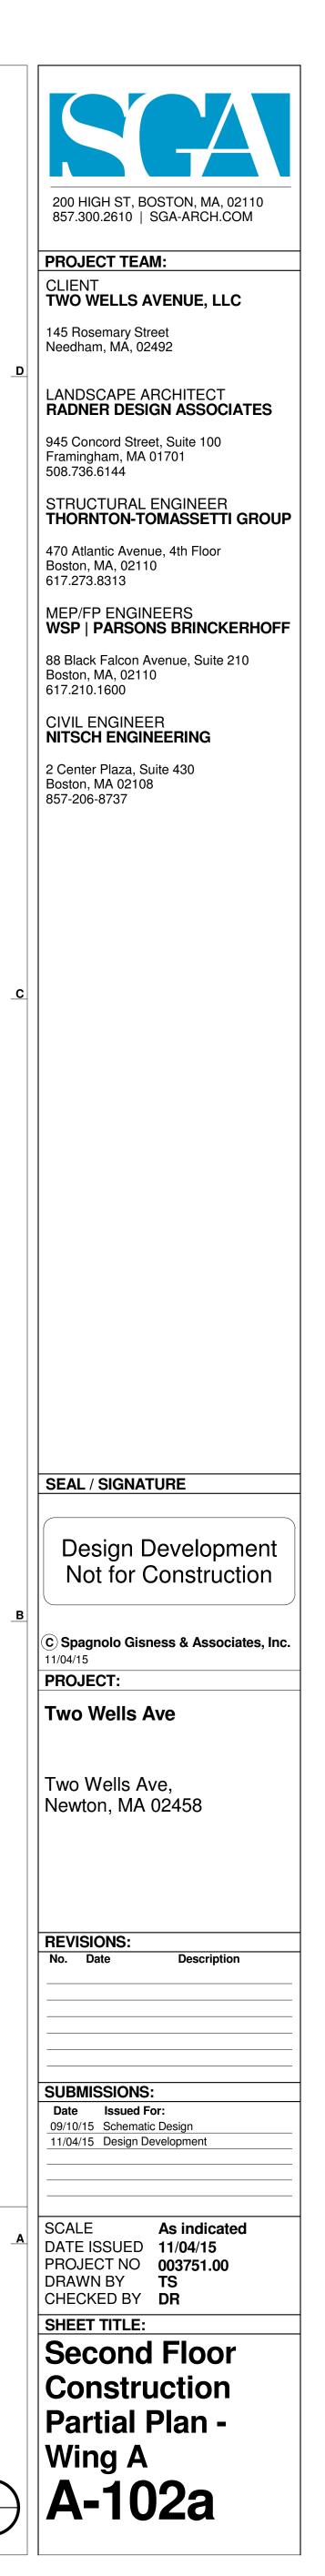

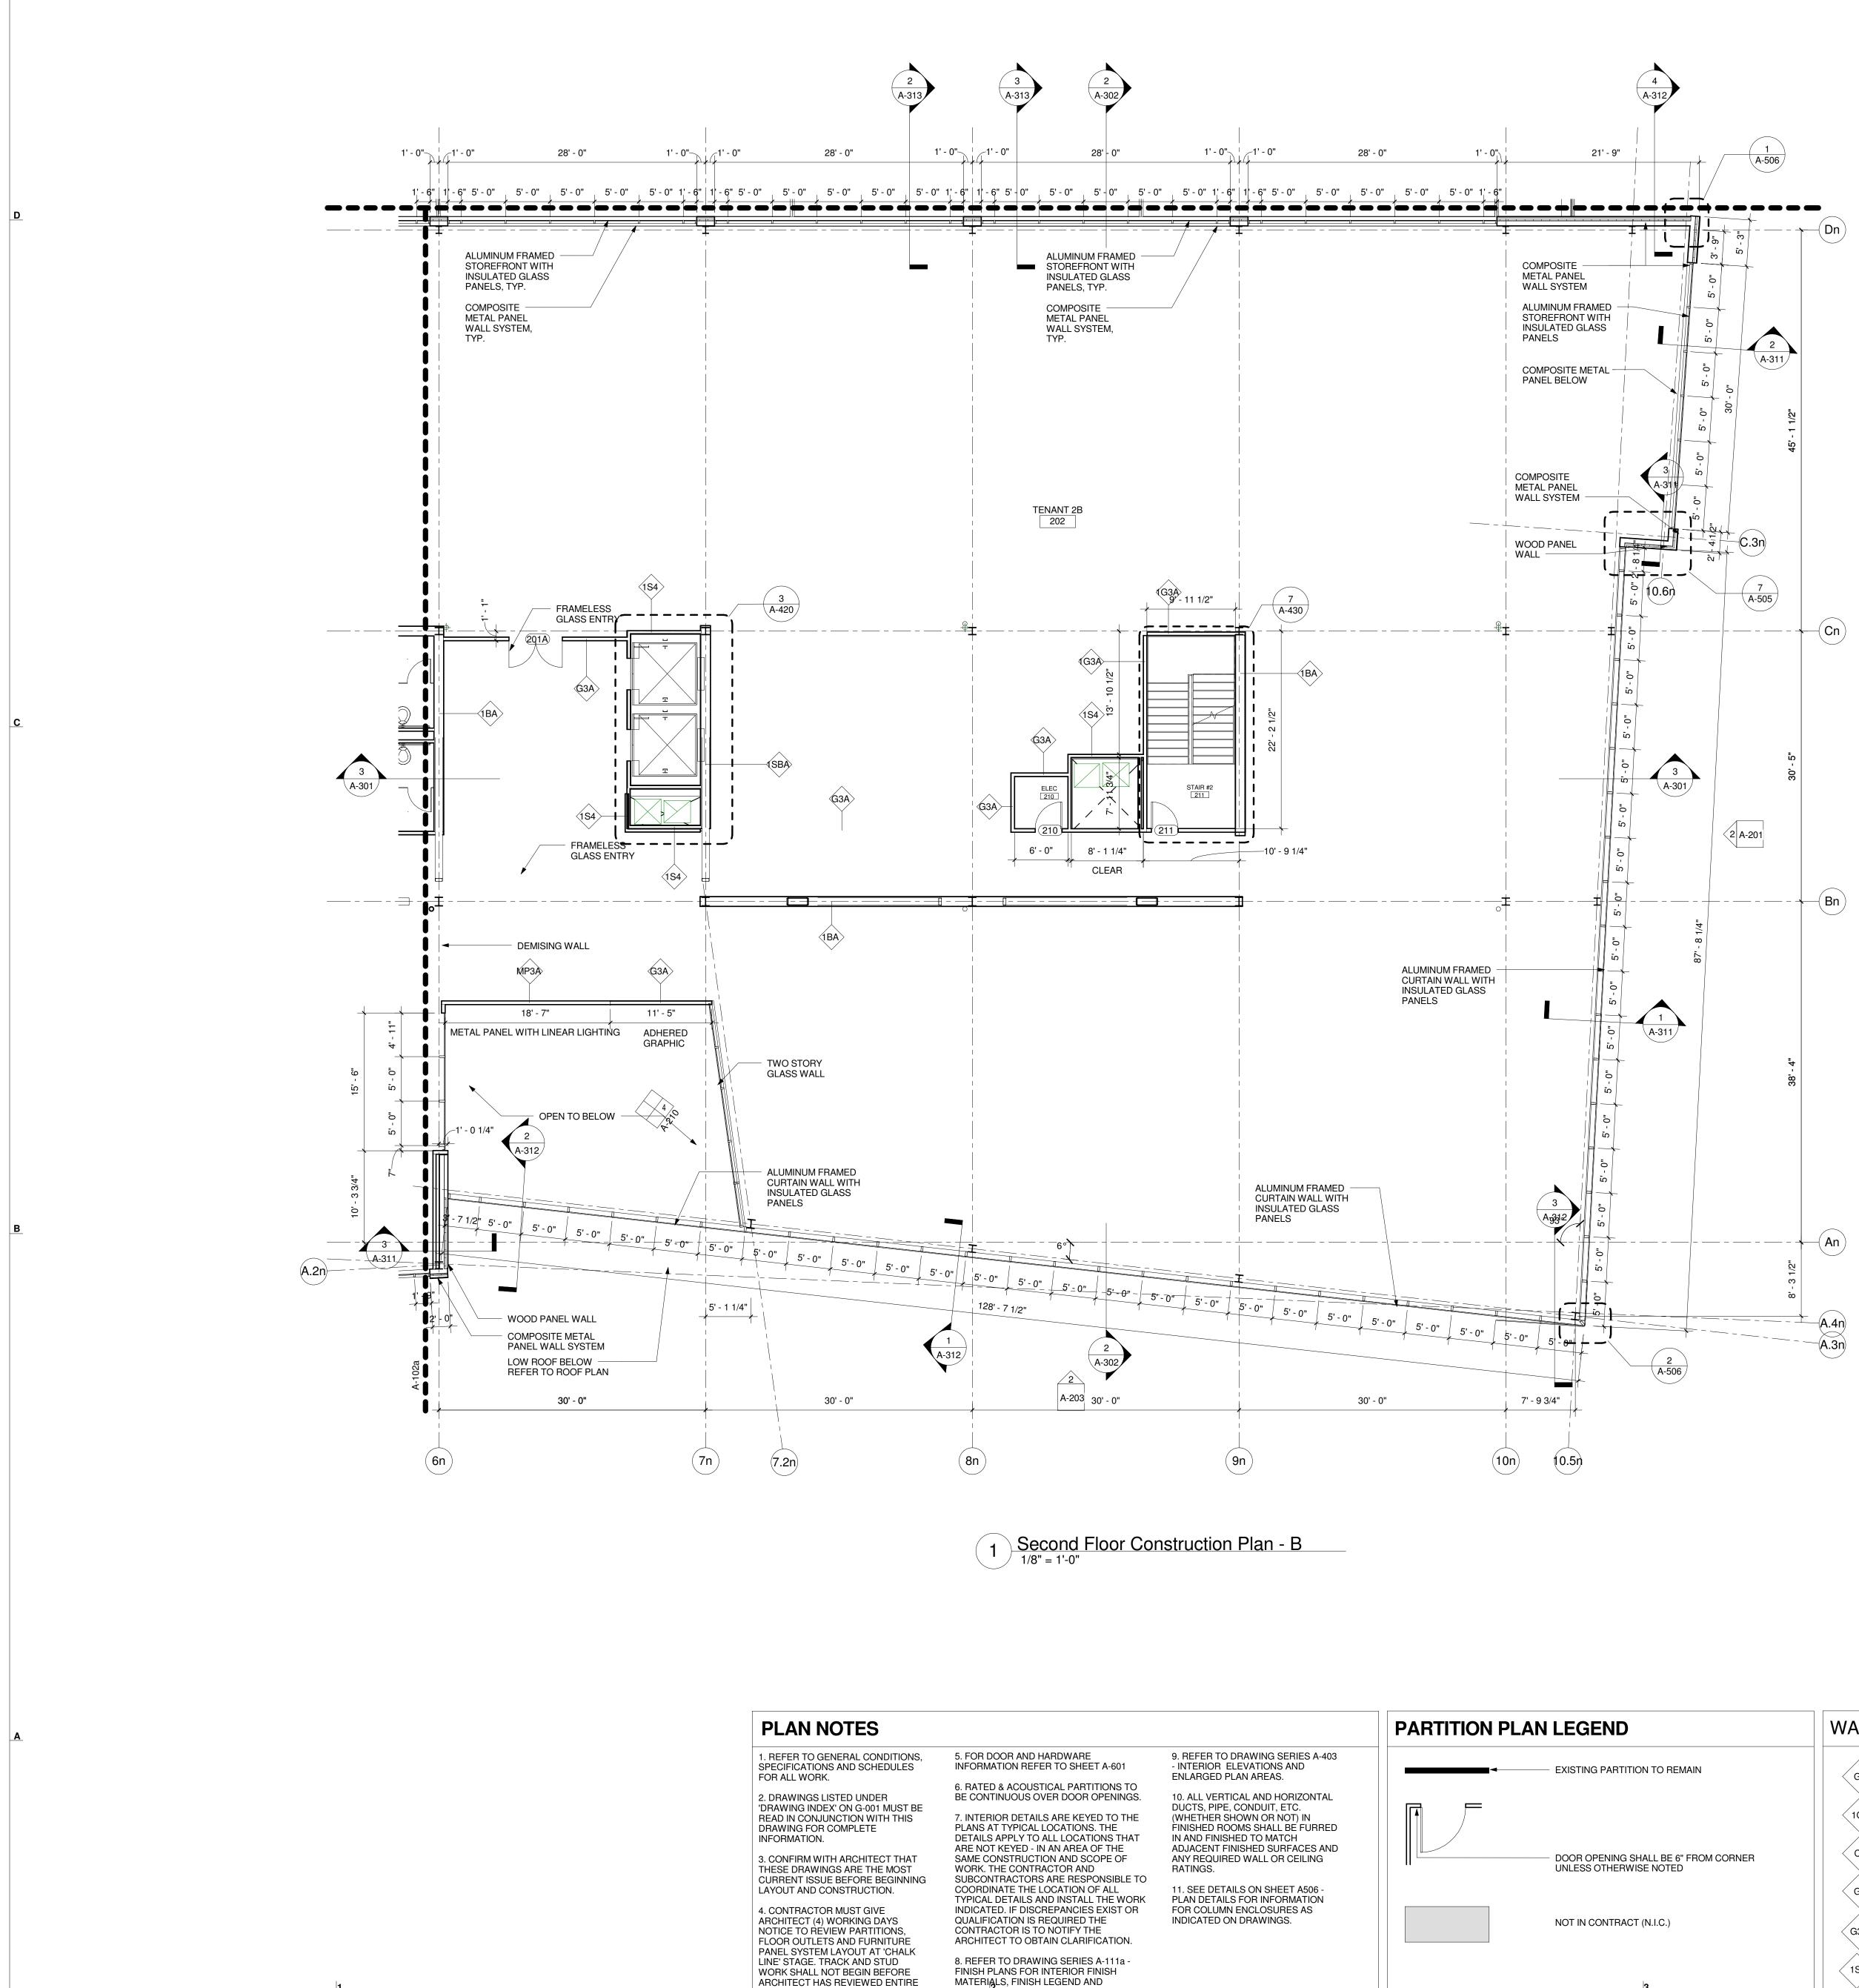


ARCHITECT HAS REVIEWED ENTIRE LAYOUT

LOCATION OF FINISHES.

	WALL TYPES LEGEND		
	G3 STANDARD NON-RATED PARTITION (SEE DETAIL ON A-602)	G3A ACOUSTIC NON-RATED PARTITION (SEE DETAIL ON A-602)	C
	1G3 1-HOUR FIRE RATED PARTITION (SEE DETAIL ON A-602)	1G3A 1-HOUR FIRE RATED ACOUSTIC PARTITION (SEE DETAIL ON A-602)	
NER	C3 NON-RATED CHASE PARTITION (SEE DETAIL ON A-602)	C3A ACOUSTIC NON-RATED CHASE WALL (SEE DETAIL ON A-602)	
	G6 STANDARD NON-RATED PARTITION (SEE DETAIL ON A-602)	G6A ACOUSTIC NON-RATED PARTITION (SEE DETAIL ON A-602)	
	G3F GENERAL NON-RATED FULL HEIGHT PARTITION (SEE DETAIL ON A-602)	1-HOUR FIRE RATED BRACE BEAM SHAFT ENCLOSURE PARTITION (SEE DETAIL ON A-602)	
	1S2 1-HOUR FIRE RATED SHAFT (SEE DETAIL ON A-602)	1-HOUR FIRE RATED ACOUSTICAL BRACE BEAM ENCLOSURE PARTITION (SEE DETAIL ON A-602) 4	0 4 8 12 16 24 32 48 (ft)

D	200 HIGH ST, BOSTON, MA, 02110 857.300.2610   SGA-ARCH.COM PROJECT TEAM: CLIENT TWO WELLS AVENUE, LLC 145 Rosemary Street Needham, MA, 02492 LANDSCAPE ARCHITECT RADNER DESIGN ASSOCIATES 945 Concord Street, Suite 100 Framingham, MA 01701 508.736.6144 STRUCTURAL ENGINEER THORNTON-TOMASSETTI GROUP 470 Atlantic Avenue, 4th Floor Boston, MA, 02110 617.273.8313 MEP/FP ENGINEERS WSP   PARSONS BRINCKERHOFF 88 Black Falcon Avenue, Suite 210 Boston, MA, 02110 617.210.1600 CIVIL ENGINEER NITSCH ENGINEERING
C	2 Center Plaza, Suite 430 Boston, MA 02108 857-206-8737
В	SEAL / SIGNATURE         Design Development         Not for Construction         © Spagnolo Gisness & Associates, Inc.         11/04/15         PROJECT:         Two Wells Ave,         Newton, MA 02458         REVISIONS:         No. Date
_ <b>A</b>	No.       Date       Description         SUBMISSIONS:
$\mathbf{i}$	A-102b

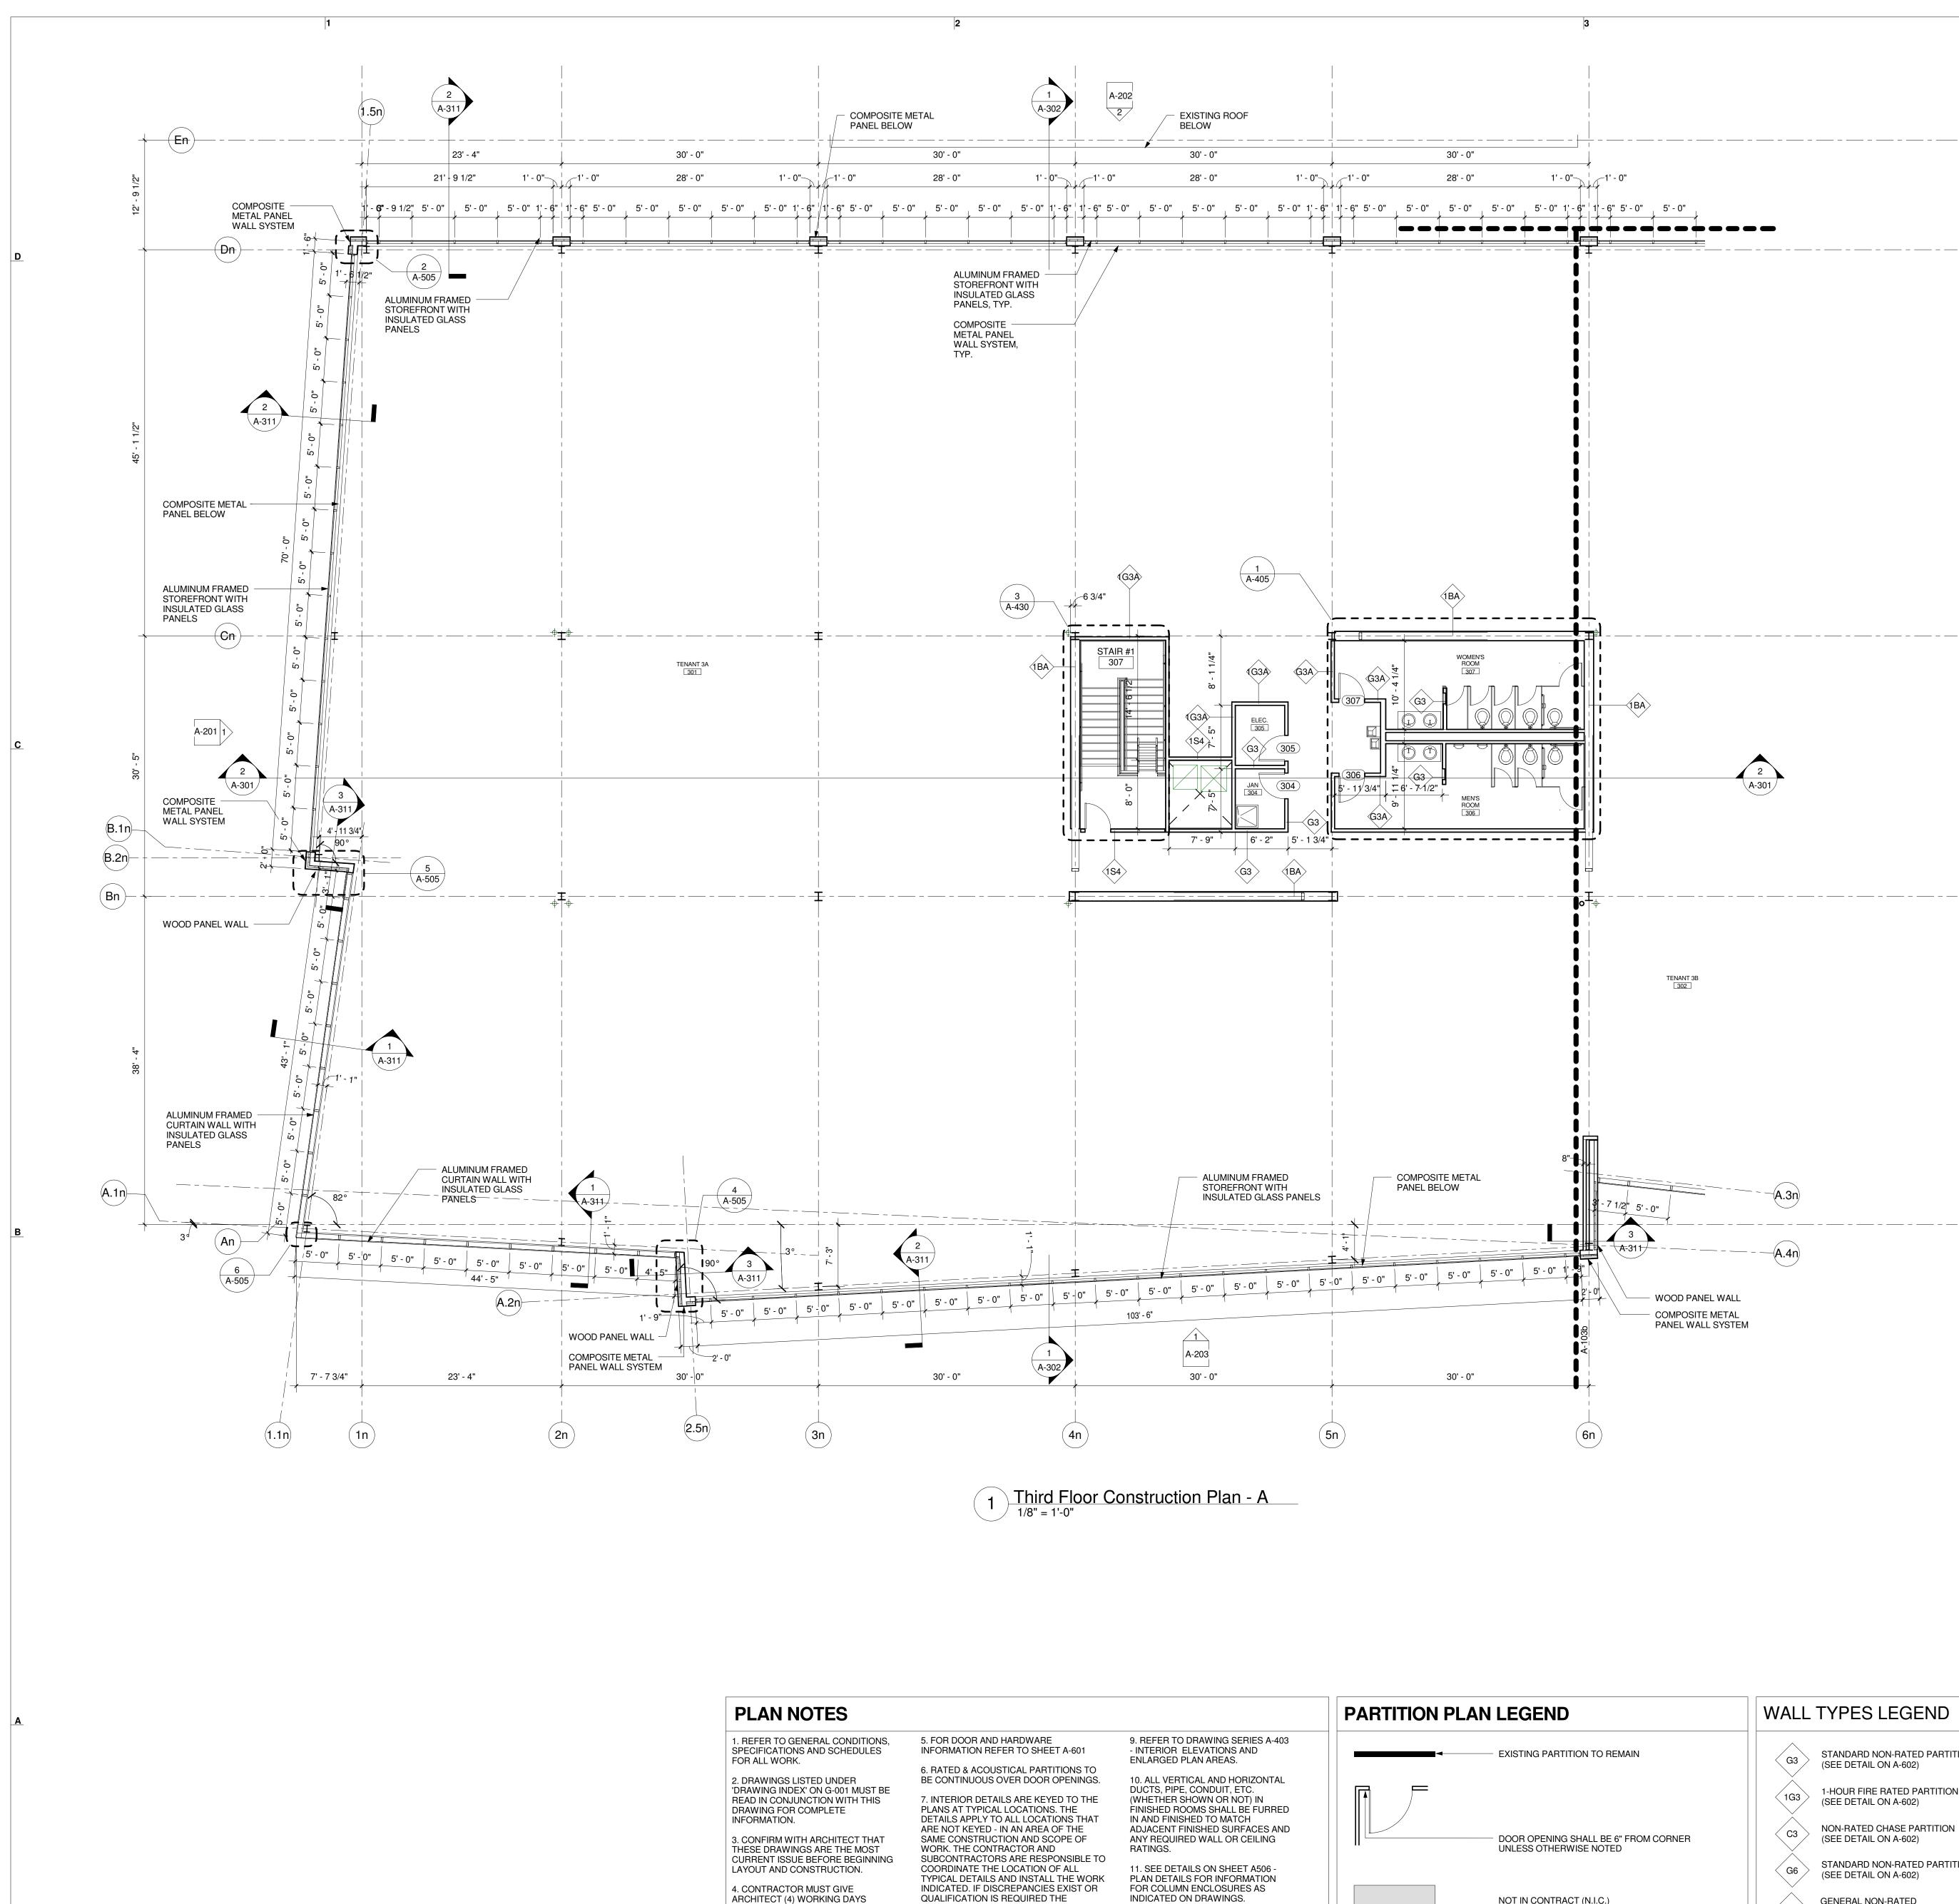

ARCHITECT HAS REVIEWED ENTIRE 

NOTICE TO REVIEW PARTITIONS, FLOOR OUTLETS AND FURNITURE PANEL SYSTEM LAYOUT AT 'CHALK LINE' STAGE. TRACK AND STUD WORK SHALL NOT BEGIN BEFORE

CONTRACTOR IS TO NOTIFY THE ARCHITECT TO OBTAIN CLARIFICATION.

8. REFER TO DRAWING SERIES A-111a -

FINISH PLANS FOR INTERIOR FINISH

MATERIALS, FINISH LEGEND AND

LOCATIÓN ÓF FINISHES.

NOT IN CONTRACT (N.I.C.)

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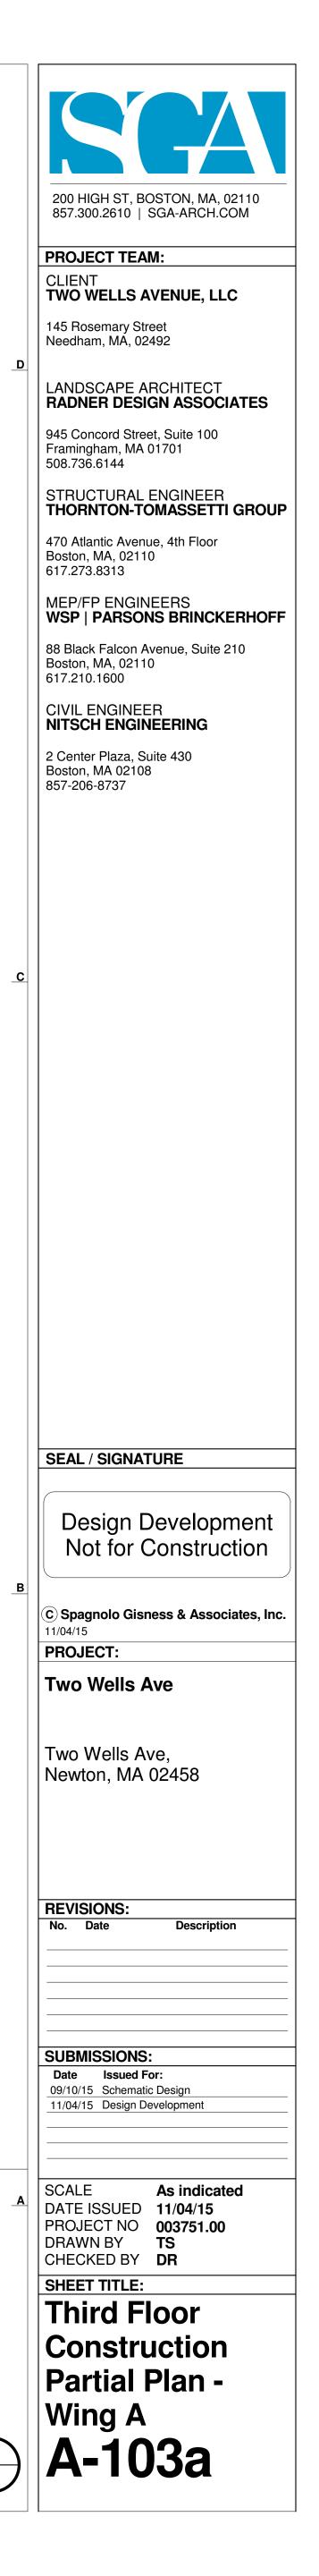
∖**A-3**01,

−(A.3r — - — - — - — (A.4n)


- WOOD PANEL WALL - COMPOSITE METAL PANEL WALL SYSTEM

TENANT 3B


WALL TYPES LEGEND ACOUSTIC NON-RATED PARTITION STANDARD NON-RATED PARTITION 〈 G3A ` < G3 🔾 (SEE DETAIL ON A-602) (SEE DETAIL ON A-602) 1-HOUR FIRE RATED 1-HOUR FIRE RATED PARTITION (1G3A) ACOUSTIC PARTITION < 1G3 🔾 (SEE DETAIL ON A-602) (SEE DETAIL ON A-602) NON-RATED CHASE PARTITION ACOUSTIC NON-RATED CHASE WALL C3 < C3A > (SEE DETAIL ON A-602) (SEE DETAIL ON A-602) STANDARD NON-RATED PARTITION ACOUSTIC NON-RATED PARTITION G6 G6A (SEE DETAIL ON A-602) (SEE DETAIL ON A-602) 1-HOUR FIRE RATED BRACE BEAM GENERAL NON-RATED 1BSA SHAFT ENCLOSURE PARTITION (SEE DETAIL ON A-602)  $\langle$  G3F  $\rangle$ FULL HEIGHT PARTITION (SEE DETAIL ON A-602) 1-HOUR FIRE RATED SHAFT 1-HOUR FIRE RATED ACOUSTICAL 1S2 1BA BRACE BEAM ENCLOSURE PARTITION 0 4 8 12 16 24 32 (SEE DETAIL ON A-602) (SEE DETAIL ON A-602)




48 (ft)

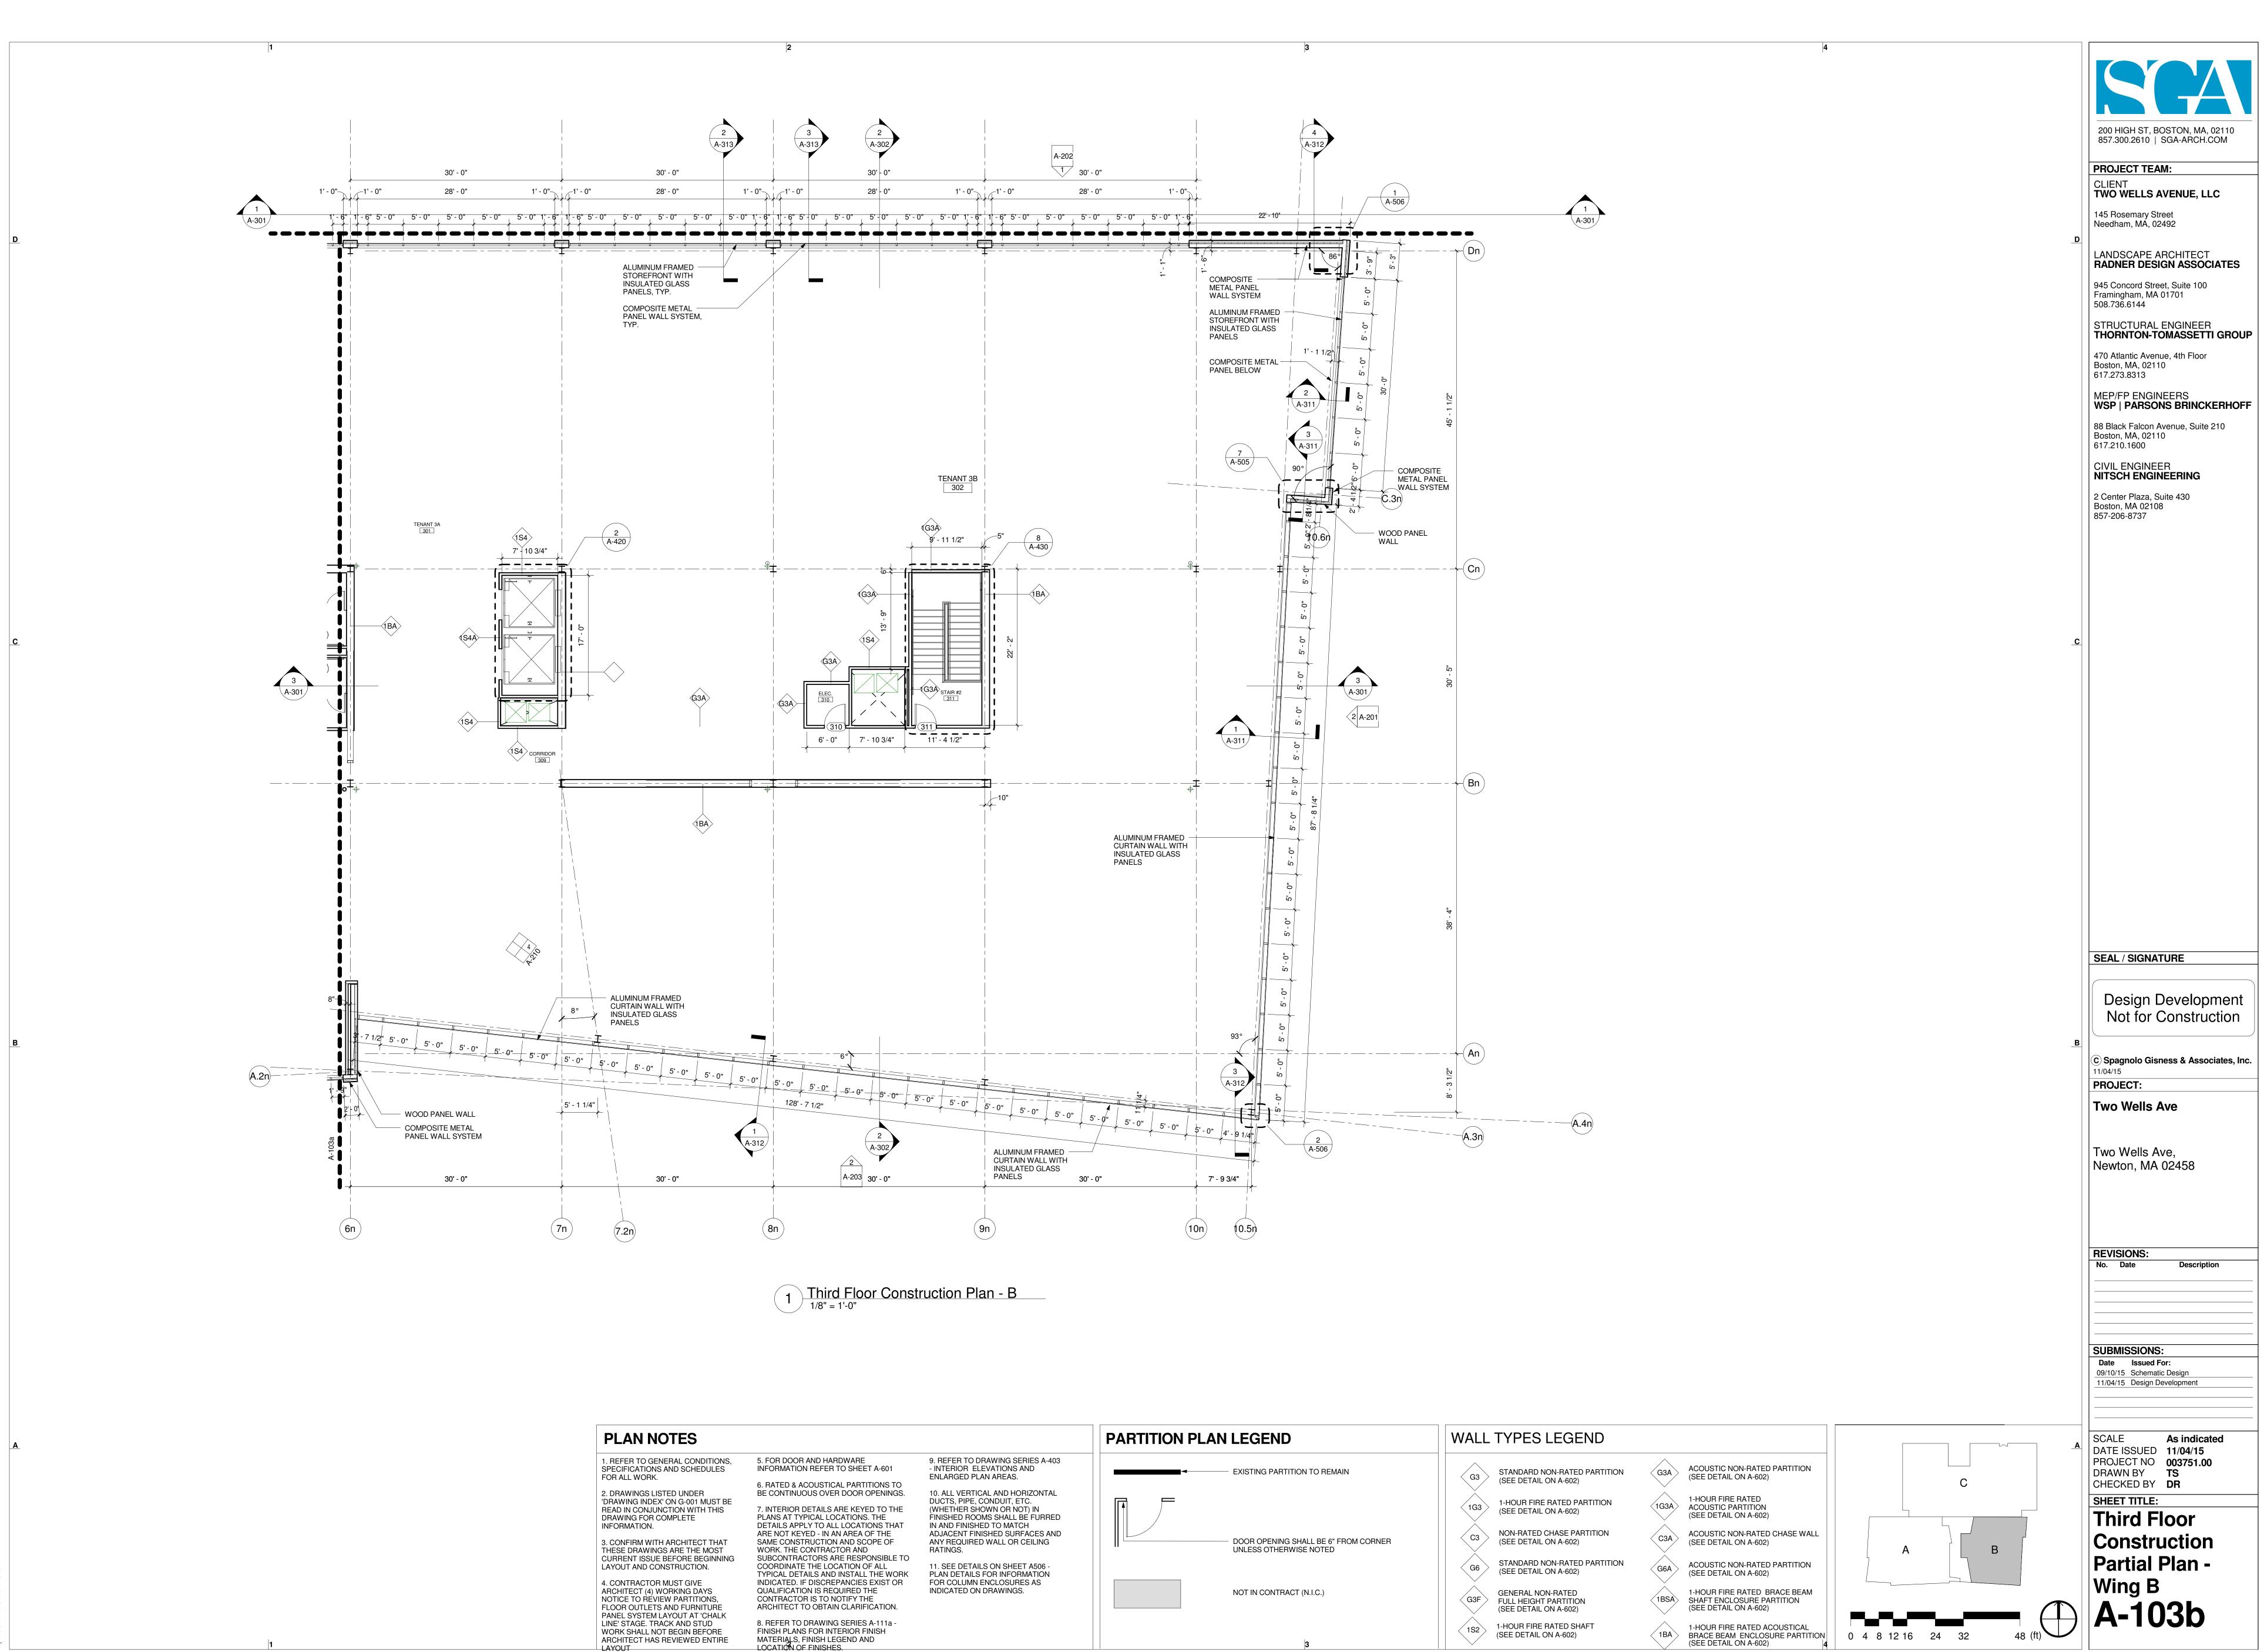

AK. LISTED UNDER DEX' ON G-001 MUST BE JUNCTION WITH THIS R COMPLETE J. M COMPLETE J. M COMPLETE ARE NOT KEYED - IN AN AREA OF THE M COMPLETE J. M									
INFORMATION REFER TO SHEET A-601 INFORMATION WITH THIS R COMPLETE INFORMATION WITH THIS R COMPLETE INFORMATION AND SCOPE OF INFORMATION OF ALL TYPICAL DECATION OF ALL TYPICAL DECATION OF ALL TYPICAL DECATION OF ALL TYPICAL DETAILS AND INSTALL THE WORK INDICATED IF DISCREPANCIES EXIST OR INDICATED TO OBTAIN CLARIFICATION. ARCHITECT TO ADAWING SERIES A-1111 - FINISH PLANS FOR INTERIOR FINISH AS REVIEWED ENTIRE MATERIALS, FINISH LEGEON AND INTO INCONTRACT INSHIP	NOTES		PARTITION PLAN LEGEND						
	INS AND SCHEDULES RK. LISTED UNDER DEX' ON G-001 MUST BE JUNCTION WITH THIS R COMPLETE J. /ITH ARCHITECT THAT INGS ARE THE MOST UE BEFORE BEGINNING CONSTRUCTION. OR MUST GIVE WORKING DAYS EVIEW PARTITIONS, ETS AND FURNITURE M LAYOUT AT 'CHALK TRACK AND STUD NOT BEGIN BEFORE	<ul> <li>INFORMATION REFER TO SHEET A-601</li> <li>6. RATED &amp; ACOUSTICAL PARTITIONS TO BE CONTINUOUS OVER DOOR OPENINGS.</li> <li>7. INTERIOR DETAILS ARE KEYED TO THE PLANS AT TYPICAL LOCATIONS. THE DETAILS APPLY TO ALL LOCATIONS THAT ARE NOT KEYED - IN AN AREA OF THE SAME CONSTRUCTION AND SCOPE OF WORK. THE CONTRACTOR AND SUBCONTRACTORS ARE RESPONSIBLE TO COORDINATE THE LOCATION OF ALL TYPICAL DETAILS AND INSTALL THE WORK INDICATED. IF DISCREPANCIES EXIST OR QUALIFICATION IS REQUIRED THE CONTRACTOR IS TO NOTIFY THE ARCHITECT TO OBTAIN CLARIFICATION.</li> <li>8. REFER TO DRAWING SERIES A-111a - FINISH PLANS FOR INTERIOR FINISH</li> </ul>	<ul> <li>- INTERIOR ELEVATIONS AND ENLARGED PLAN AREAS.</li> <li>10. ALL VERTICAL AND HORIZONTAL DUCTS, PIPE, CONDUIT, ETC. (WHETHER SHOWN OR NOT) IN FINISHED ROOMS SHALL BE FURRED IN AND FINISHED TO MATCH ADJACENT FINISHED SURFACES AND ANY REQUIRED WALL OR CEILING RATINGS.</li> <li>11. SEE DETAILS ON SHEET A506 - PLAN DETAILS FOR INFORMATION FOR COLUMN ENCLOSURES AS</li> </ul>		NOT IN CONTRACT (N.I.C.)				
					3				

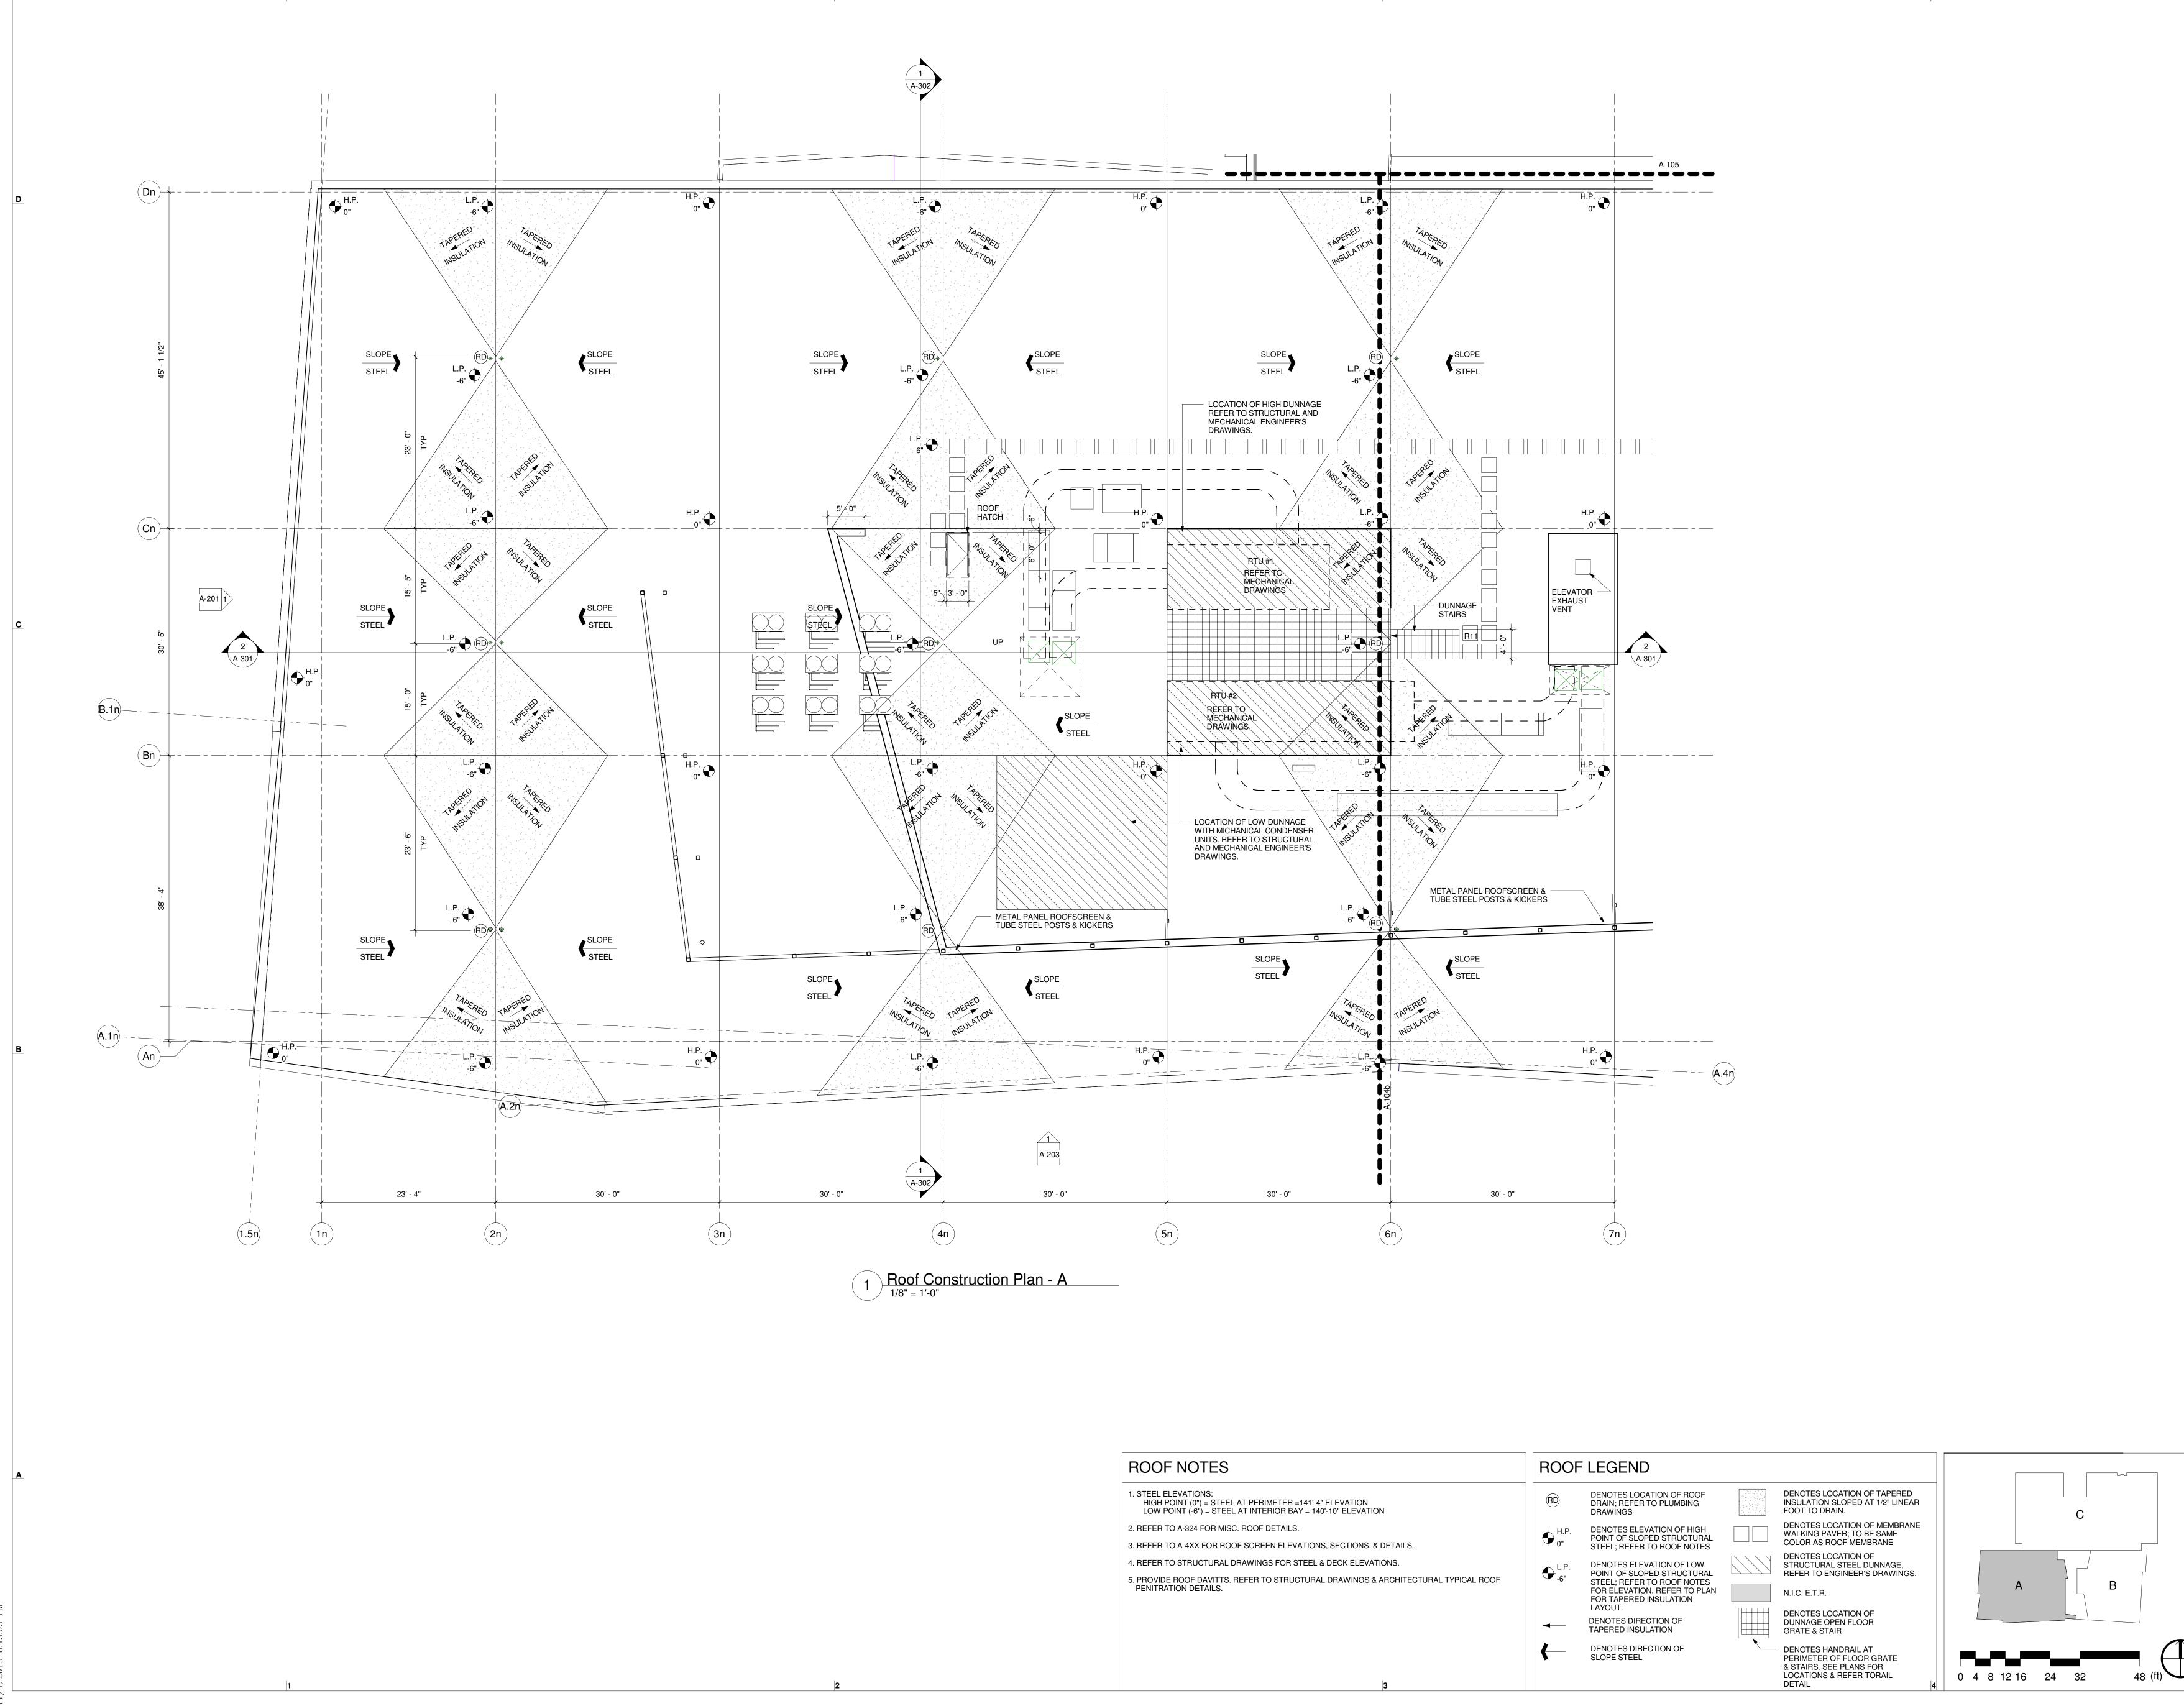


200 HIGH ST, BOSTON, MA, 02110 857.300.2610   SGA-ARCH.COM PROJECT TEAM: CLIENT TWO WELLS AVENUE, LLC 145 Rosemary Street Needham, MA, 02492 LANDSCAPE ARCHITECT RADNER DESIGN ASSOCIATES 945 Concord Street, Suite 100 Framingham, MA 01701 508.736.6144 STRUCTURAL ENGINEER THORNTON-TOMASSETTI GROUP 470 Atlantic Avenue, 4th Floor Boston, MA, 02110 617.273.8313 MEP/FP ENGINEERS WSP   PARSONS BRINCKERHOFF 88 Black Falcon Avenue, Suite 210 Boston, MA, 02110 617.210.1600 CIVIL ENGINEER NITSCH ENGINEERING
2 Center Plaza, Suite 430 Boston, MA 02108 857-206-8737
SEAL / SIGNATURE         Design Development         Not for Construction         © Spagnolo Gisness & Associates, Inc.         11/04/15         PROJECT:         Two Wells Ave,         Newton, MA 02458
REVISIONS:         No.       Date       Description
SCALE As indicated DATE ISSUED 11/04/15 003751.00 DRAWN BY CHECKED BY DR SHEET TITLE: Roof Construction Partial Plan - Wing A Ming A A-104a

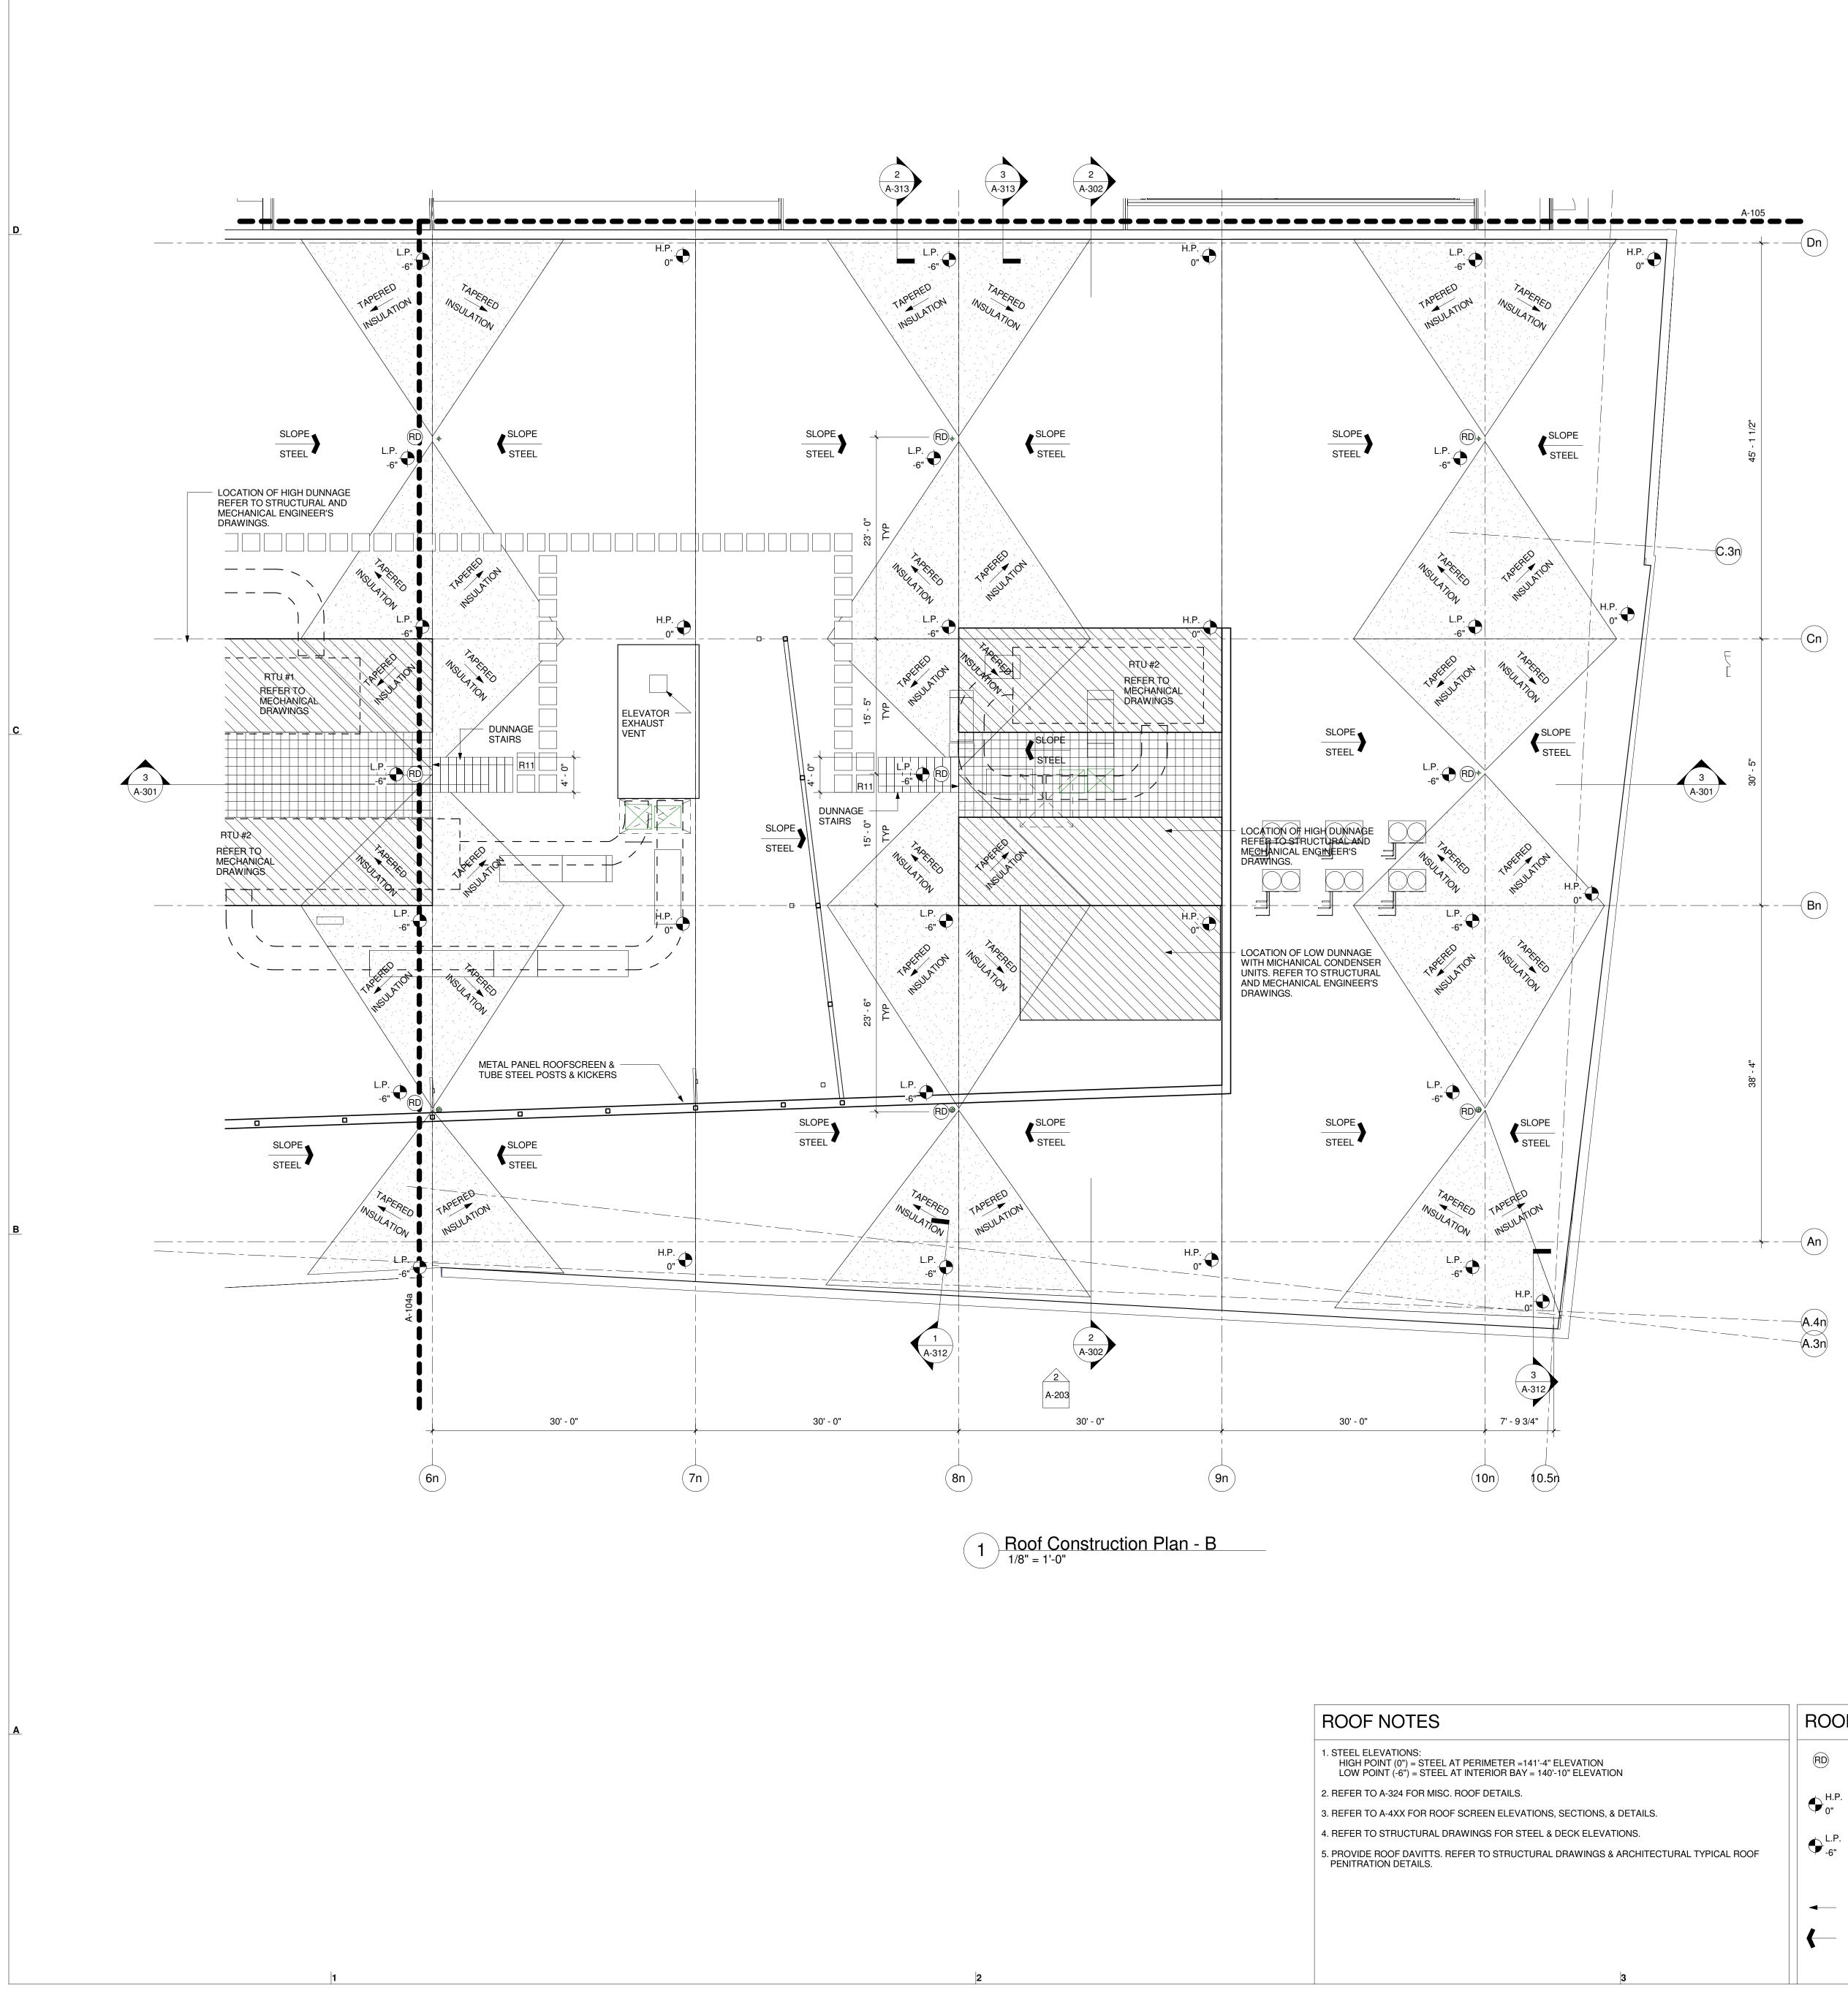

	ROOF	ELEGEND								
	RD	DENOTES LOCATION OF ROOF DRAIN; REFER TO PLUMBING DRAWINGS	DENOTES LOCATION OF TAPERED INSULATION SLOPED AT 1/2" LINEAR FOOT TO DRAIN.					C		
	Ф <sup>Н.Р.</sup> 0"	DENOTES ELEVATION OF HIGH POINT OF SLOPED STRUCTURAL STEEL; REFER TO ROOF NOTES	DENOTES LOCATION OF MEMBRANE WALKING PAVER; TO BE SAME COLOR AS ROOF MEMBRANE					0		
PICAL ROOF	• L.P. -6"	DENOTES ELEVATION OF LOW POINT OF SLOPED STRUCTURAL STEEL; REFER TO ROOF NOTES	DENOTES LOCATION OF STRUCTURAL STEEL DUNNAGE, REFER TO ENGINEER'S DRAWINGS.			_			_	
		FOR ELEVATION. REFER TO PLAN FOR TAPERED INSULATION	N.I.C. E.T.R.	.C. E.T.R.		В				
	-	LAYOUT. DENOTES DIRECTION OF TAPERED INSULATION	DENOTES LOCATION OF DUNNAGE OPEN FLOOR GRATE & STAIR							
	↓ ←	DENOTES DIRECTION OF SLOPE STEEL	- DENOTES HANDRAIL AT PERIMETER OF FLOOR GRATE & STAIRS. SEE PLANS FOR LOCATIONS & REFER TORAIL DETAIL 4	0	48	12 16	24	32	4	8 (ft)

D	200 HIGH ST, BOSTON, MA, 02110 857.300.2610   SGA-ARCH.COM PROJECT TEAM: CLIENT TWO WELLS AVENUE, LLC 145 Rosemary Street Needham, MA, 02492 LANDSCAPE ARCHITECT RADNER DESIGN ASSOCIATES 945 Concord Street, Suite 100 Framingham, MA 01701 508.736.6144 STRUCTURAL ENGINEER THORNTON-TOMASSETTI GROUP 470 Atlantic Avenue, 4th Floor Boston, MA, 02110 617.273.8313 MEP/FP ENGINEERS WSP   PARSONS BRINCKERHOFF 88 Black Falcon Avenue, Suite 210 Boston, MA, 02110 617.210.1600 CIVIL ENGINEER NITSCH ENGINEERING 2 Contor Plaza, Suite 420
C	2 Center Plaza, Suite 430 Boston, MA 02108 857-206-8737
В	SEAL / SIGNATURE         Design Development         Not for Construction         © Spagnolo Gisness & Associates, Inc.         11/04/15         PROJECT:         Two Wells Ave,         Newton, MA 02458
	REVISIONS:         No.       Date       Description
	SCALE As indicated DATE ISSUED 11/04/15 PROJECT NO DRAWN BY CHECKED BY DR SHEET TITLE: Roof Construction Partial Plan - Wing B A-104b

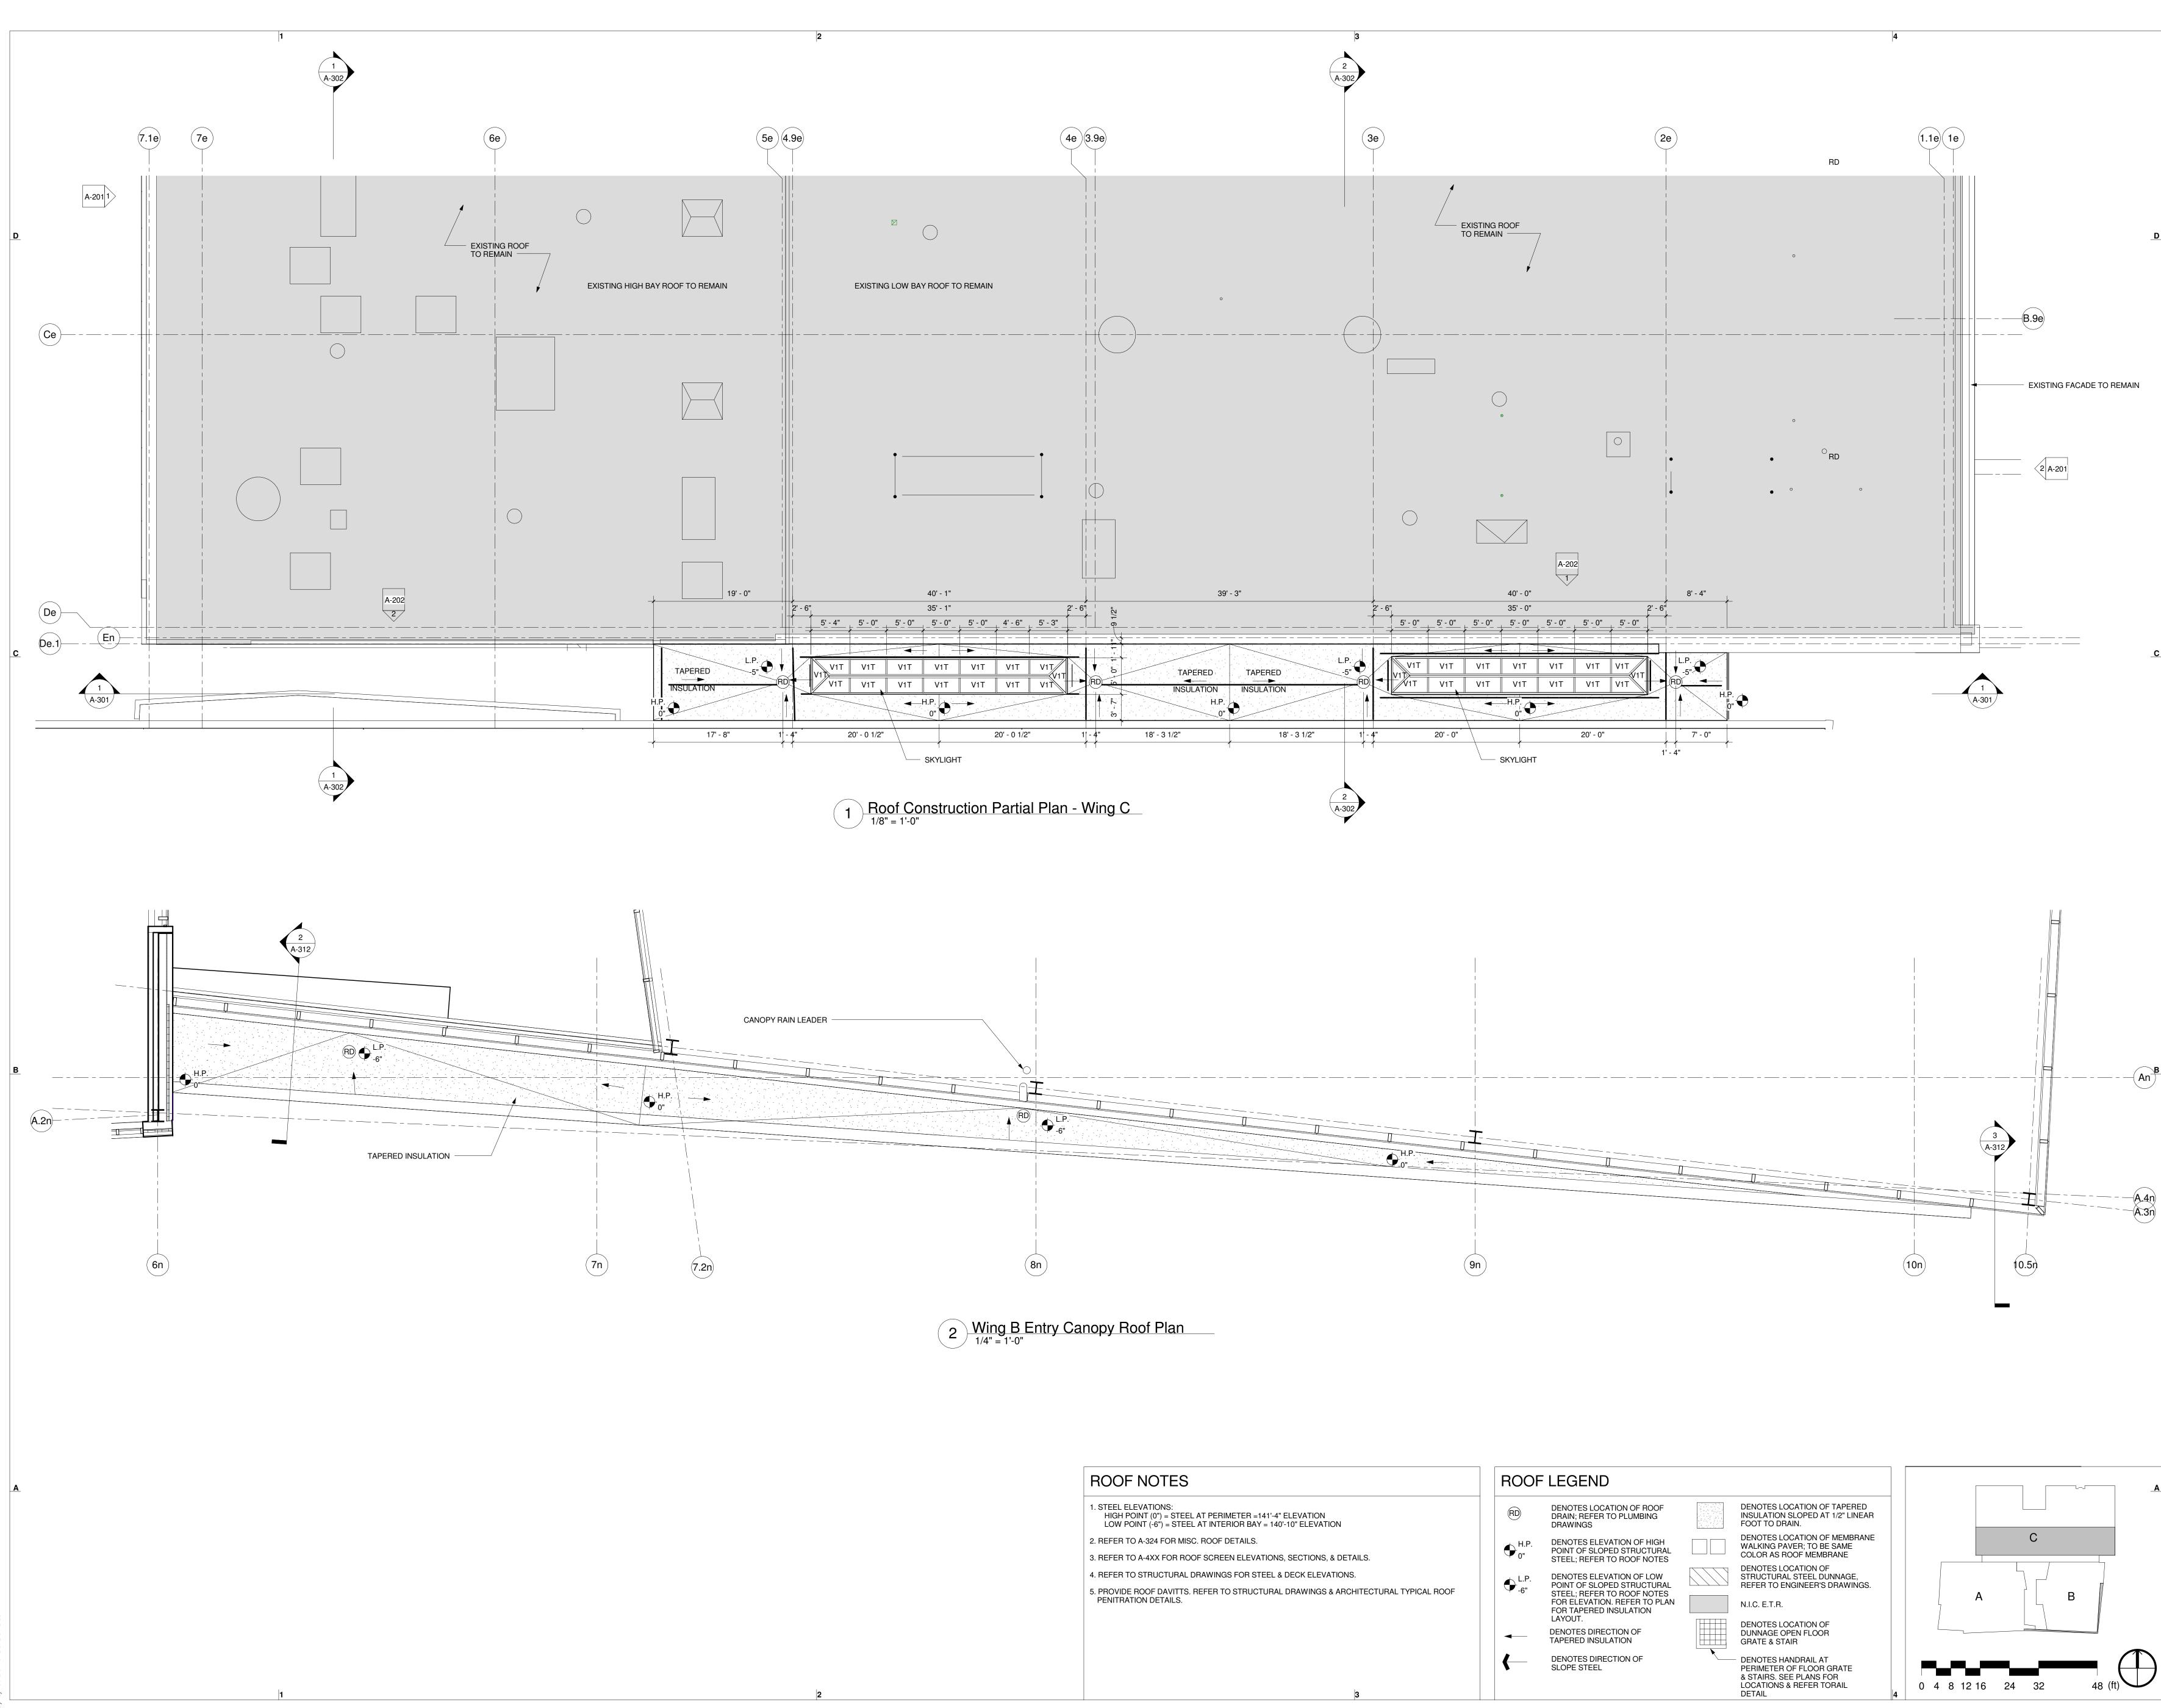



200 HIGH ST, BOSTON, MA, 02110 857.300.2610 | SGA-ARCH.COM PROJECT TEAM: CLIENT TWO WELLS AVENUE, LLC 145 Rosemary Street Needham, MA, 02492 LANDSCAPE ARCHITECT RADNER DESIGN ASSOCIATES 945 Concord Street, Suite 100 Framingham, MA 01701 508.736.6144 STRUCTURAL ENGINEER THORNTON-TOMASSETTI GROUP 470 Atlantic Avenue, 4th Floor Boston, MA, 02110 617.273.8313 MEP/FP ENGINEERS WSP | PARSONS BRINCKERHOFF 88 Black Falcon Avenue, Suite 210 Boston, MA, 02110 617.210.1600 CIVIL ENGINEER NITSCH ENGINEERING 2 Center Plaza, Suite 430 Boston, MA 02108 857-206-8737 SEAL / SIGNATURE Design Development Not for Construction C Spagnolo Gisness & Associates, Inc. 11/04/15 PROJECT: Two Wells Ave Two Wells Ave, Newton, MA 02458 -A.4n **REVISIONS:** No. Date Description SUBMISSIONS: DateIssued For:09/10/15Schematic Design11/04/15Design Development SCALE As indicated DATE ISSUED 11/04/15 PROJECT NO 003751.00 DRAWN BY TS CHECKED BY **DR** SHEET TITLE: Roof Construction Plan - Wing C A-105


SUBSEQUENTLY CAULKED WITH GENERAL PURPOSE SEALANT. 2. WOOD NAILER MUST EXTEND BEYOND METAL FLANGE IN ALL DIRECTIONS. 3. HOT DIPPED GALVANIZED NAILS 1-1/4" LONG WITH 3/8" DIA. HEAD (MIN.). NAILING OFF THE MEMBRANE IS NOT REQUIRED IF MEMBRANE EXTENDS OVER THE

TOP OF THE CURB. 4. 3" (MIN.) FORMFLASH OR 6" EPDM LAP SPLICE.


EPDM WASHERS MUST BE USED AND

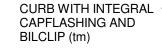

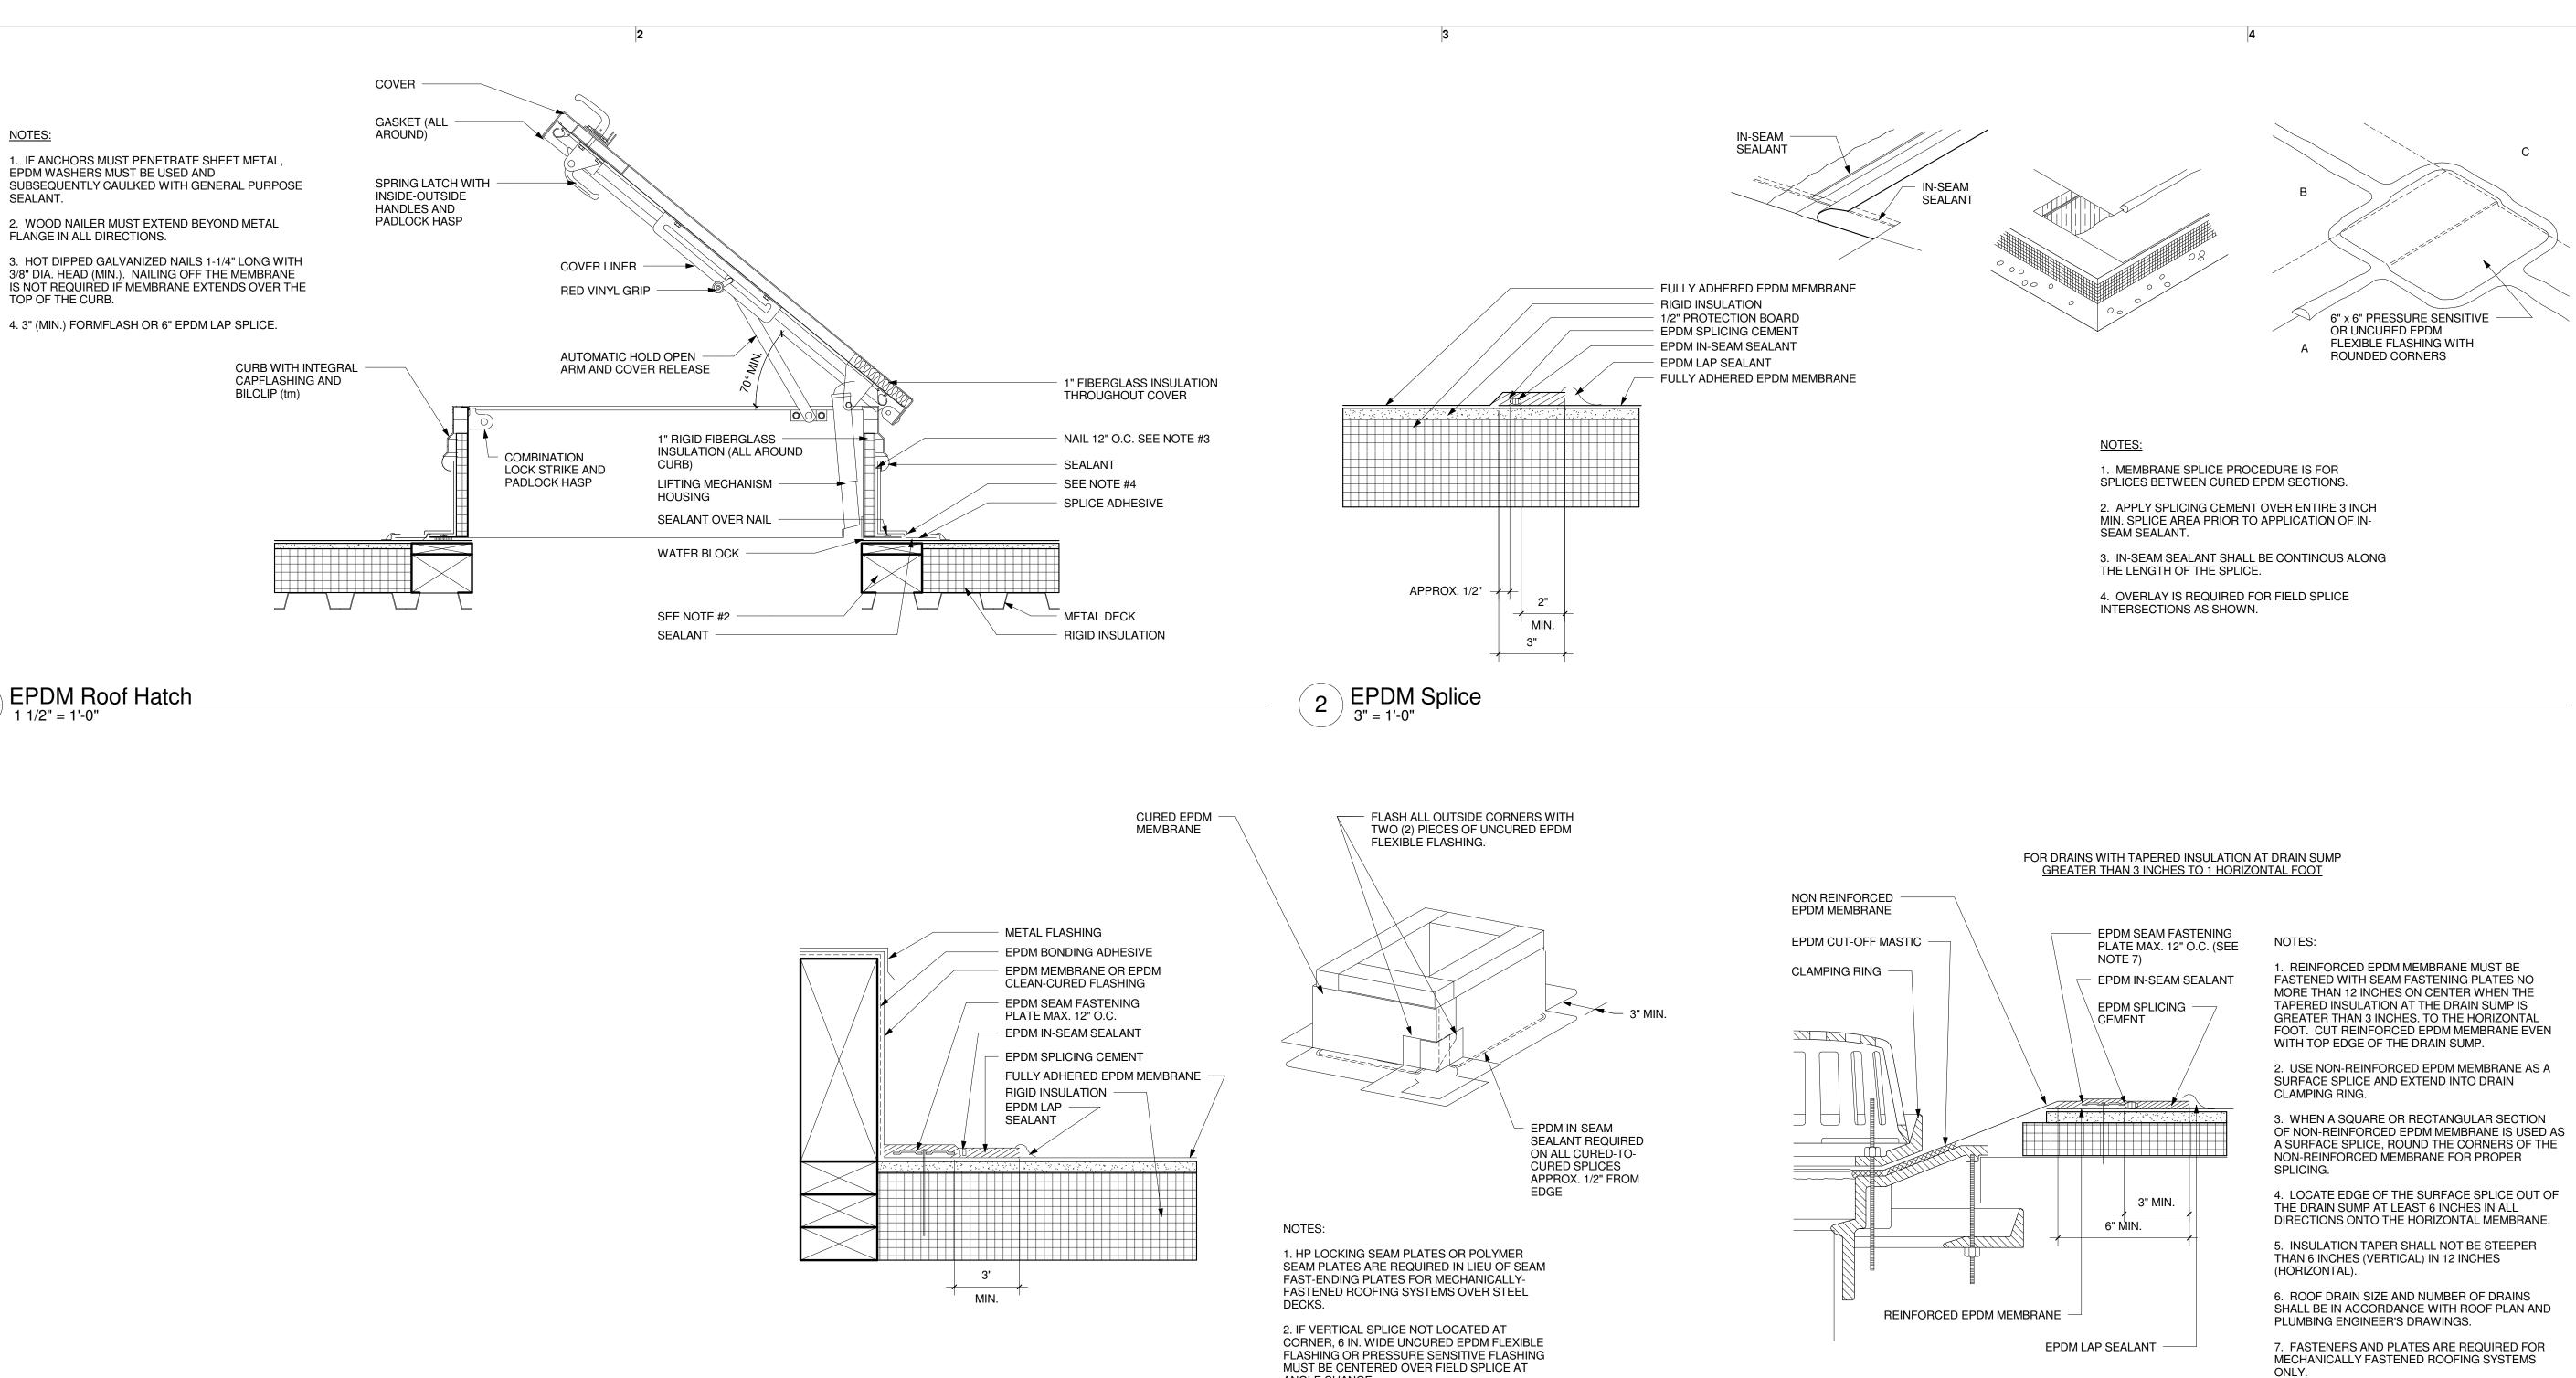

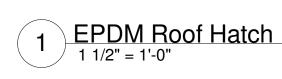



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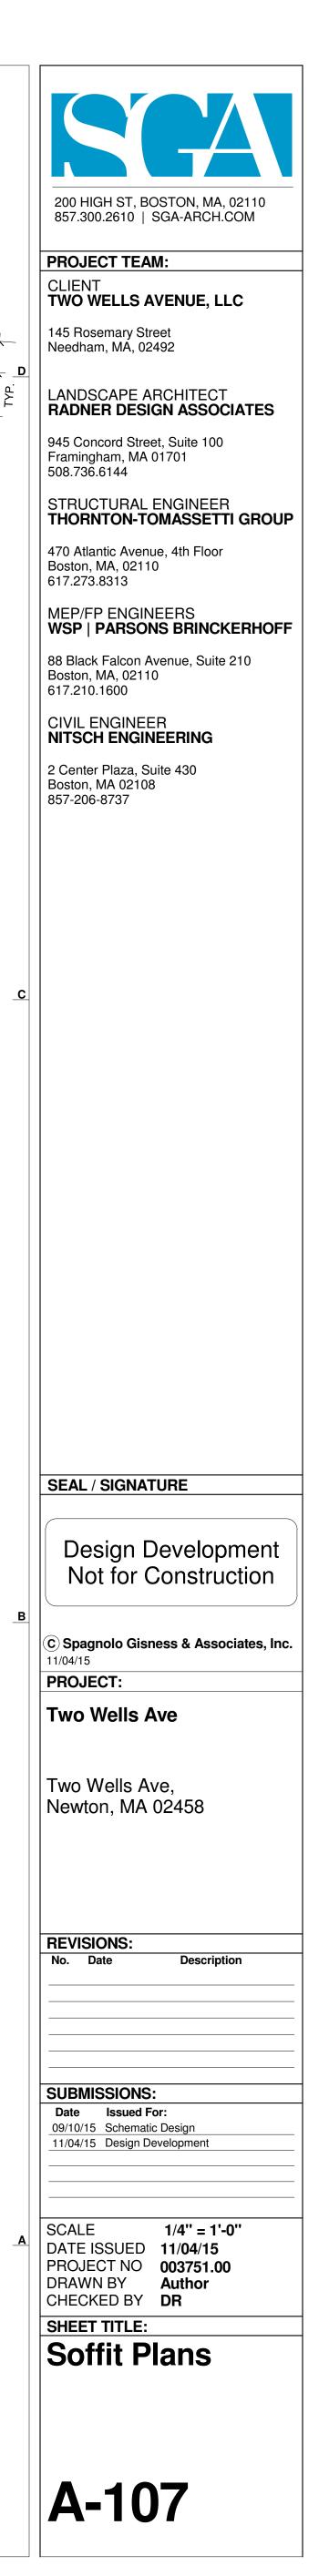
ANGLE CHANGE.

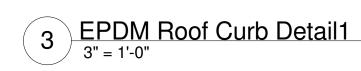
4 EPDM Roof Drain Detail 3" = 1'-0"



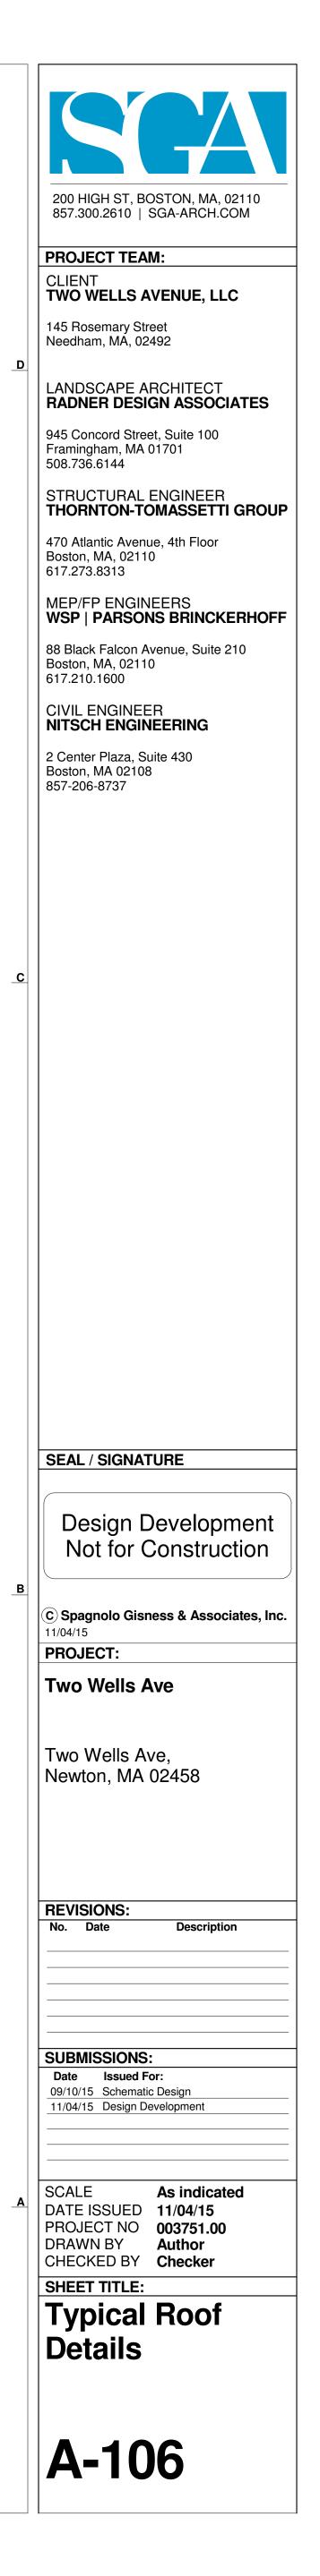

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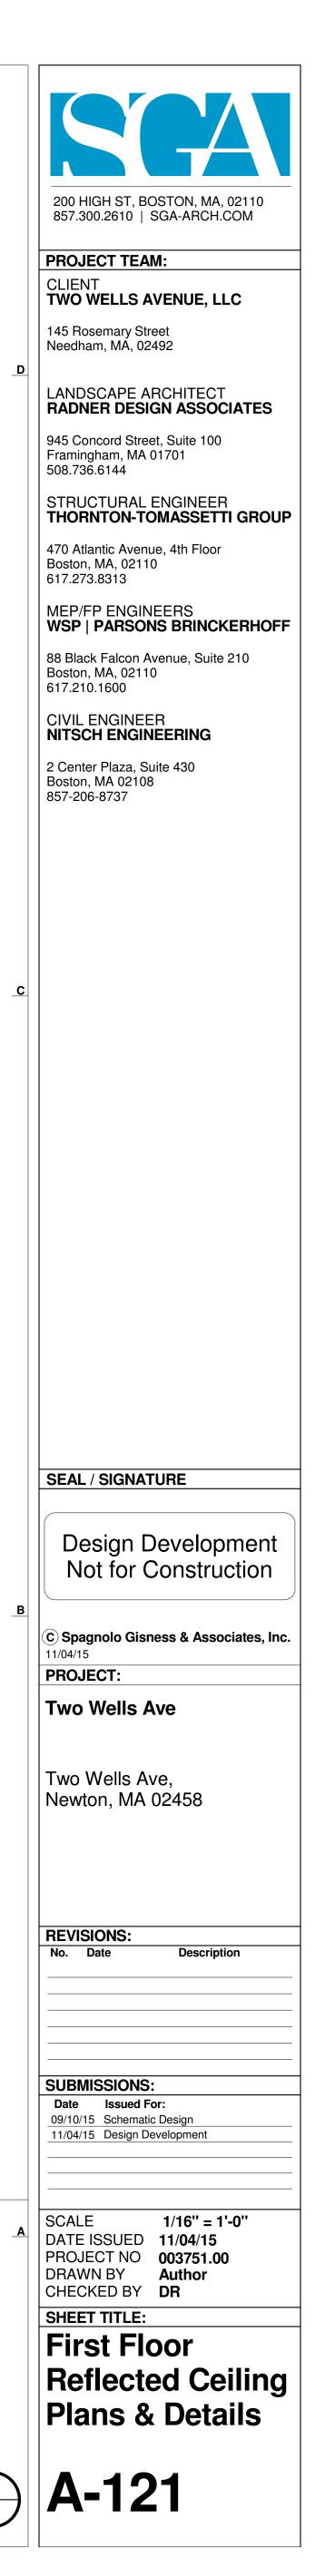


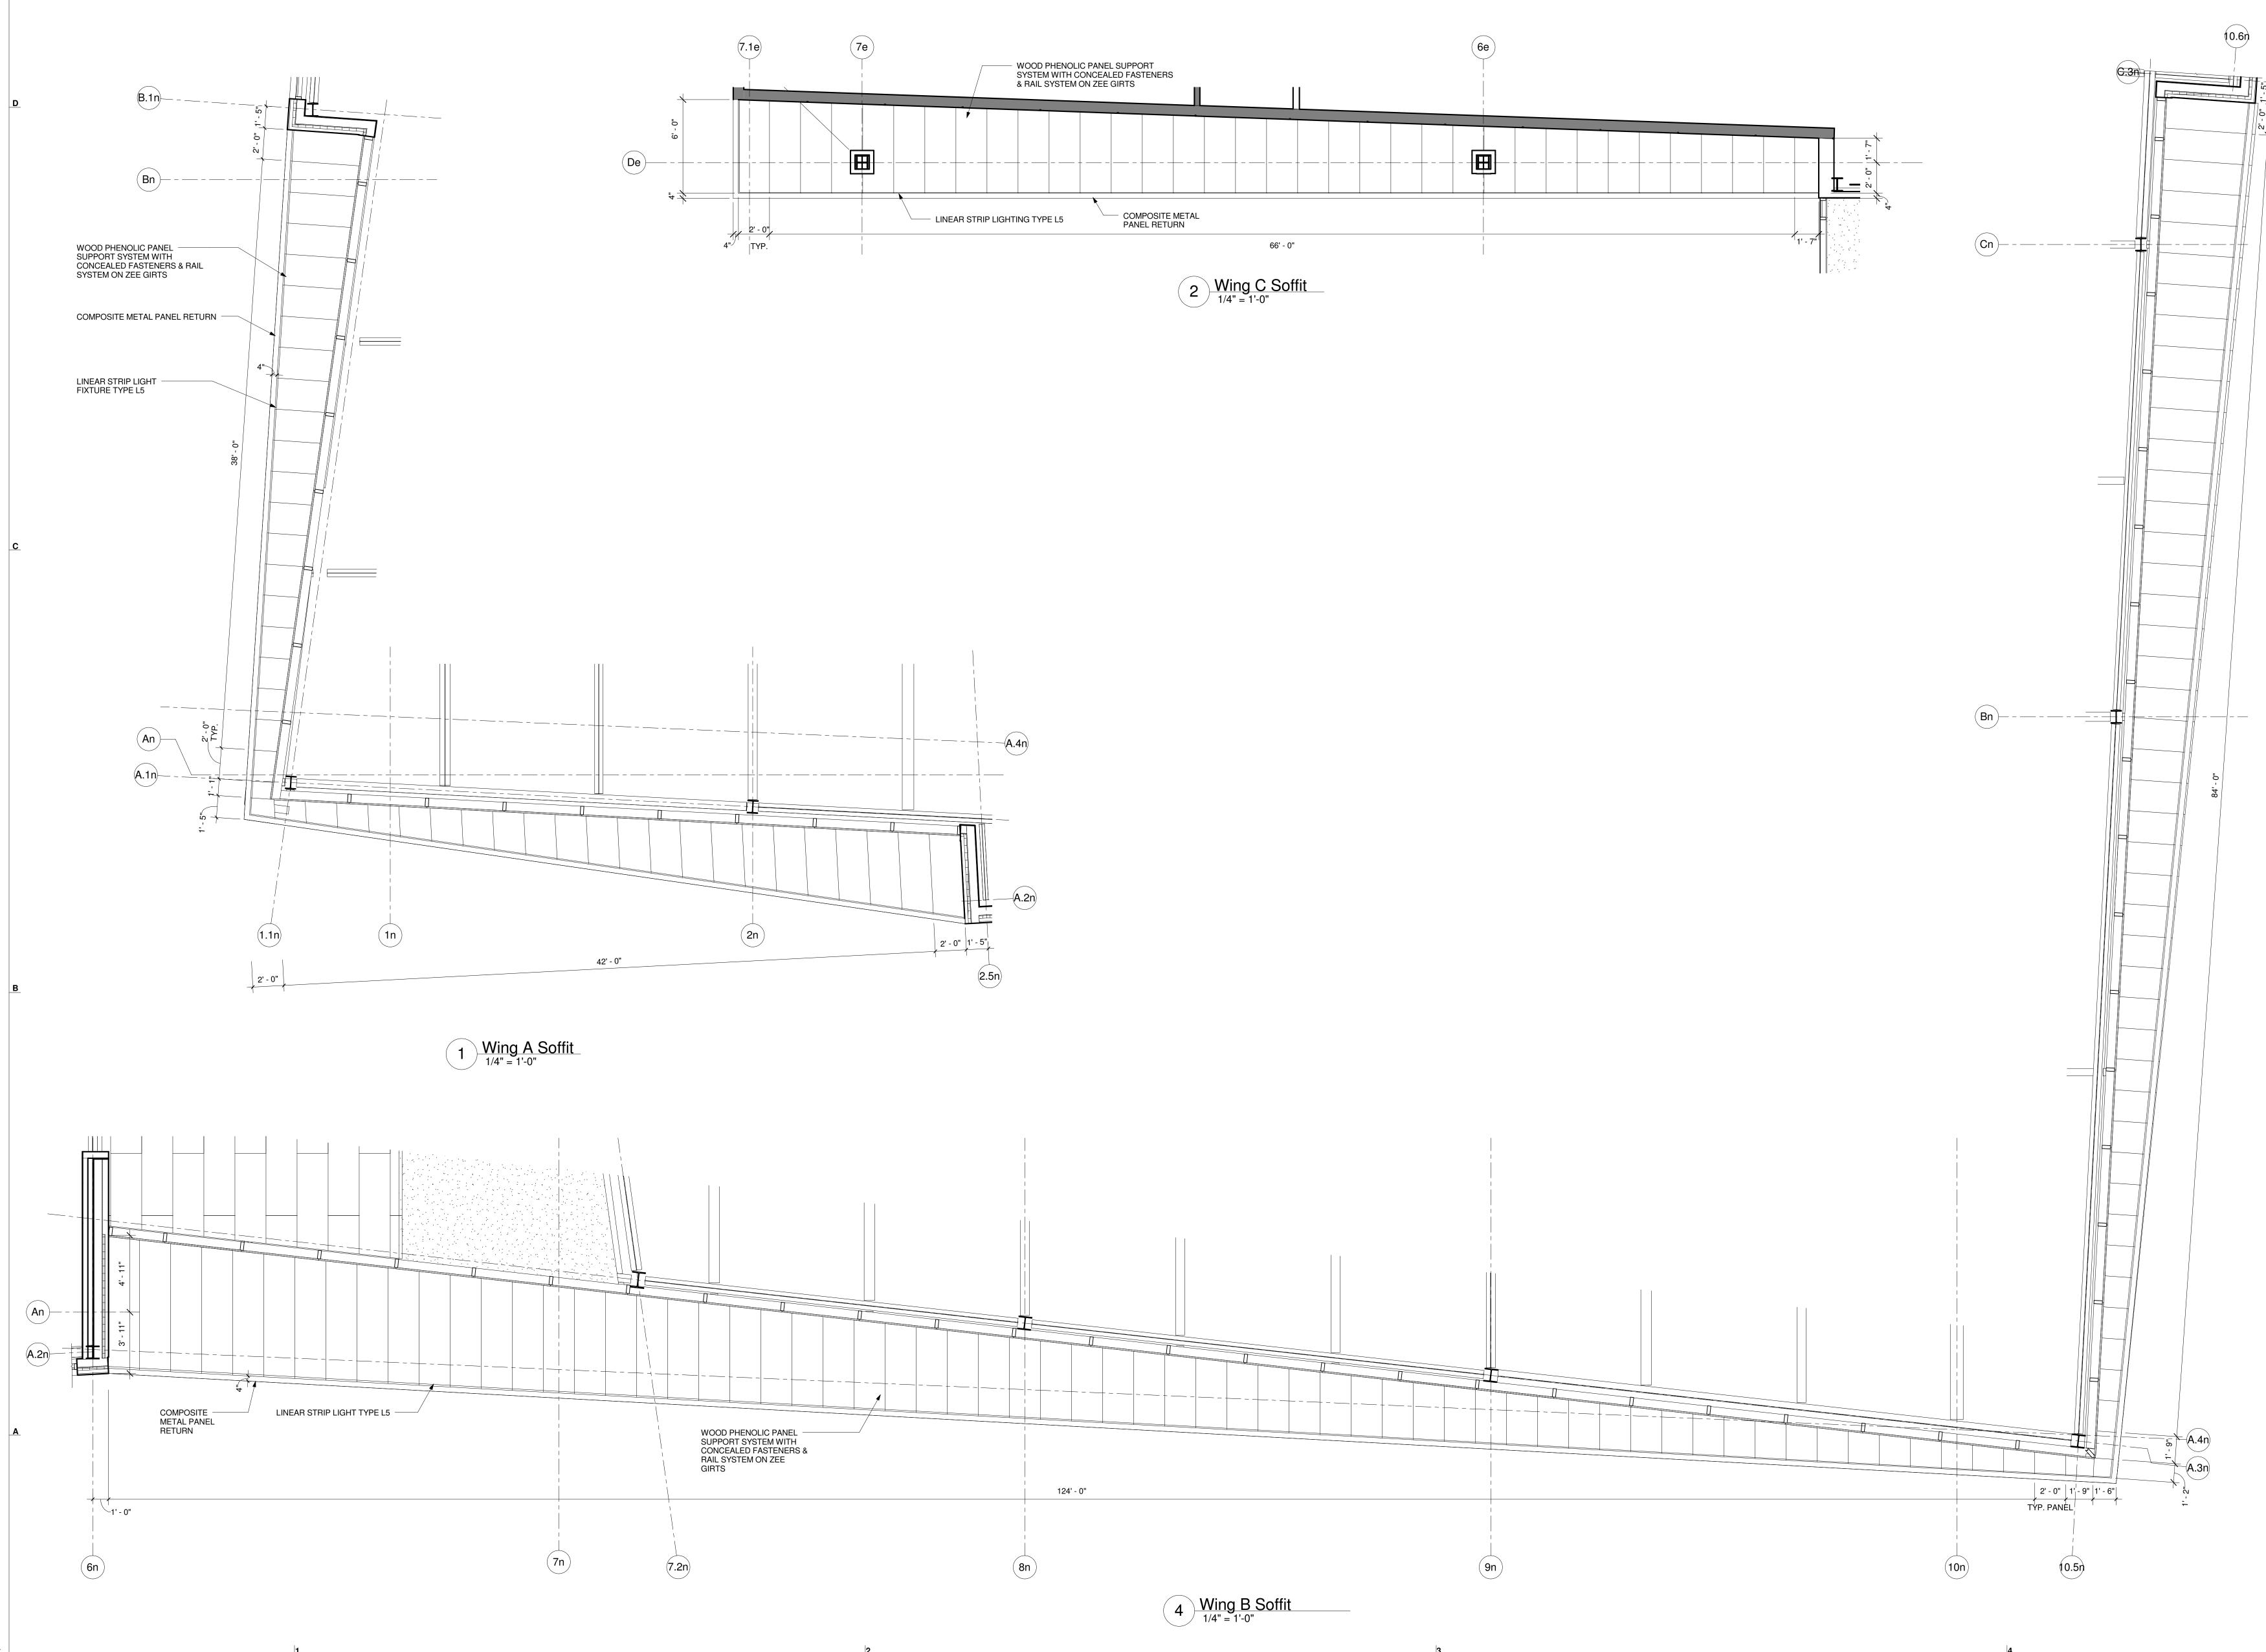
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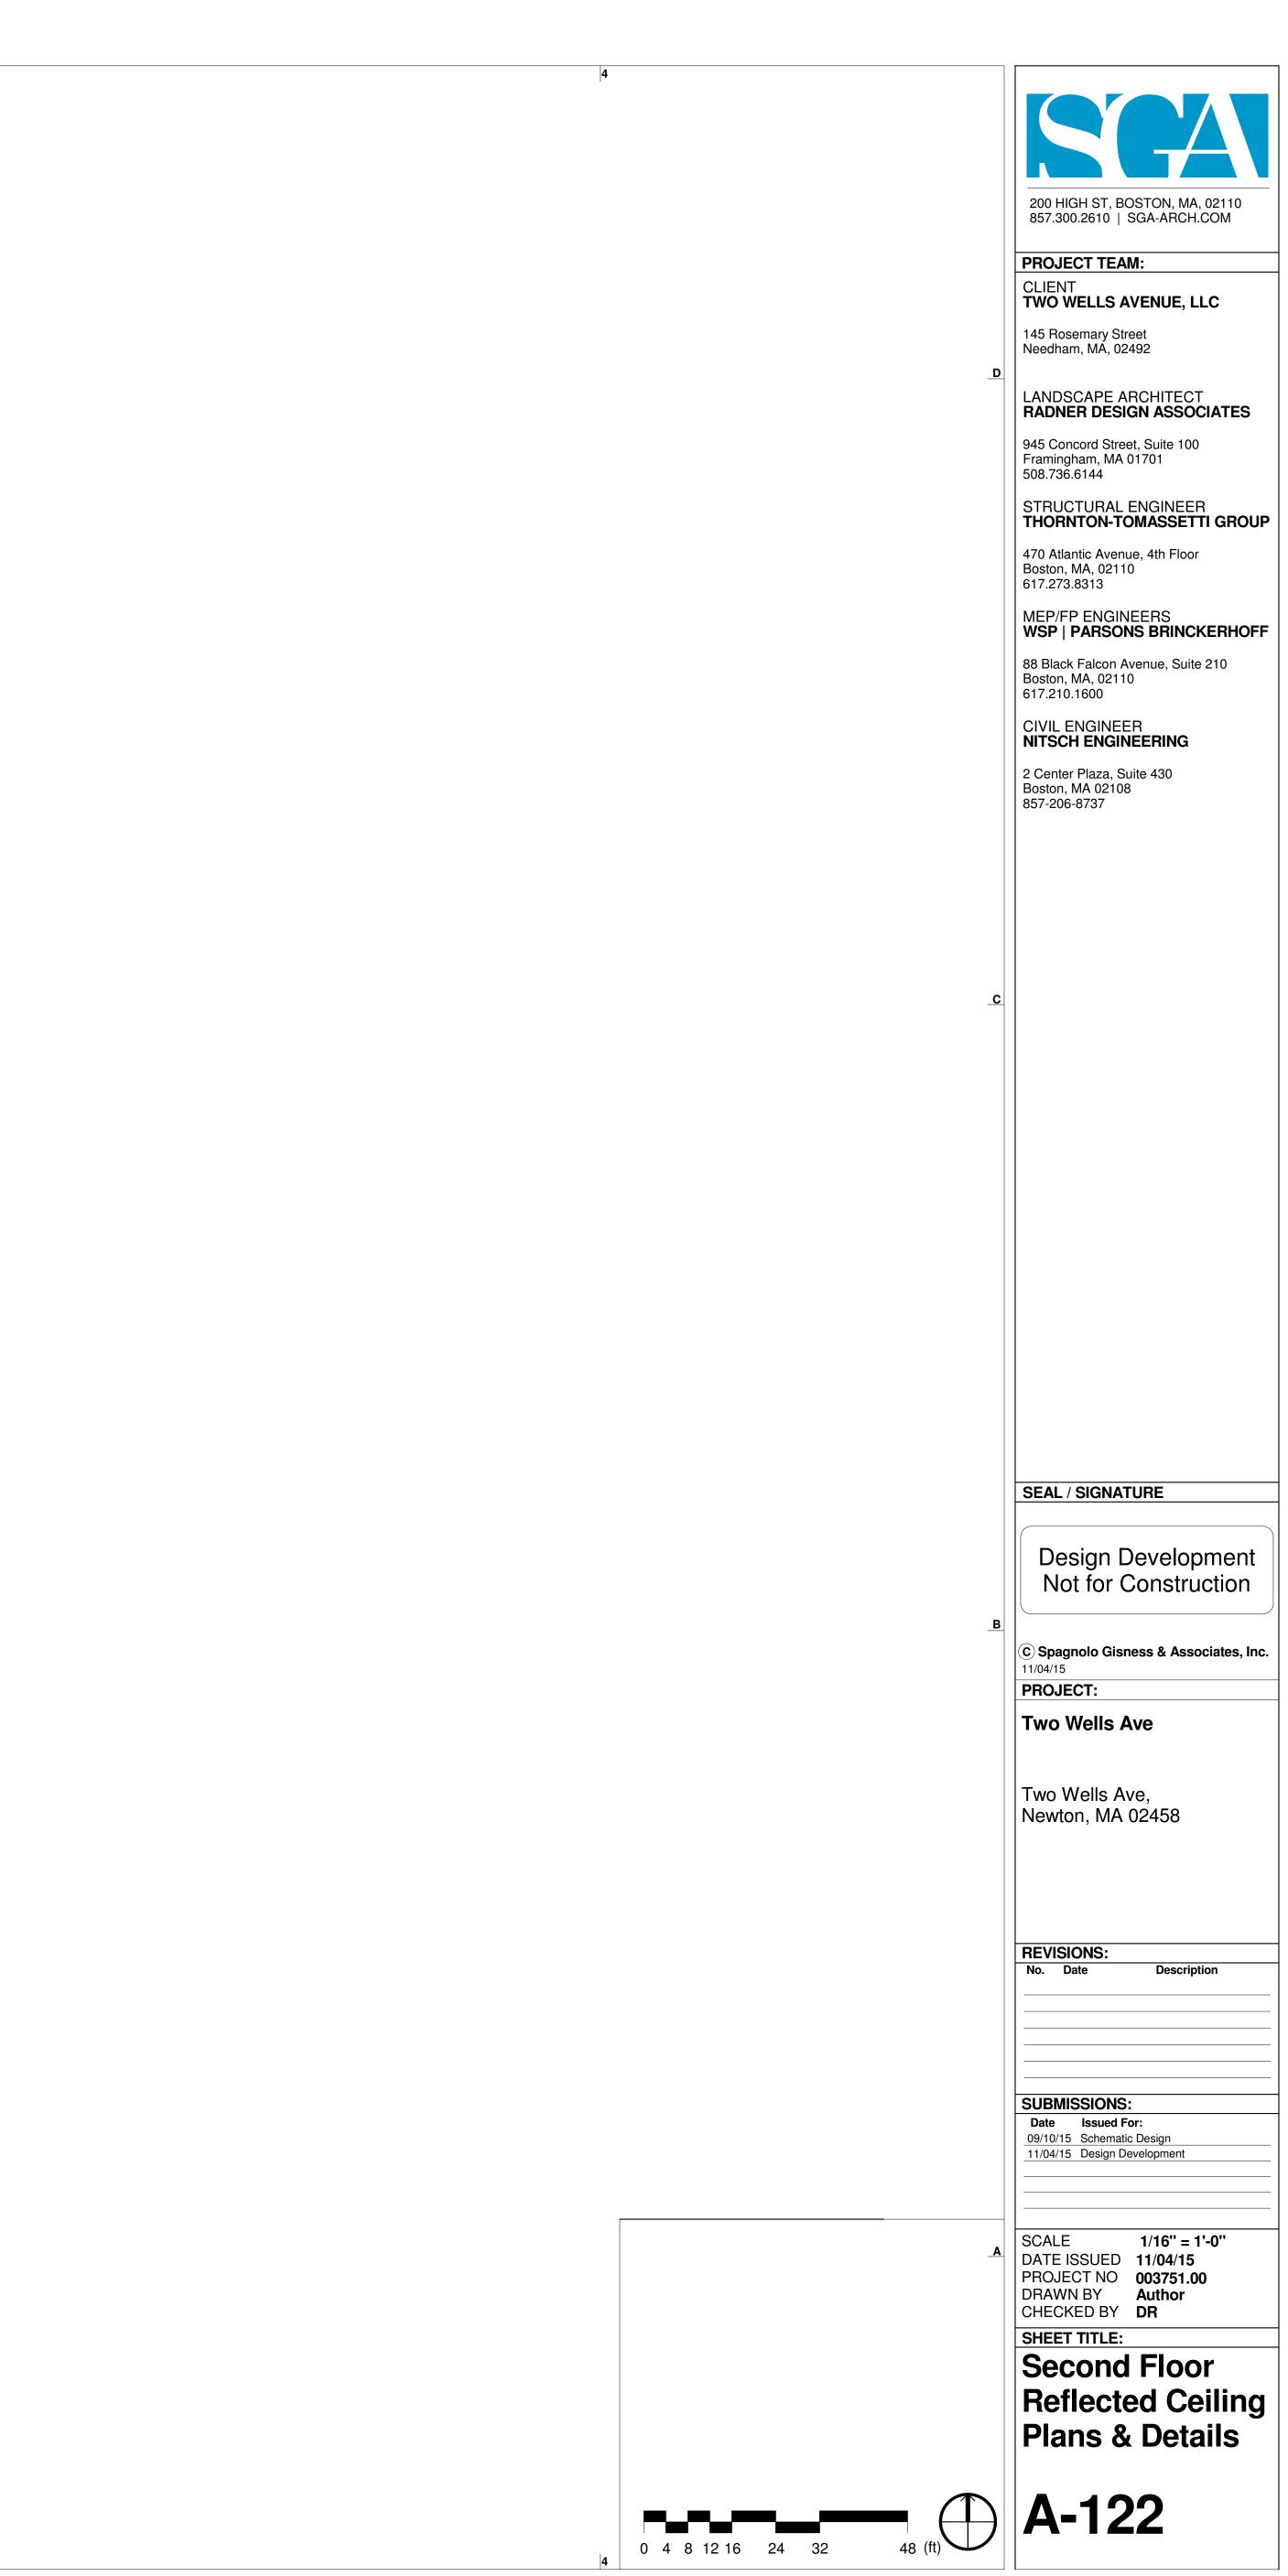
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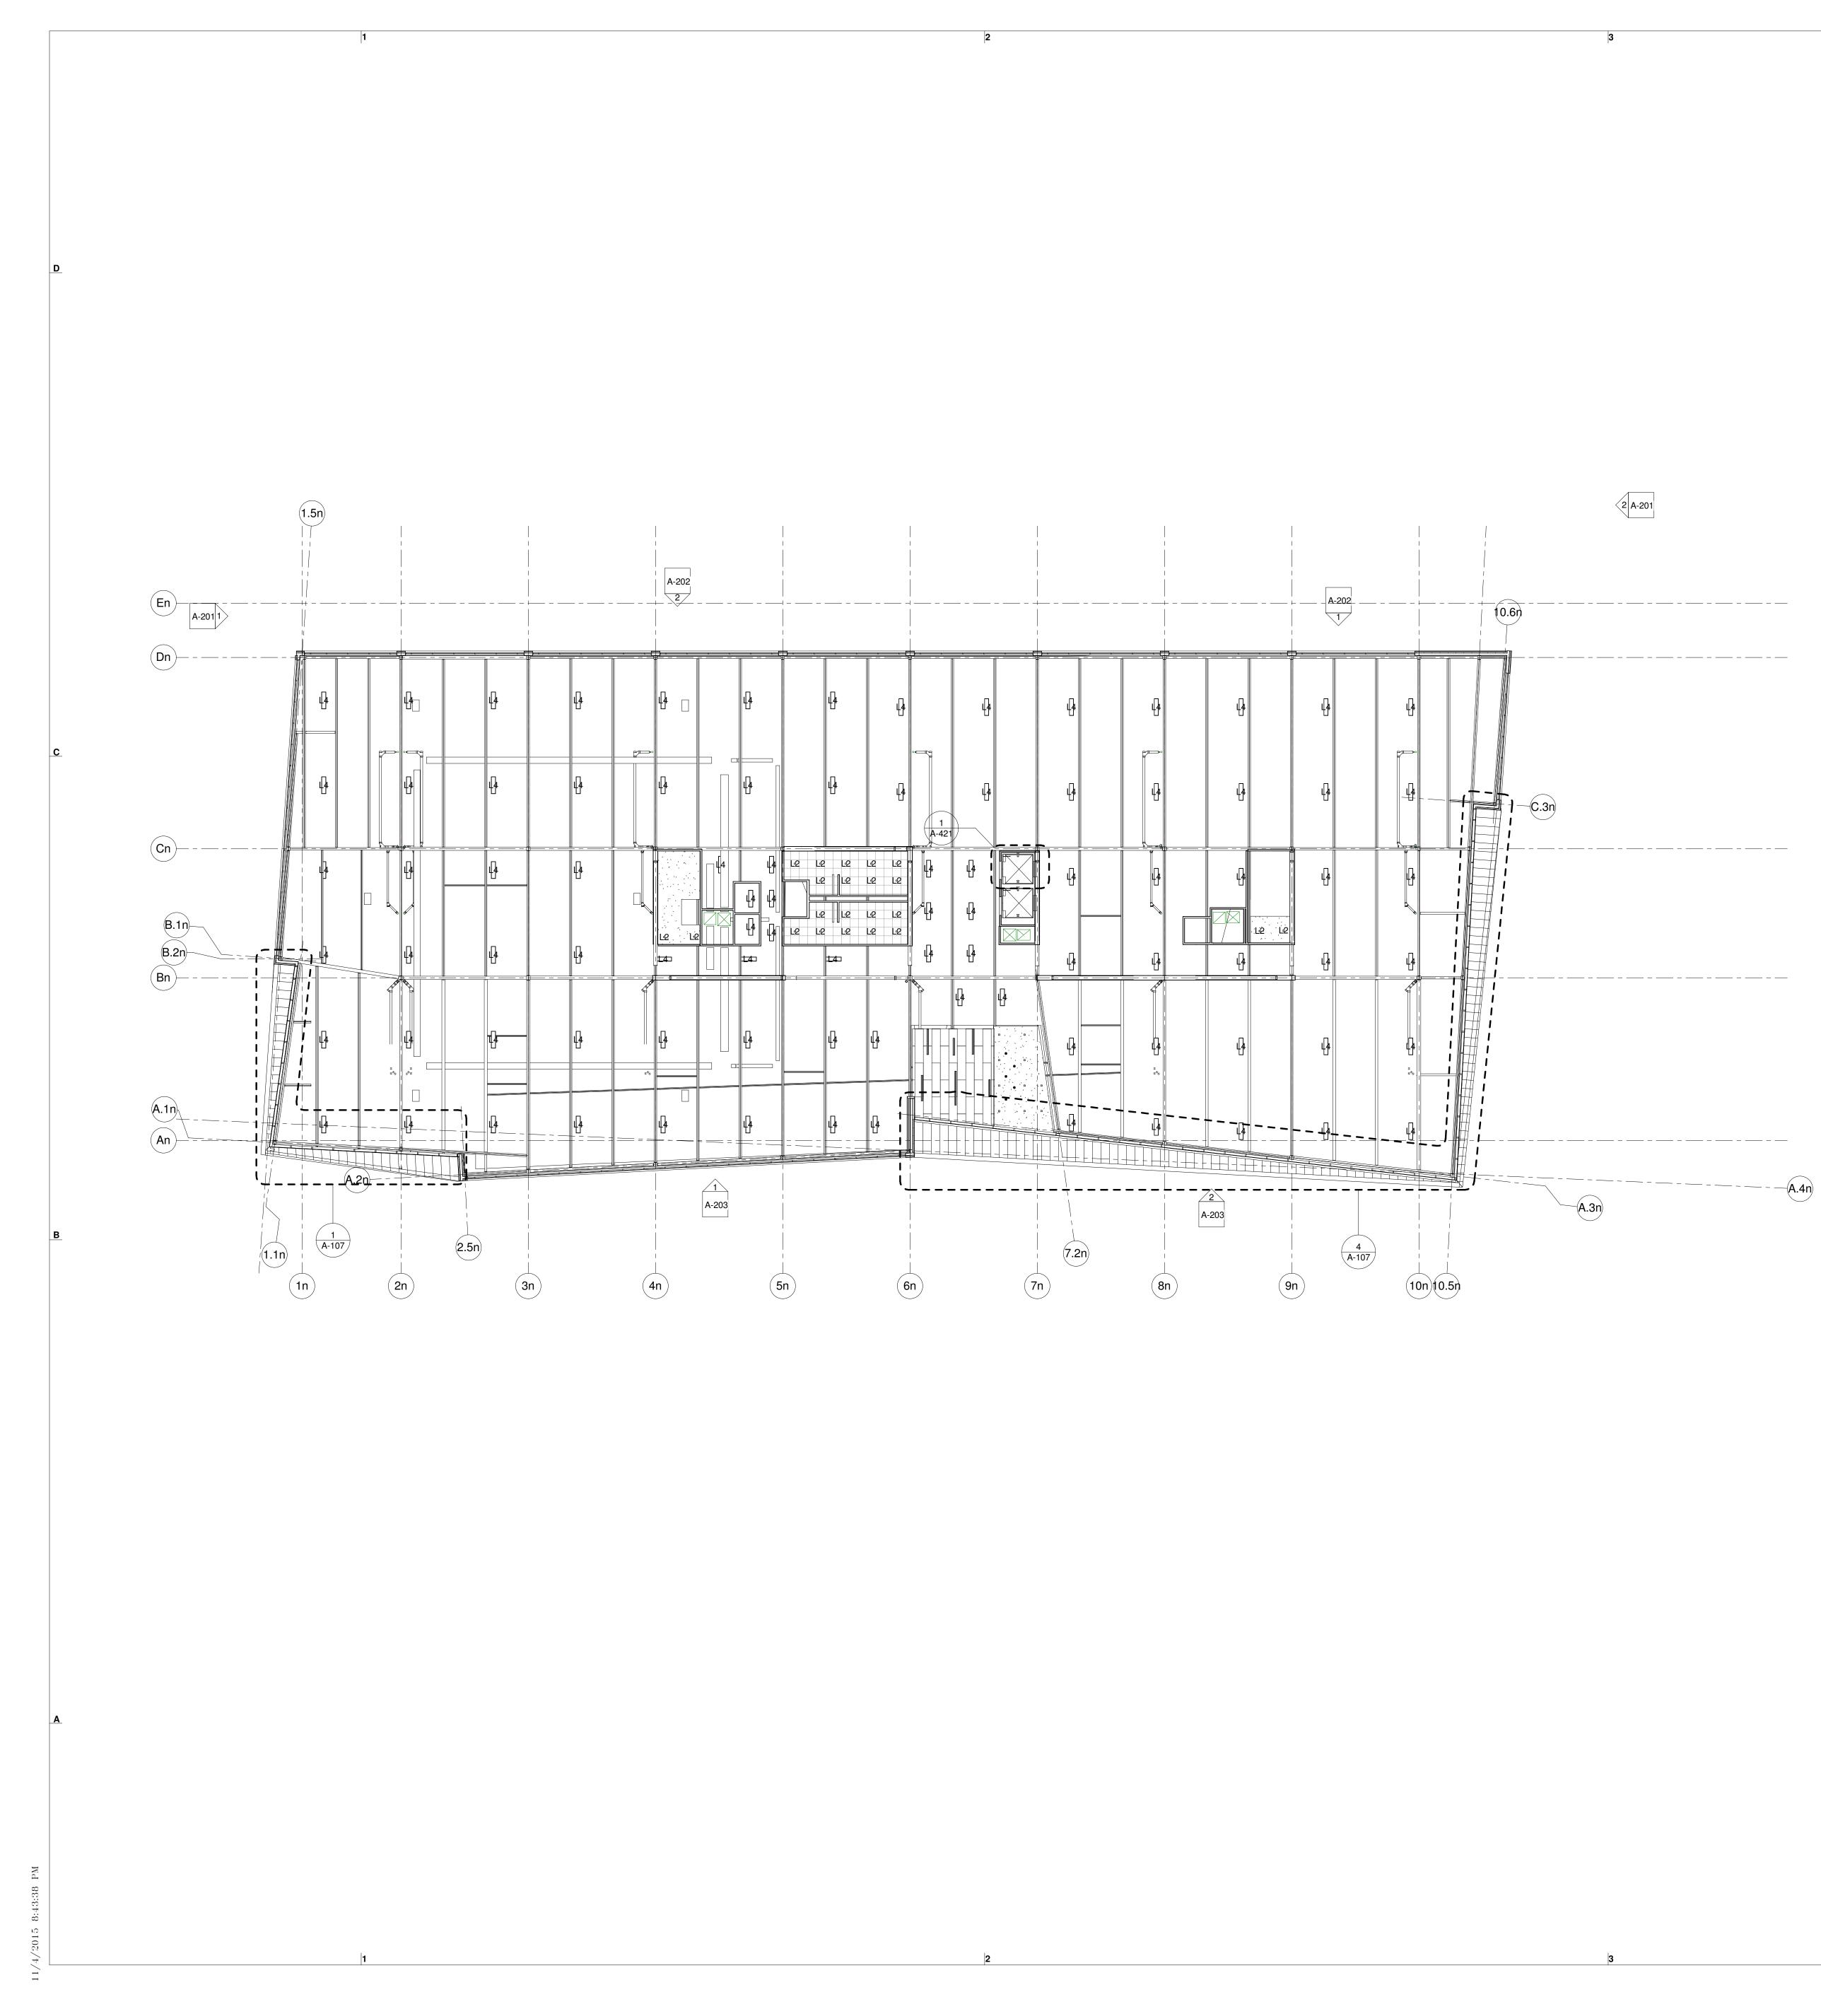


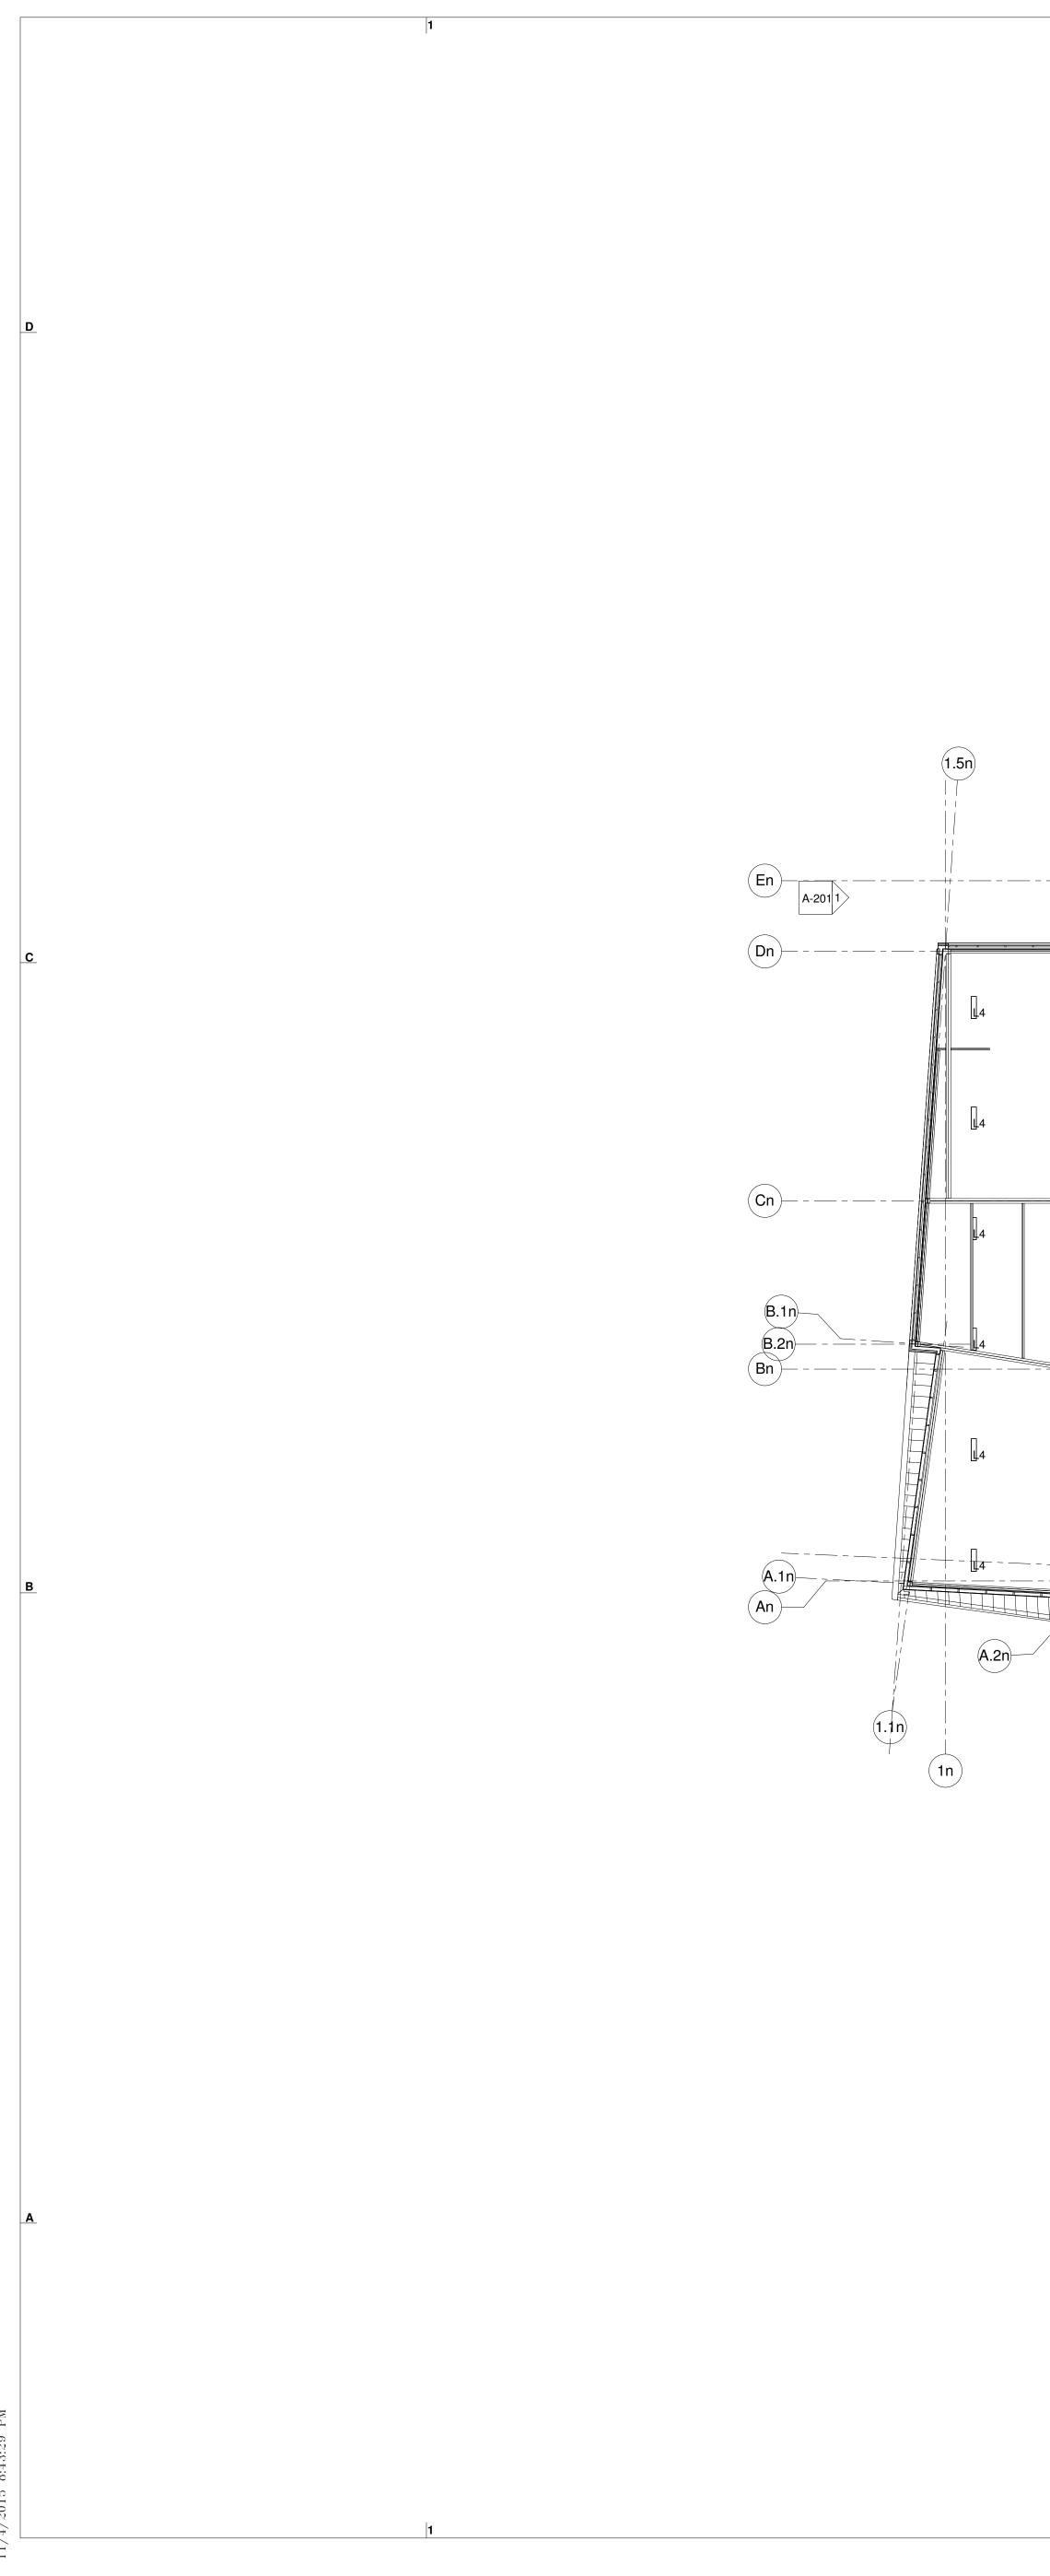
A SCALE 1/16 DATE ISSUED 11/04 PROJECT NO 0037? DRAWN BY Author CHECKED BY DR SHEET TITLE: First Floor Reflected C Plans & Dei A A-121









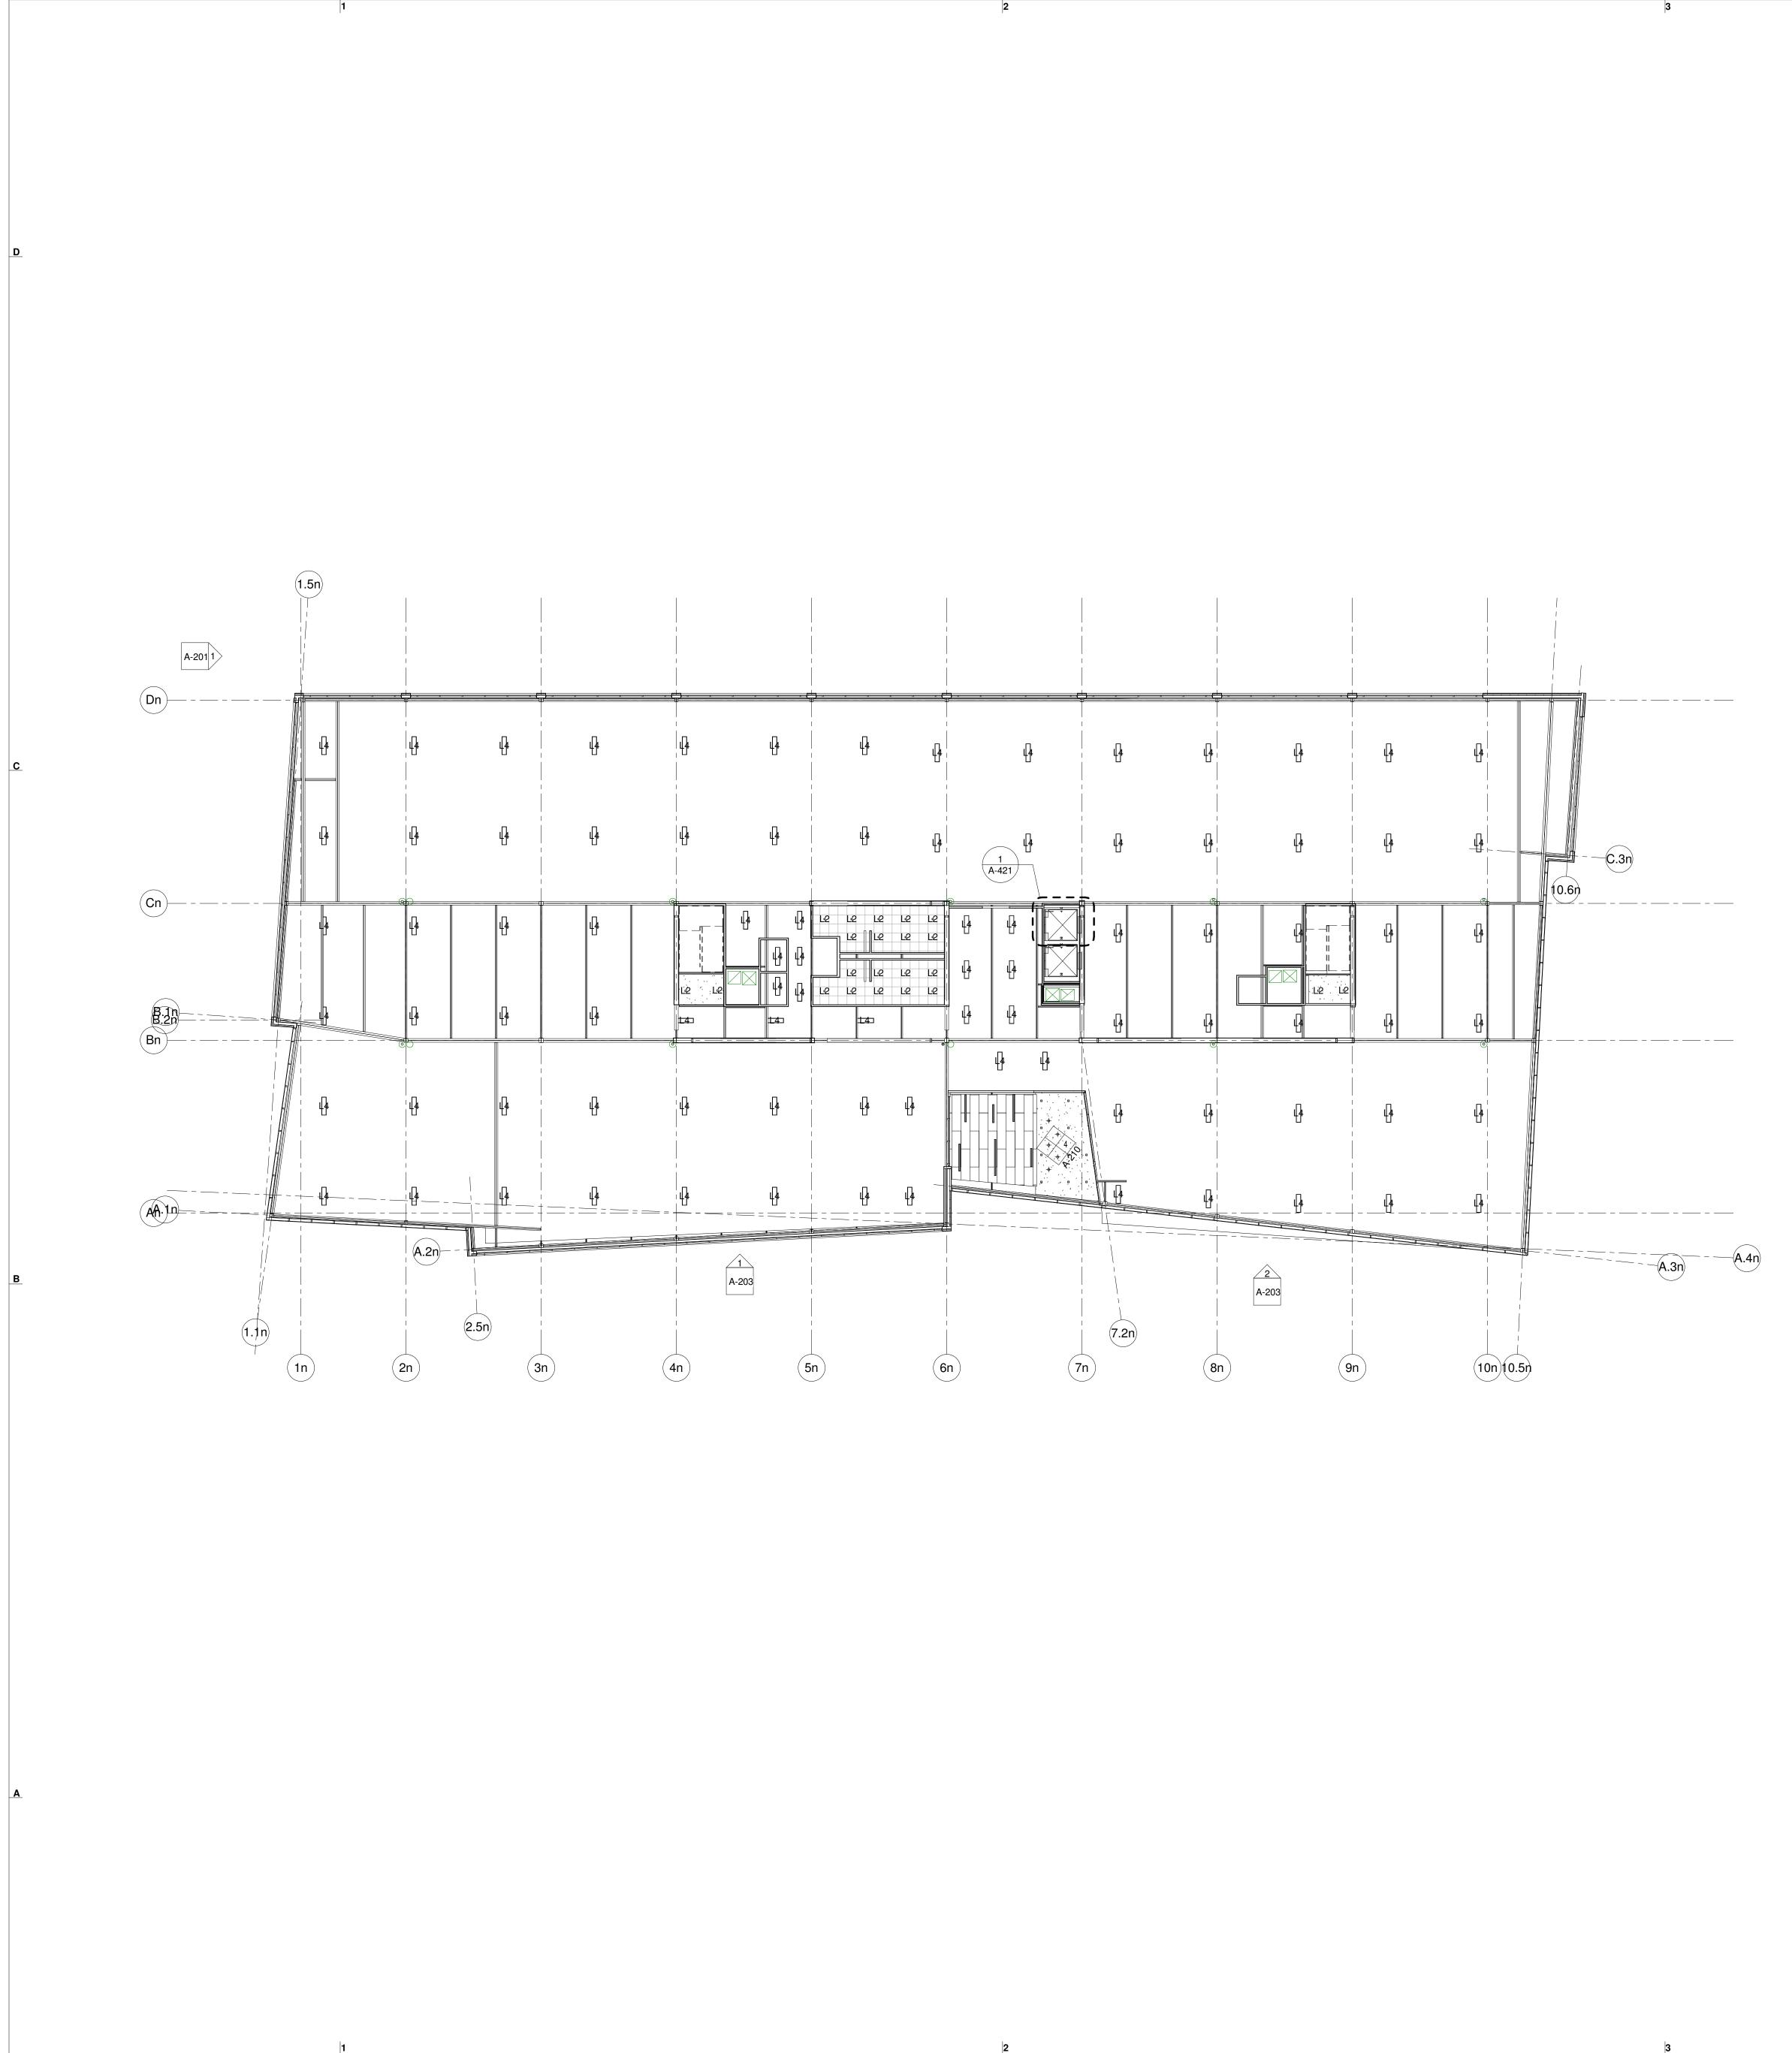

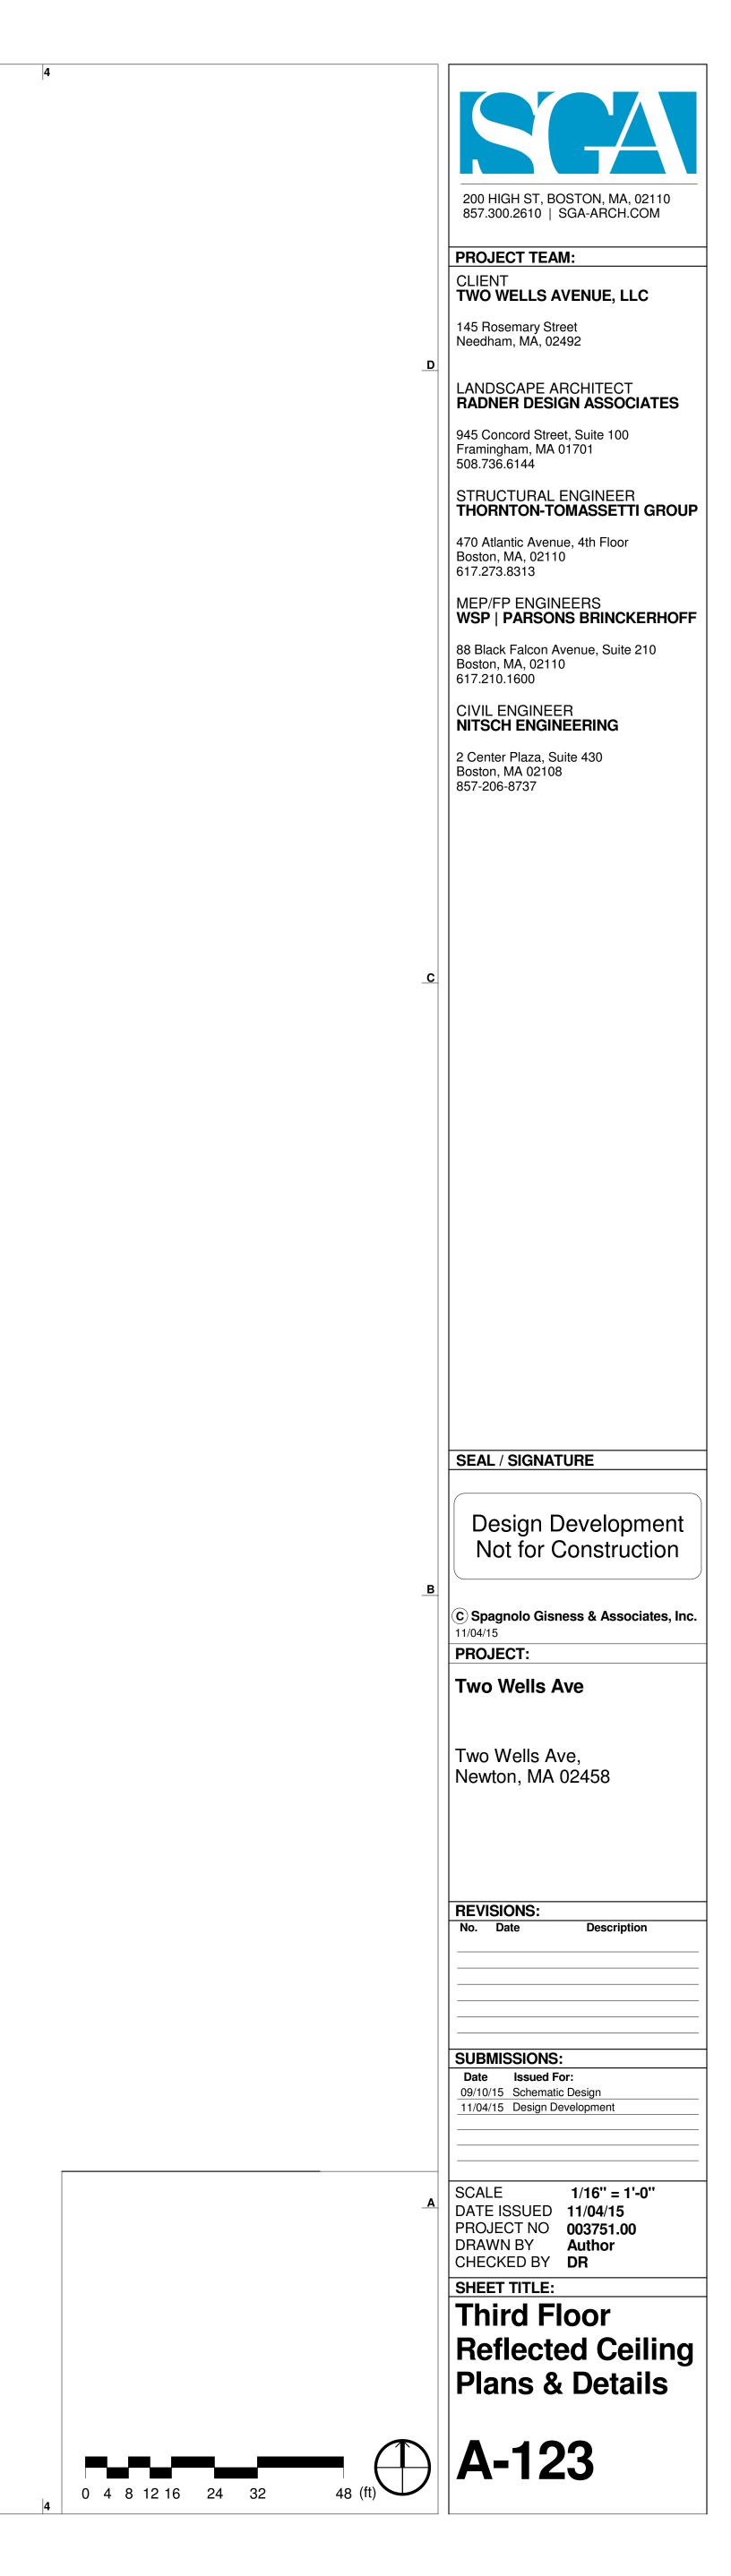


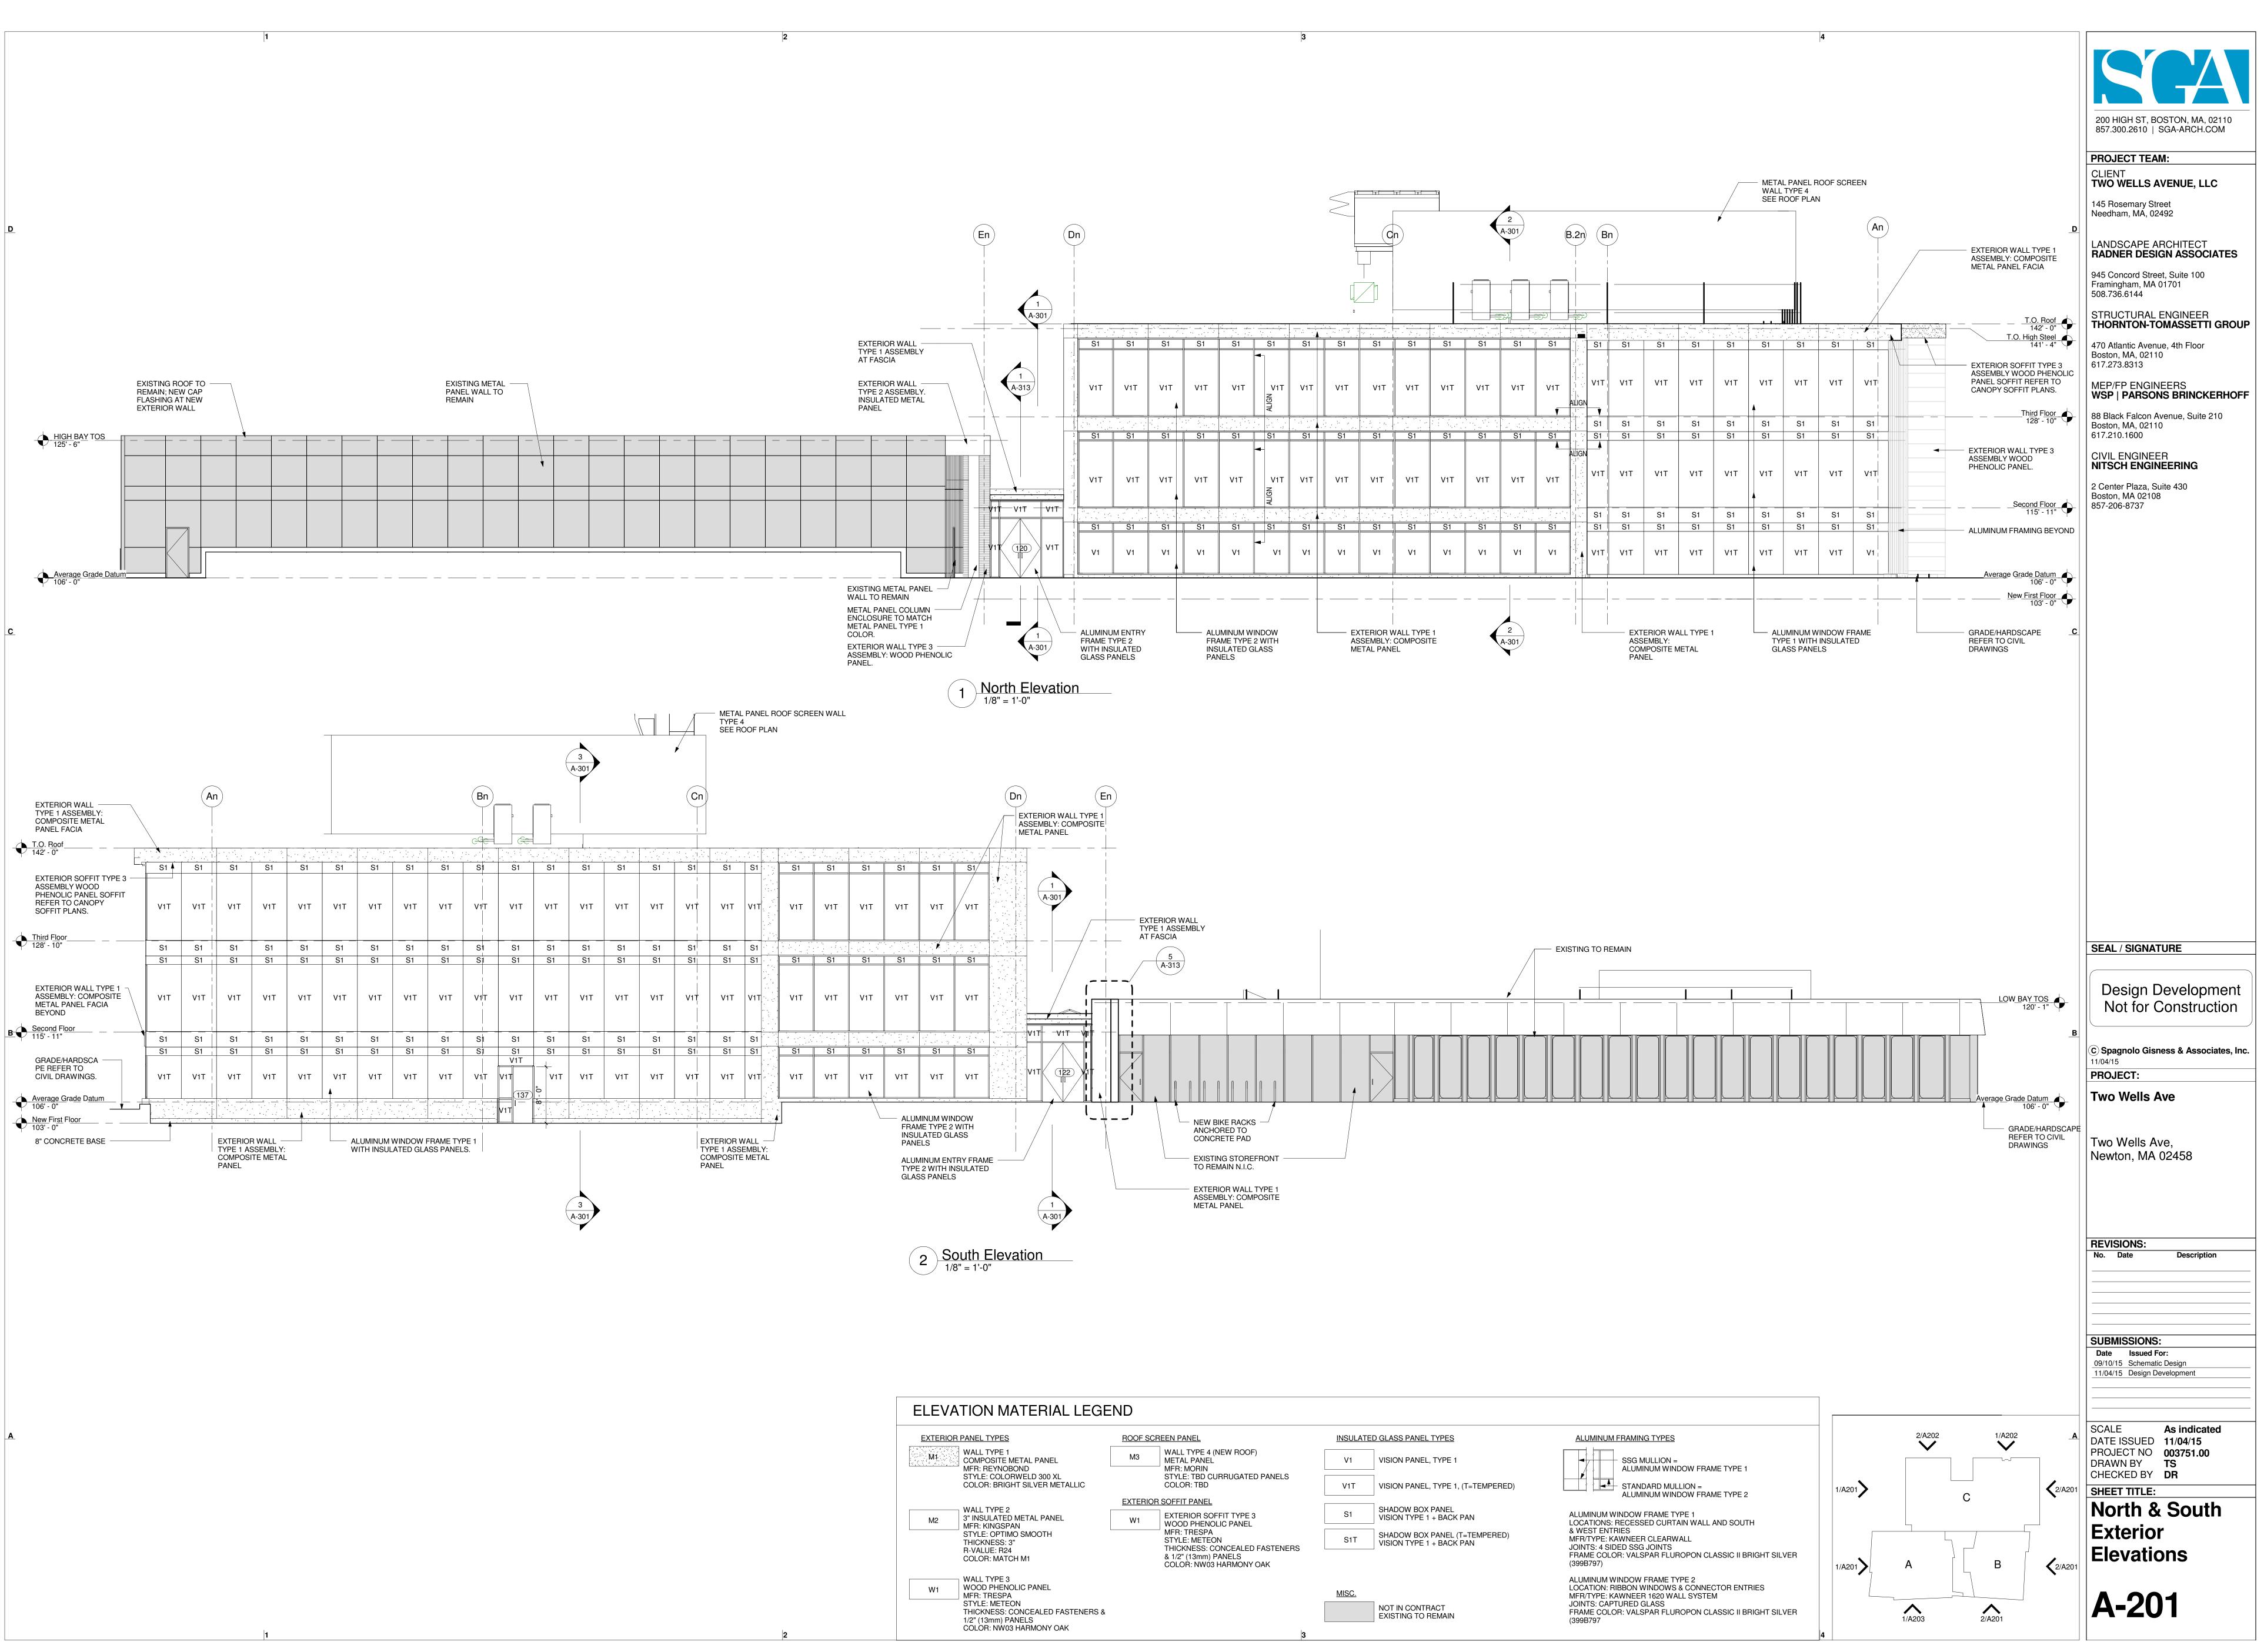


ELEVATION MATERIAL LEG	END							
EXTERIOR PANEL TYPES	ROOF S	SCREEN PANEL	INSULA <sup>-</sup>	TED GLASS PANEL TYPES	ALUMINUM FRAMING TYPES		2/A202	1/A202
WALL TYPE 1 COMPOSITE METAL PANEL MFR: REYNOBOND	M3	WALL TYPE 4 (NEW ROOF) METAL PANEL MFR: MORIN	V1	VISION PANEL, TYPE 1	SSG MULLION = ALUMINUM WINDOW FRAME TYPE 1		•	
STYLE: COLORWELD 300 XL COLOR: BRIGHT SILVER METALLIC		STYLE: TBD CURRUGATED PANELS COLOR: TBD	V1T	VISION PANEL, TYPE 1, (T=TEMPERED)	STANDARD MULLION = ALUMINUM WINDOW FRAME TYPE 2	1/A201		
WALL TYPE 2 3" INSULATED METAL PANEL		OR SOFFIT PANEL  EXTERIOR SOFFIT TYPE 3	S1	SHADOW BOX PANEL VISION TYPE 1 + BACK PAN	ALUMINUM WINDOW FRAME TYPE 1			C
MFR: KINGSPAN STYLE: OPTIMO SMOOTH	W1     WOOD PHENOLIC PANEL       W1     WOOD PHENOLIC PANEL       LE: OPTIMO SMOOTH     MFR: TRESPA       CKNESS: 3"     STYLE: METEON       ALUE: R24     THICKNESS: CONCEALED FA       OB: MATCH M1     & 1/2" (13mm) PANELS	WOOD PHENOLIC PANEL MFR: TRESPA	S1T	SHADOW BOX PANEL (T=TEMPERED)	LOCATIONS: RECESSED CURTAIN WALL AND SOUTH & WEST ENTRIES MFR/TYPE: KAWNEER CLEARWALL			
R-VALUE: R24 COLOR: MATCH M1		THICKNESS: CONCEALED FASTENERS		VISION TYPE 1 + BACK PAN	JOINTS: 4 SIDED SSG JOINTS FRAME COLOR: VALSPAR FLUROPON CLASSIC II BRIGHT SILVER (399B797)		A	В
WALL TYPE 3 WOOD PHENOLIC PANEL MFR: TRESPA		OCLOTI. NWOSTIANIMONT CAR	MISC.		ALUMINUM WINDOW FRAME TYPE 2 LOCATION: RIBBON WINDOWS & CONNECTOR ENTRIES MFR/TYPE: KAWNEER 1620 WALL SYSTEM	1/A201		
STYLE: METEON THICKNESS: CONCEALED FASTENERS & 1/2" (13mm) PANELS COLOR: NW03 HARMONY OAK	&	a		NOT IN CONTRACT EXISTING TO REMAIN	JOINTS: CAPTURED GLASS FRAME COLOR: VALSPAR FLUROPON CLASSIC II BRIGHT SILVER (399B797		1/A203	2/A201

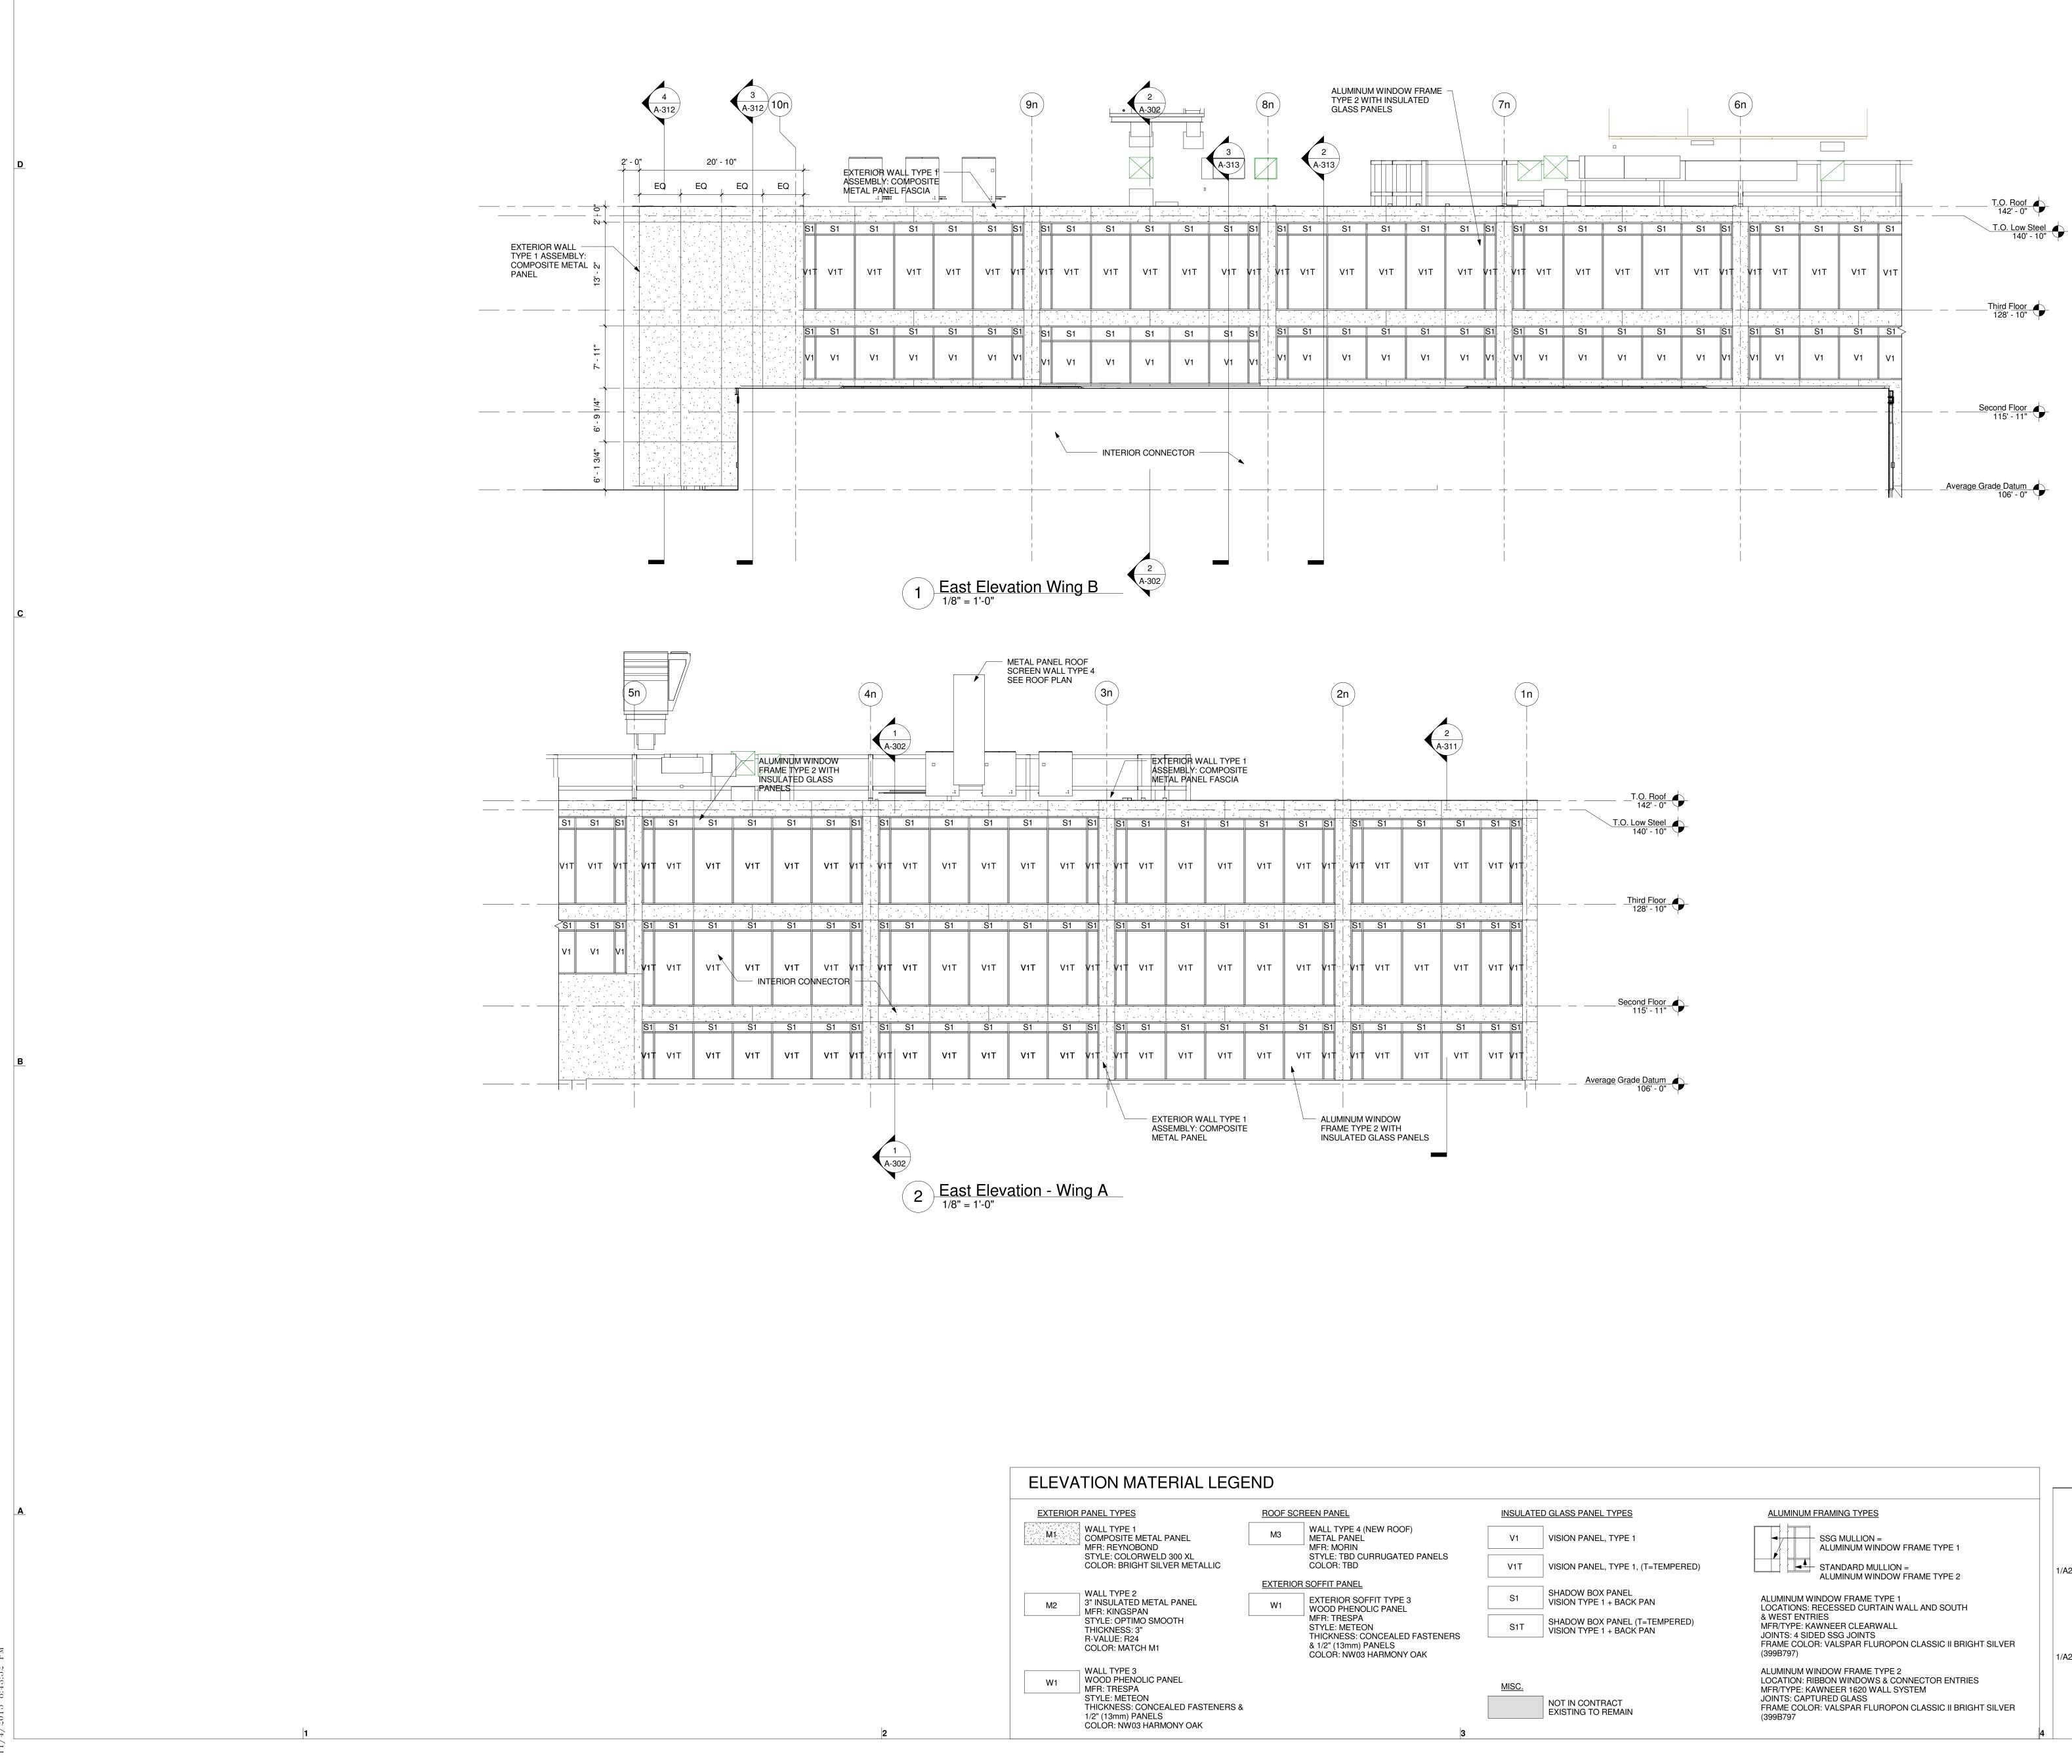


ELEVATION MATERIAL LEG	END						
EXTERIOR PANEL TYPES	ROOF SCREEN PANEL	INSULAT	ED GLASS PANEL TYPES			2/A202	1/A202
M1 M1 WALL TYPE 1 COMPOSITE METAL PANEL MFR: REYNOBOND	M3 WALL TYPE 4 (NEW ROOF) METAL PANEL MFR: MORIN	V1	VISION PANEL, TYPE 1	SSG MULLION = ALUMINUM WINDOW FRAME TYPE 1			
STYLE: COLORWELD 300 XL COLOR: BRIGHT SILVER METALLIC	STYLE: TBD CURRUGATED PANELS COLOR: TBD	V1T	VISION PANEL, TYPE 1, (T=TEMPERED)	STANDARD MULLION = ALUMINUM WINDOW FRAME TYPE 2	1/A201		C
M2 WALL TYPE 2 3" INSULATED METAL PANEL MFR: KINGSPAN	EXTERIOR SOFFIT PANEL W1 EXTERIOR SOFFIT TYPE 3 W00D PHENOLIC PANEL	S1	SHADOW BOX PANEL VISION TYPE 1 + BACK PAN	ALUMINUM WINDOW FRAME TYPE 1 LOCATIONS: RECESSED CURTAIN WALL AND SOUTH			
STYLE: OPTIMO SMOOTH THICKNESS: 3" R-VALUE: R24	MFR: TRESPA STYLE: METEON THICKNESS: CONCEALED FASTENERS	S1T	SHADOW BOX PANEL (T=TEMPERED) VISION TYPE 1 + BACK PAN	& WEST ENTRIES MFR/TYPE: KAWNEER CLEARWALL JOINTS: 4 SIDED SSG JOINTS			
COLOR: MATCH M1			1/A201	A	B .		
WALL TYPE 3 WOOD PHENOLIC PANEL MFR: TRESPA		MISC.		ALUMINUM WINDOW FRAME TYPE 2 LOCATION: RIBBON WINDOWS & CONNECTOR ENTRIES MFR/TYPE: KAWNEER 1620 WALL SYSTEM			
STYLE: METEON THICKNESS: CONCEALED FASTENERS & 1/2" (13mm) PANELS	&		NOT IN CONTRACT EXISTING TO REMAIN	JOINTS: CAPTURED GLASS FRAME COLOR: VALSPAR FLUROPON CLASSIC II BRIGHT SILVER (399B797		1/A203	2/A201
COLOR: NW03 HARMONY OAK	3				4		

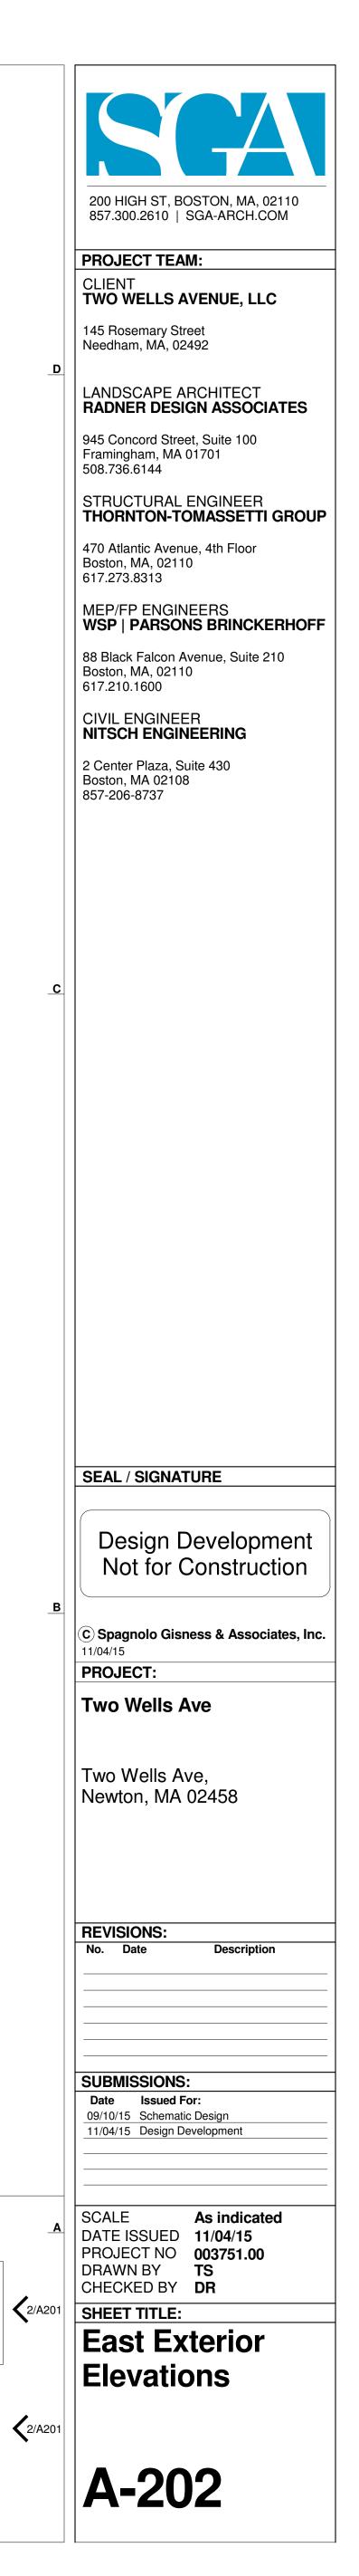


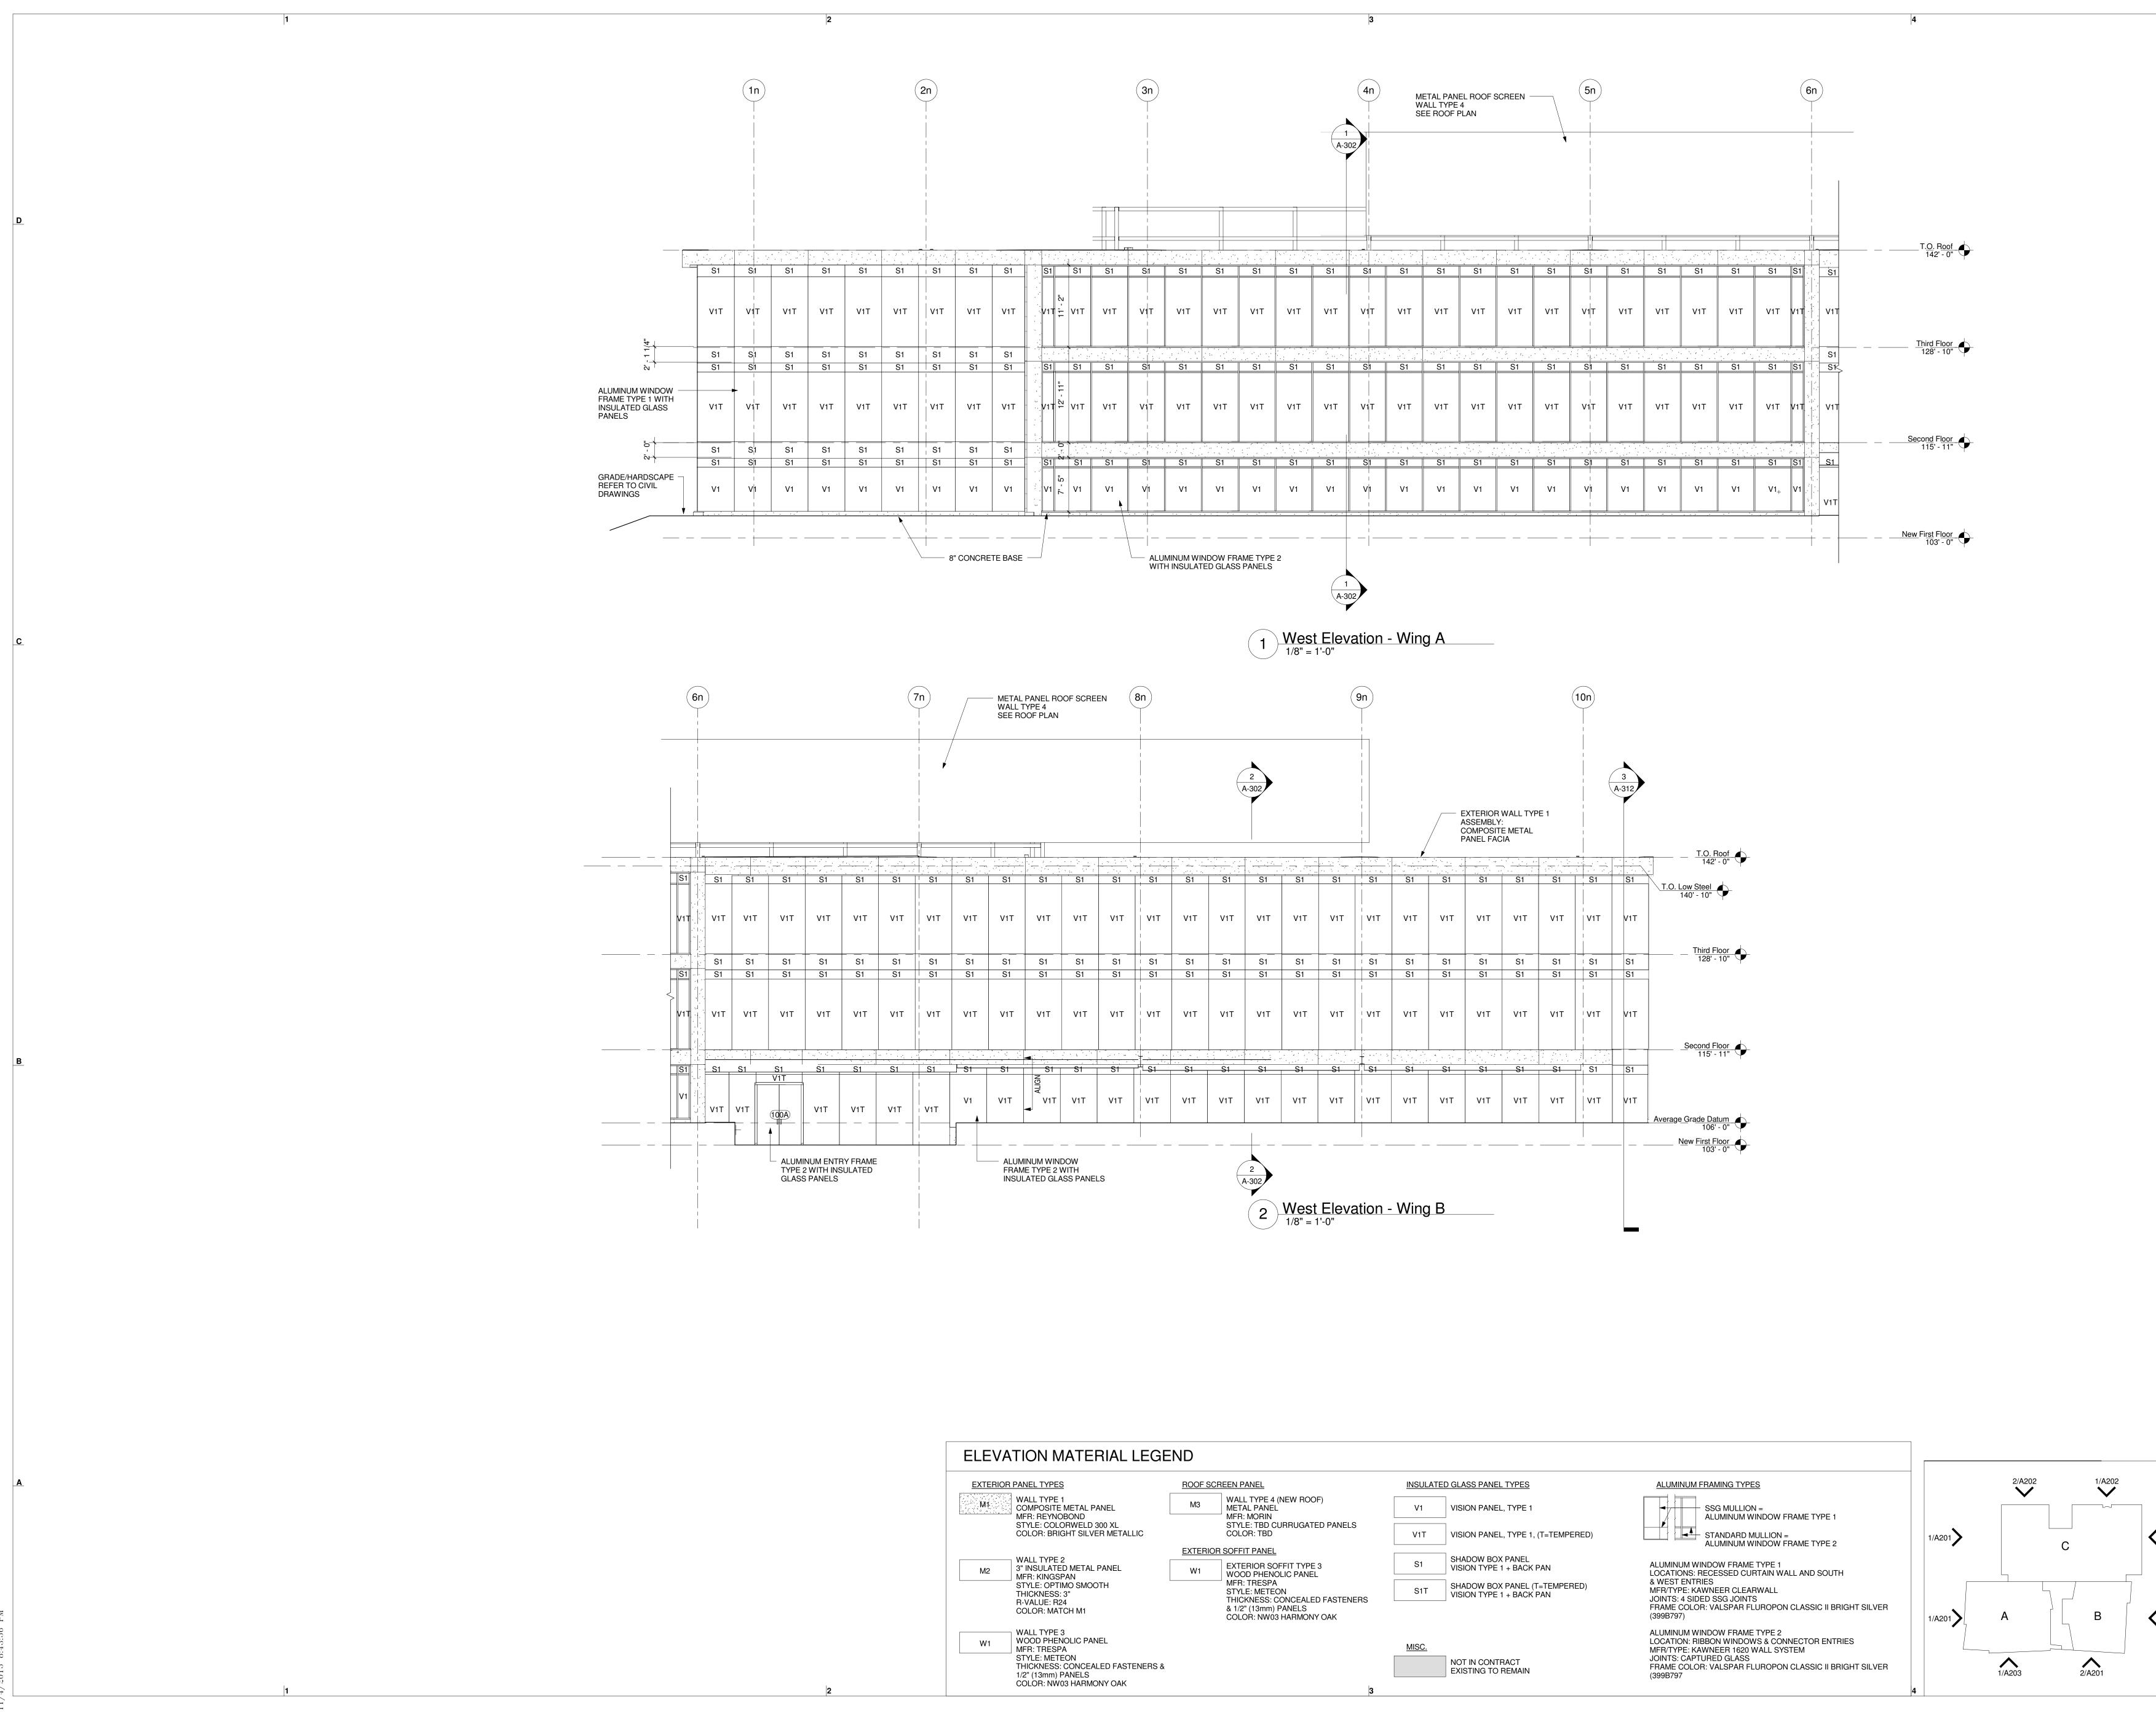


	6n							<b>7</b> n		WALL	PANEL RC TYPE 4 DOF PLAN	OF SCRE	EN	8n					(	9n	
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/11		V1T	V1T	V1T	V1T	V1T	V1T	V1T	V1T	V1T	V1T	V1T	V1T	V1T	V1T	V1T	V1T	V1T	V1T	V1T	V1T
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/11		V1T	V1T	V1T	V1T	V1T	V1T	V1T	V1T	V1T	V1T	V1T	V1T	V1T	V1T	V1T	V1T	V1T	V1T	V1T	V1T
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<u>S1</u> )		<u>S1</u>	S1	<u>S1</u> V1T	S1	S1	S1	S1	_ <del>S1</del>	S1	<u>\$1</u>	<del>\$1</del>	S1		<u>\$1</u>	<u>\$1</u>	<u>\$1</u>	S1	<u>\$1</u>	S1	S1
V1		V1T	V1T		V1T	V1T	V1T	V1T	V1	V1T	V1T	V1T	V1T	V1T	V1T	V1T	V1T	V1T	V1T	V1T	V1T
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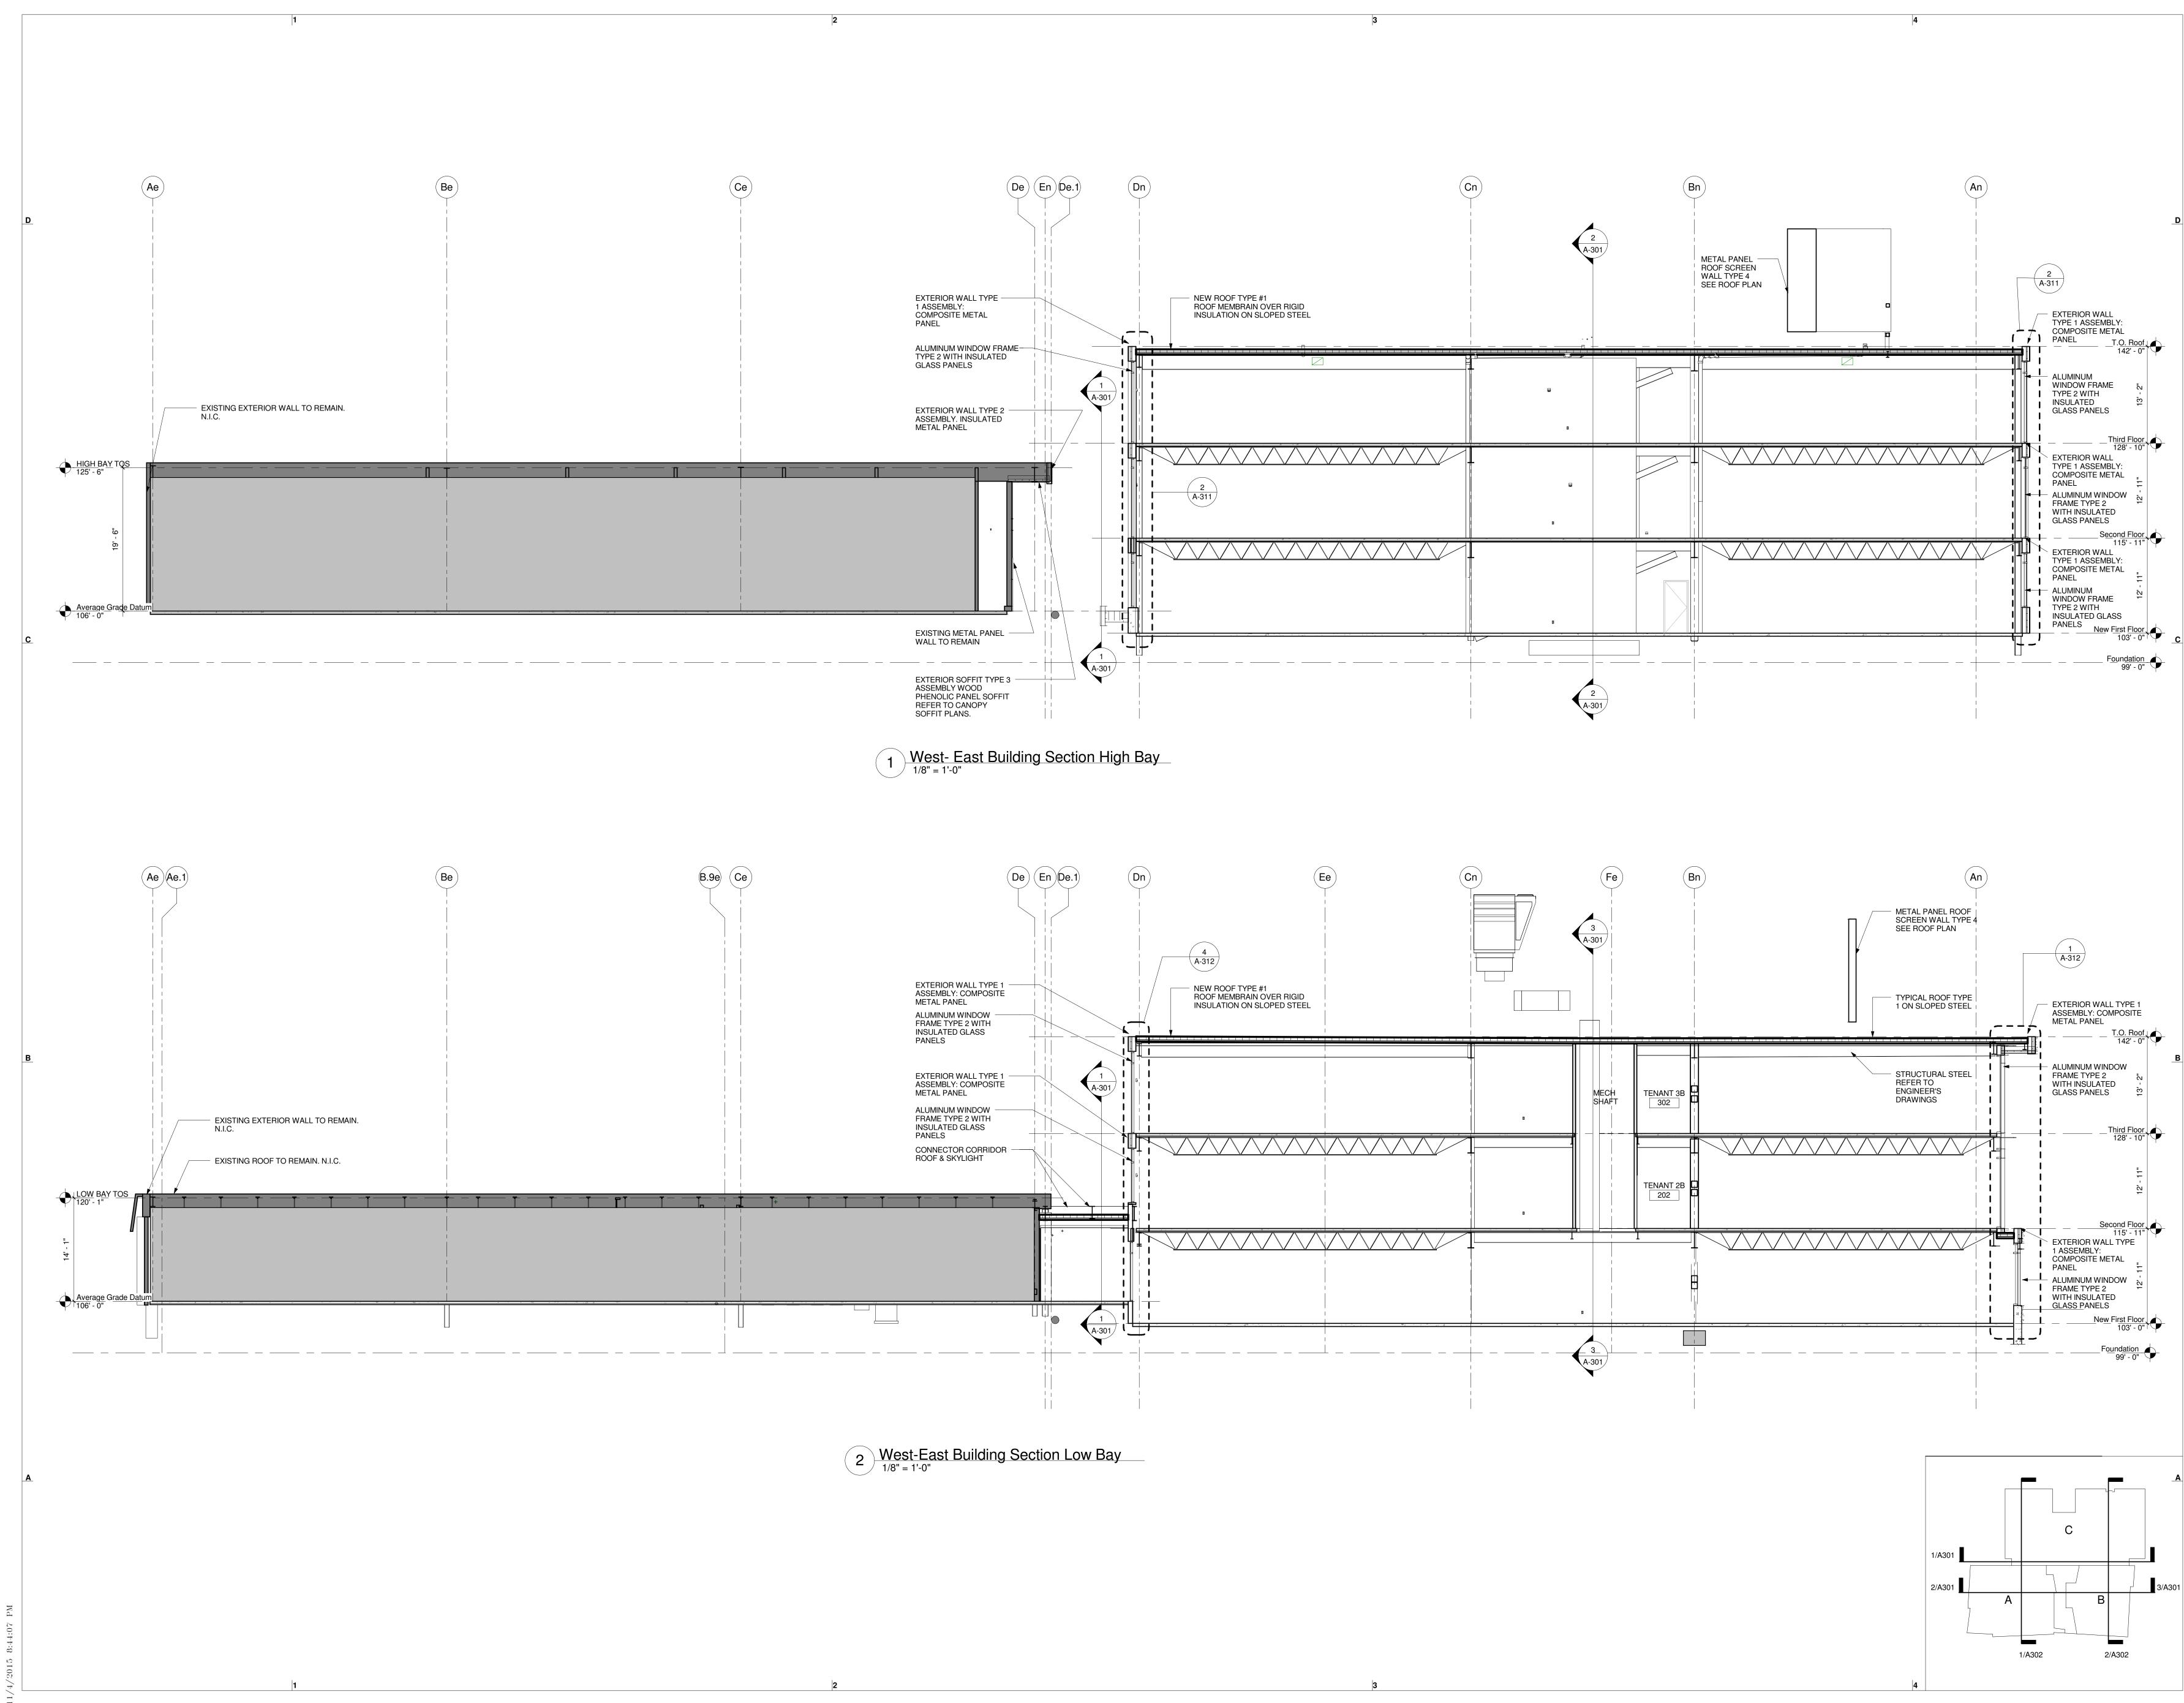
ELEVATION MATERIAL LEGE	ND		
EXTERIOR PANEL TYPES	ROOF SC	REEN PANEL	INSUL
M1 M1 WALL TYPE 1 COMPOSITE METAL PANEL MFR: REYNOBOND	МЗ	WALL TYPE 4 (NEW ROOF) METAL PANEL MFR: MORIN	V1
STYLE: COLORWELD 300 XL COLOR: BRIGHT SILVER METALLIC		STYLE: TBD CURRUGATED PANELS COLOR: TBD	V1T
	EXTERIO	R SOFFIT PANEL	
MALL TYPE 2 M2 M2 MER: KINGSPAN	W1	EXTERIOR SOFFIT TYPE 3 WOOD PHENOLIC PANEL	S1
STYLE: OPTIMO SMOOTH THICKNESS: 3" R-VALUE: R24		MFR: TRESPA STYLE: METEON THICKNESS: CONCEALED FASTENERS	S1T
COLOR: MATCH M1		& 1/2" (13mm) PANELS COLOR: NW03 HARMONY OAK	
W1 W1 WOOD PHENOLIC PANEL MFR: TRESPA STYLE: METEON THICKNESS: CONCEALED FASTENERS & 1/2" (13mm) PANELS COLOR: NW03 HARMONY OAK		3	MISC.




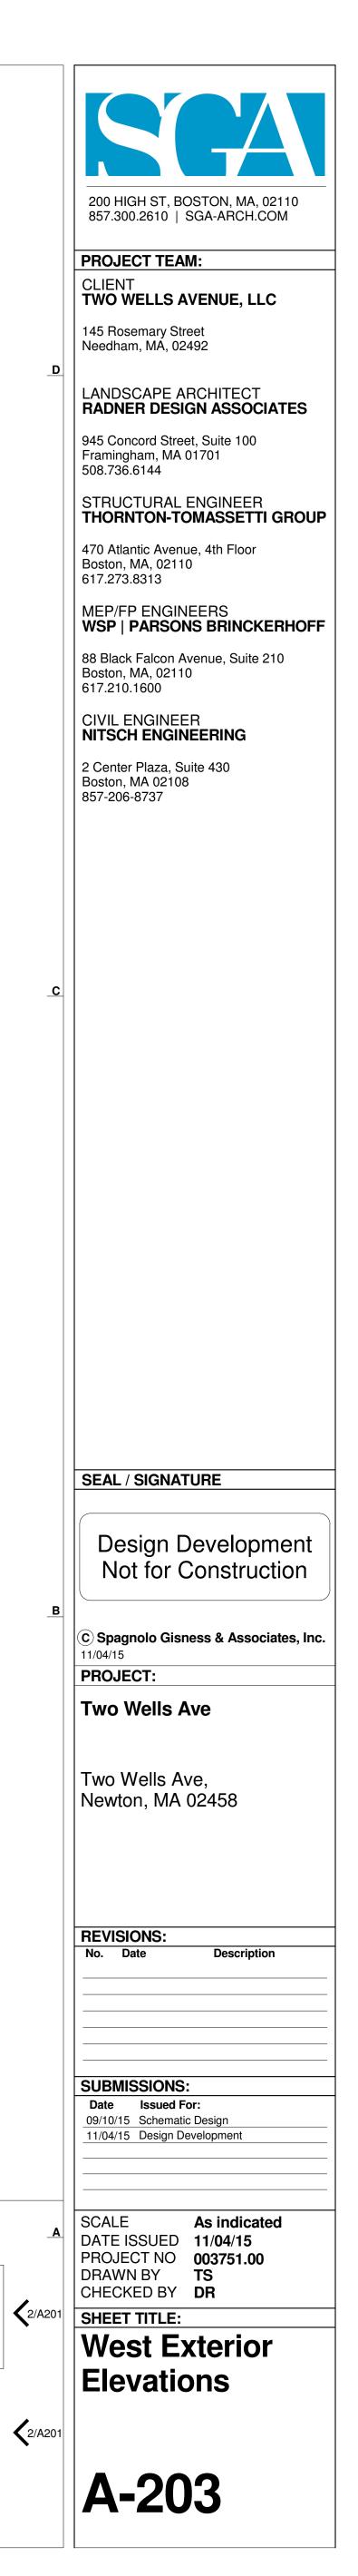

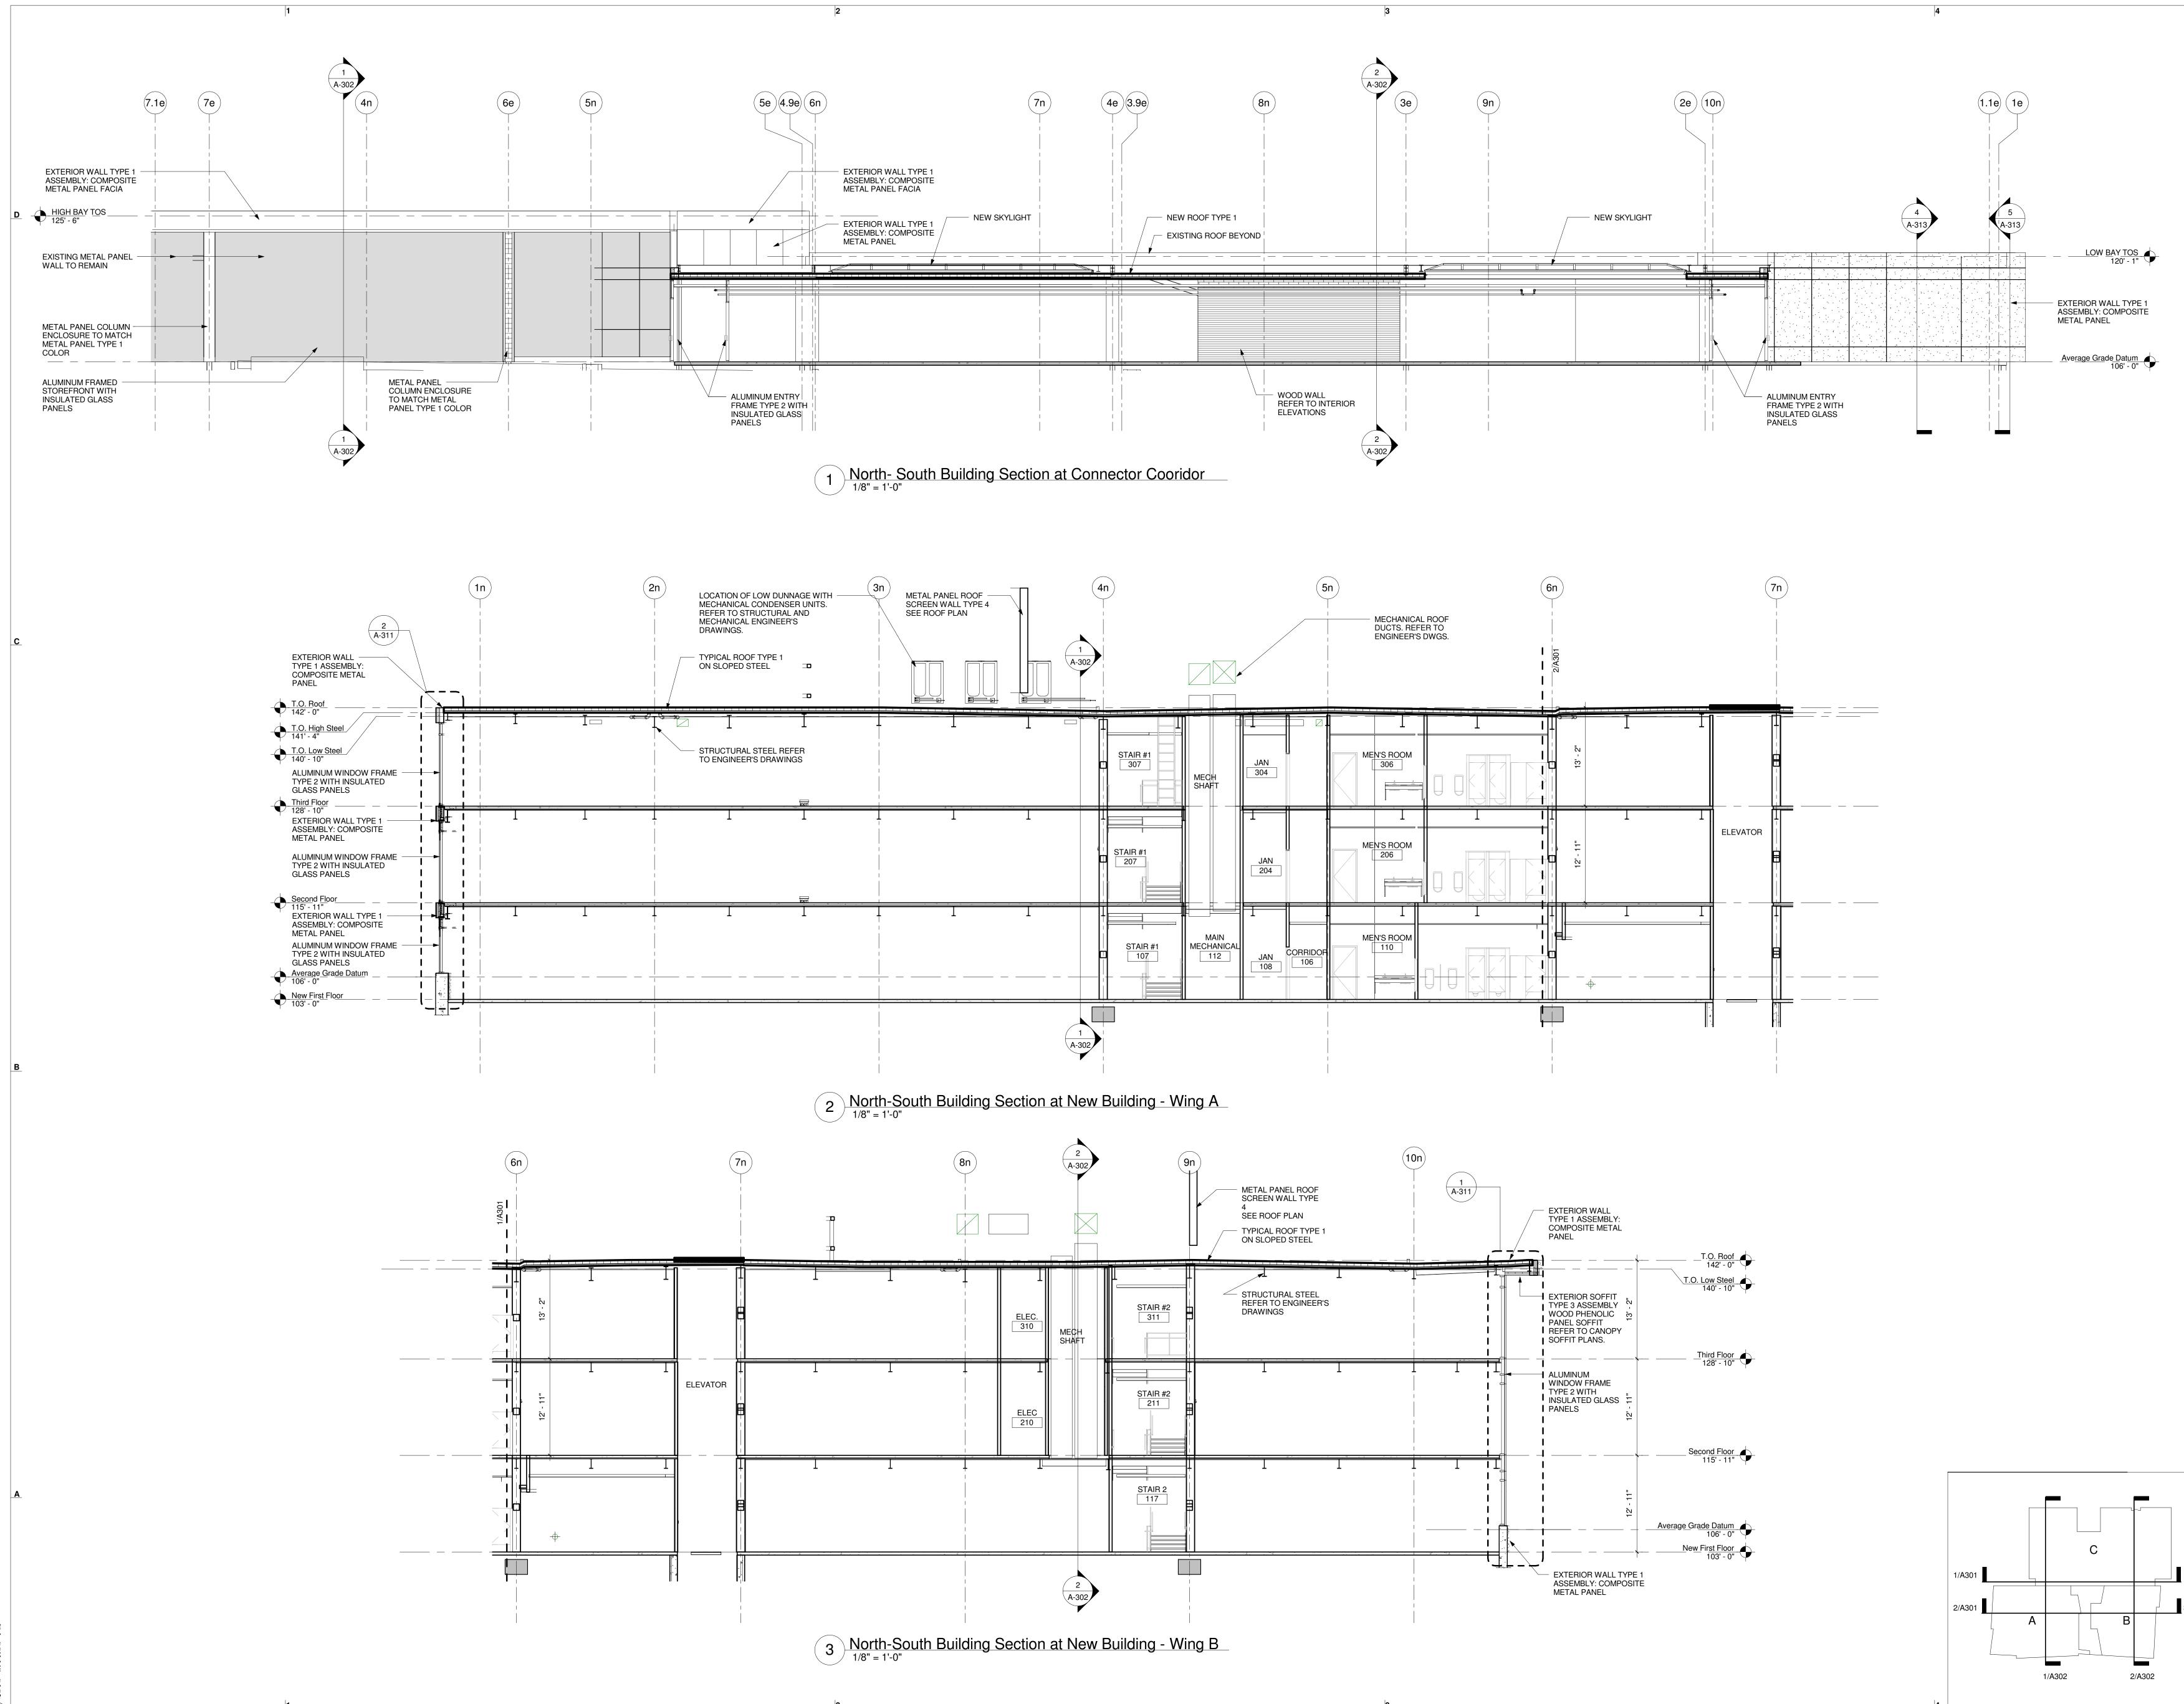
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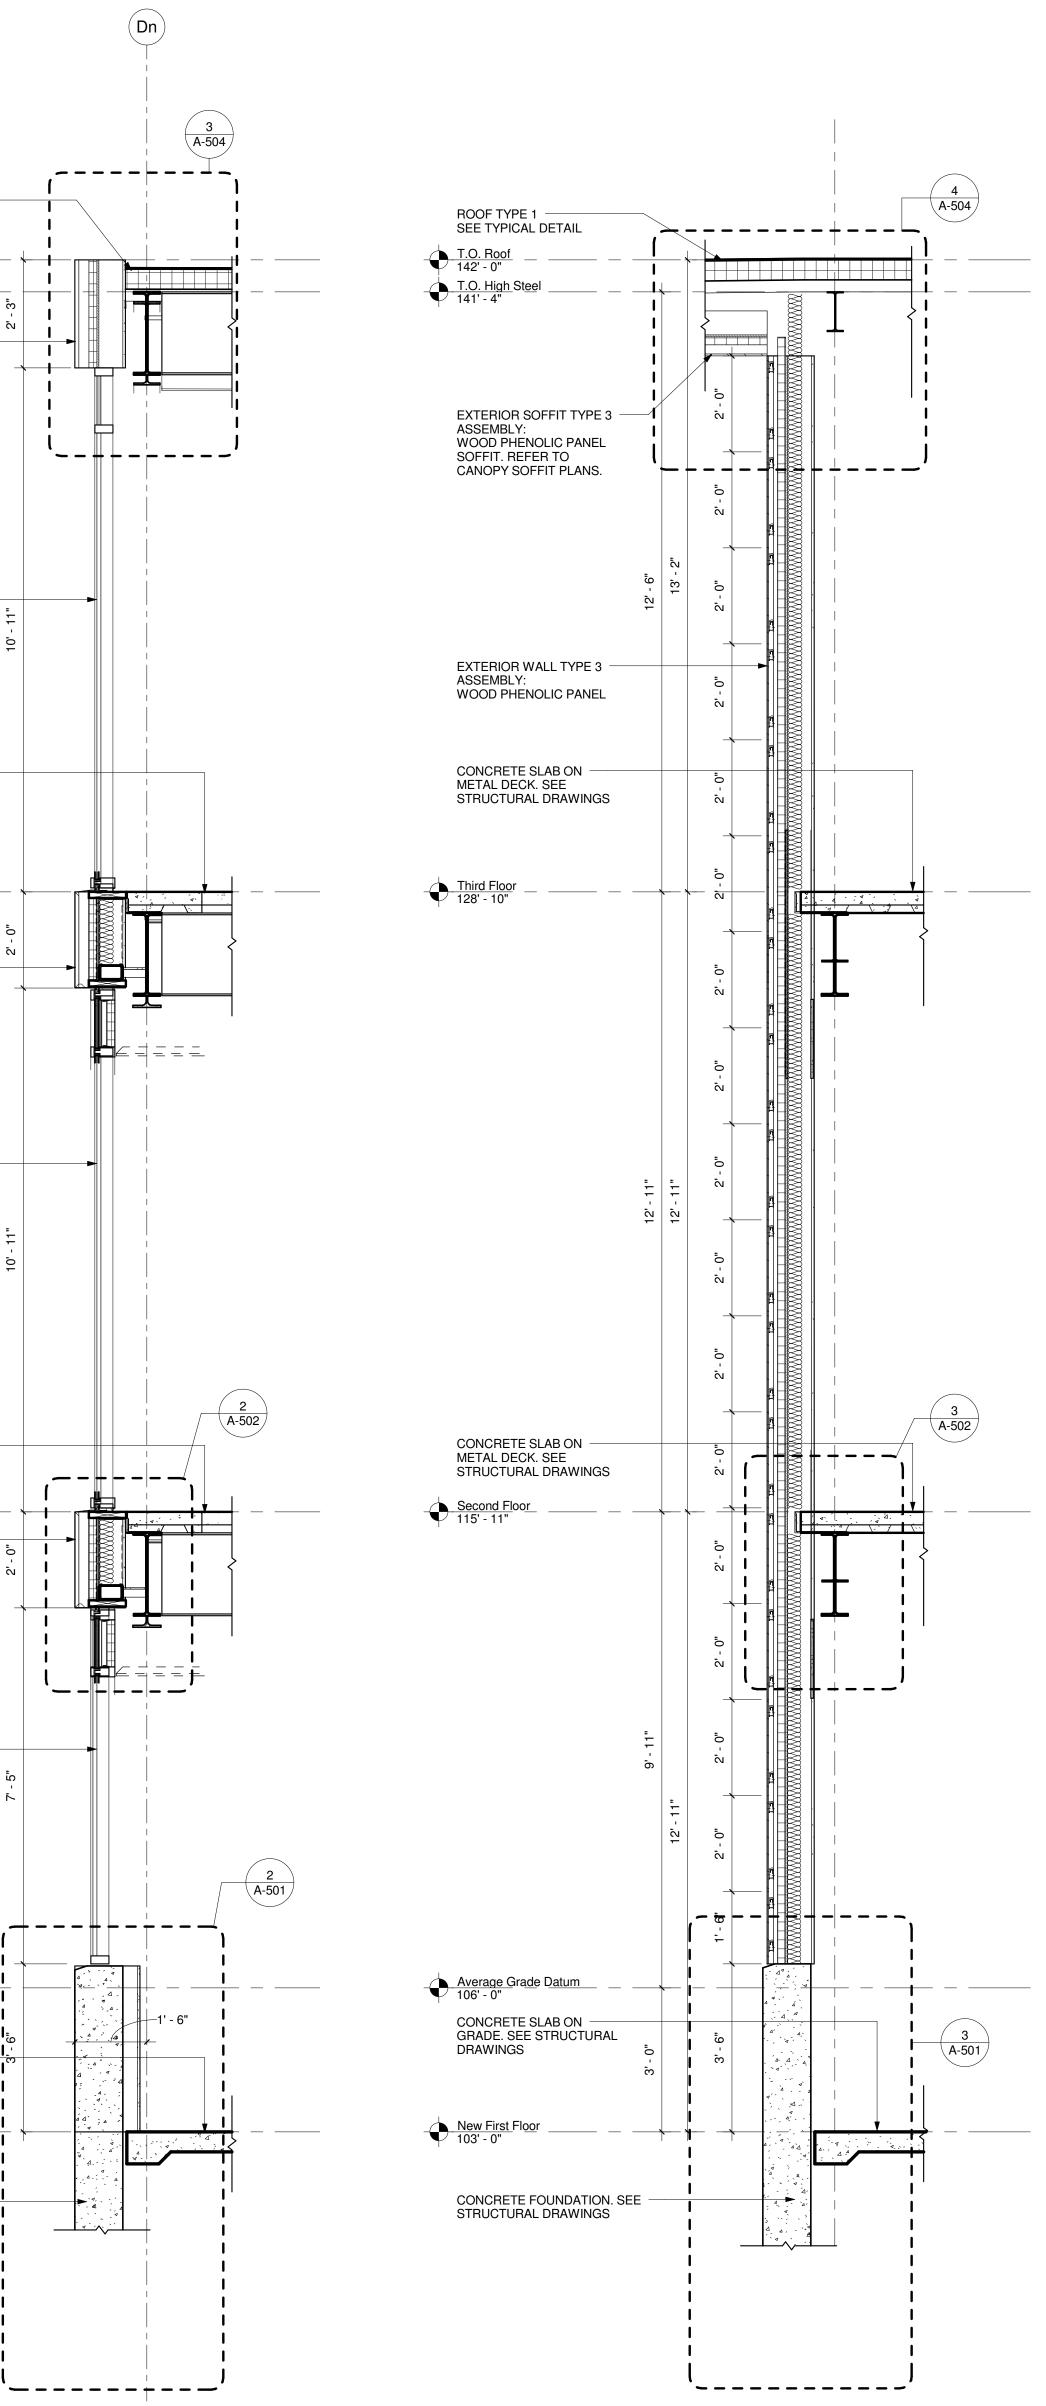




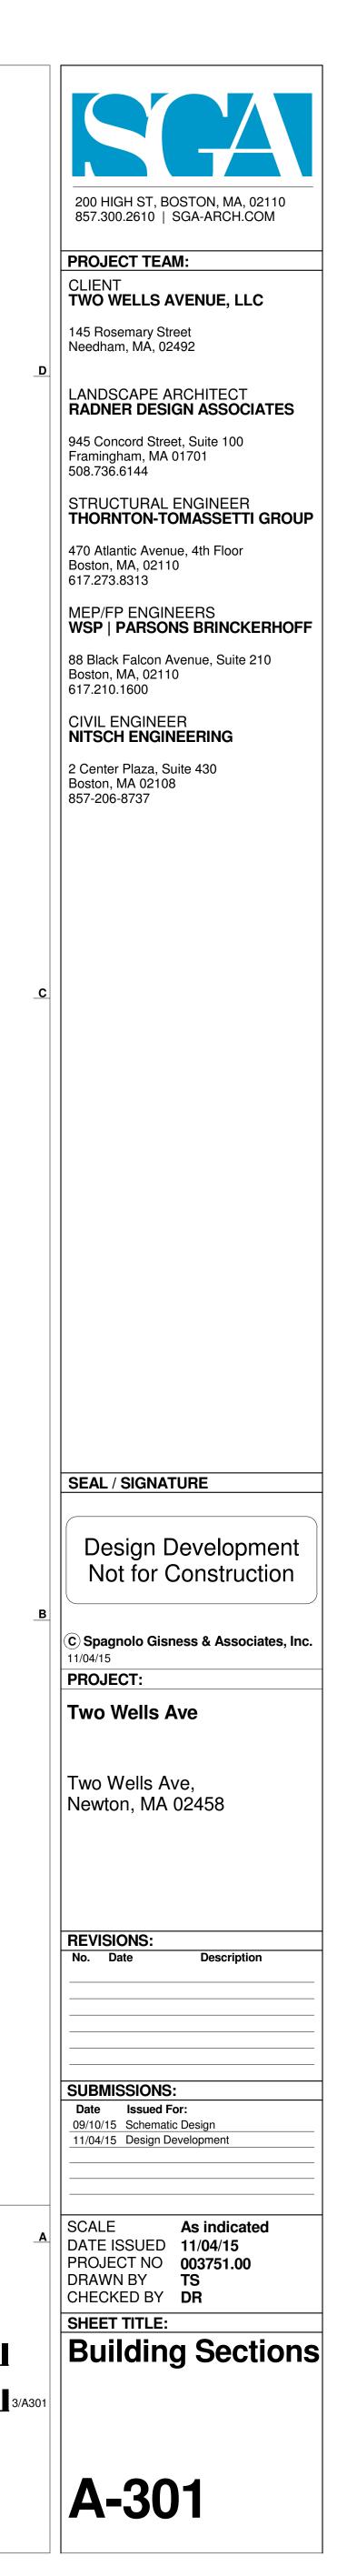

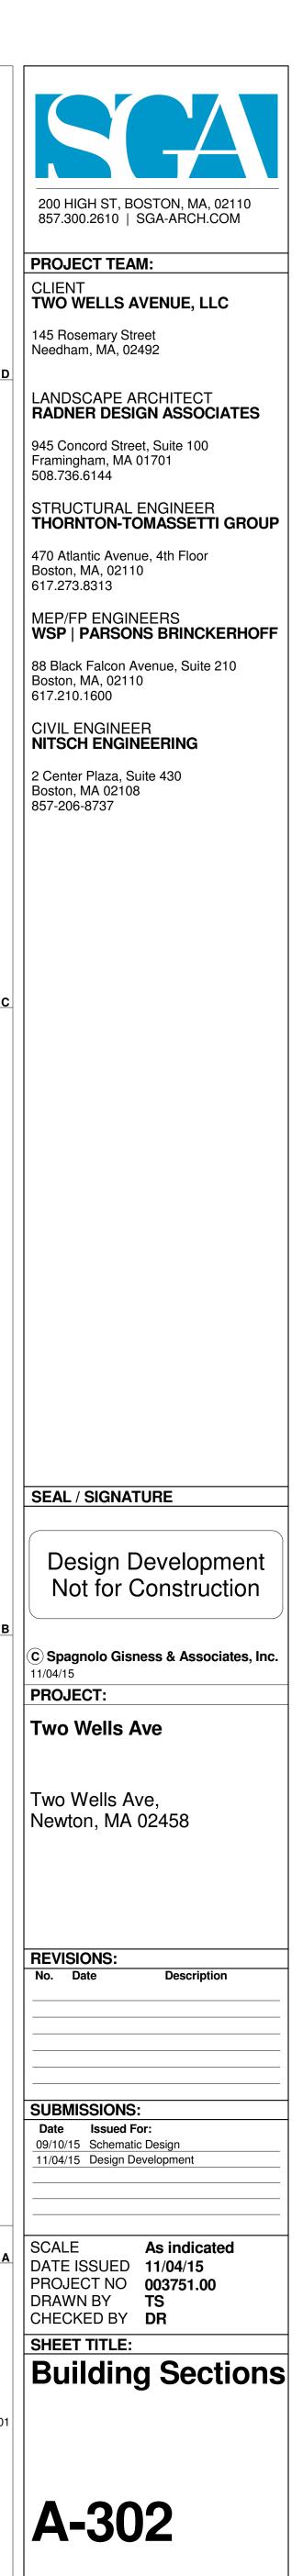


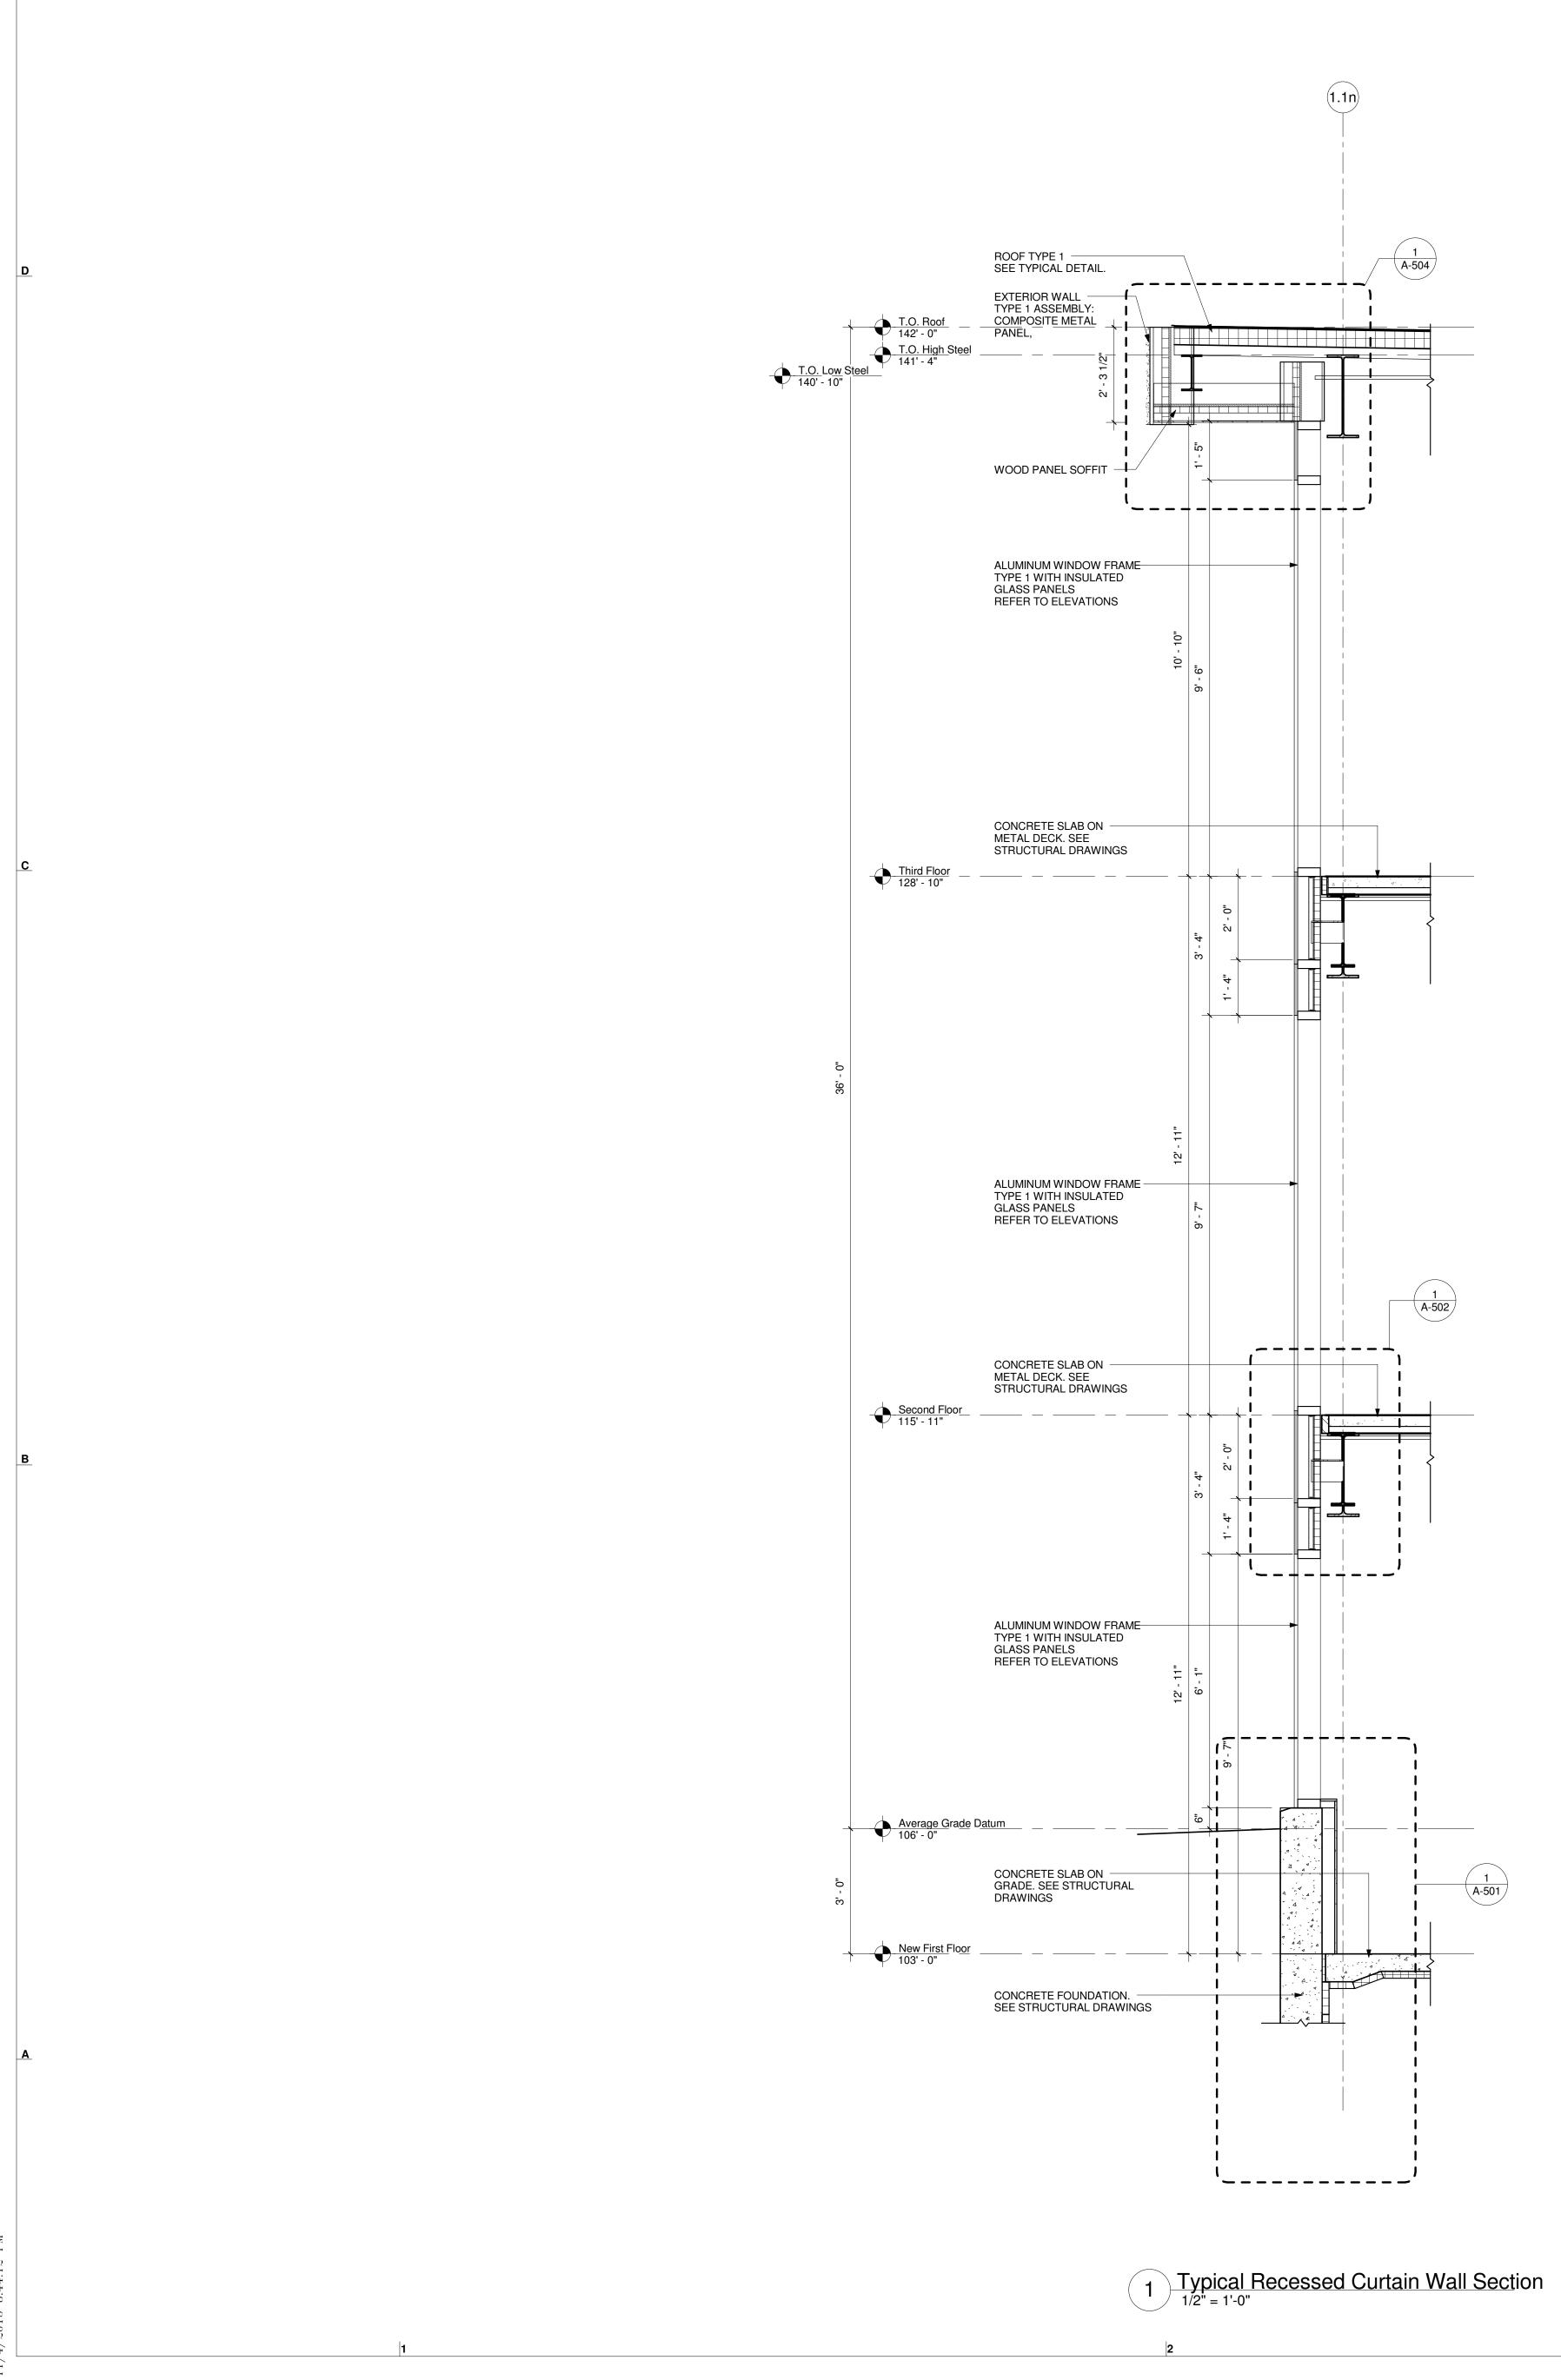
ROOF TYPE 1 SEE TYPICAL DETAIL		s
EXTERIOR WALL TYPE 1		2' - 3"
ASSEMBLY: COMPOSITE METAL PANEL,	- 2"	
ALUMINUM WINDOW FRAME TYPE 2 WITH INSULATED GLASS PANELS	13'	10' - 11"
CONCRETE SLAB ON METAL DECK. SEE STRUCTURAL DRAWINGS		
- Third Floor		2' - 0"
EXTERIOR WALL TYPE 1 ASSEMBLY: COMPOSITE METAL PANEL		,
ALUMINUM WINDOW FRAME TYPE 2 WITH INSULATED GLASS PANELS	12' - 11"	10' - 11"
CONCRETE SLAB ON METAL DECK. SEE STRUCTURAL DRAWINGS		
EXTERIOR WALL TYPE 1 ASSEMBLY: COMPOSITE METAL PANEL,		2' - 0"
ALUMINUM FRAMING AND INSULATED GLASS WINDOW SYSTEM REFER TO ELEVATIONS	12' - 11"	
Average Grade Datum		
CONCRETE SLAB ON 5 GRADE. SEE 5 STRUCTURAL DRAWINGS <u>New First Floor</u> 103' - 0"		,
CONCRETE FOUNDATION. SEE STRUCTURAL DRAWINGS		




2 Typical Wall Section at Storefront

3 Typical Wall Section at Wood Panel

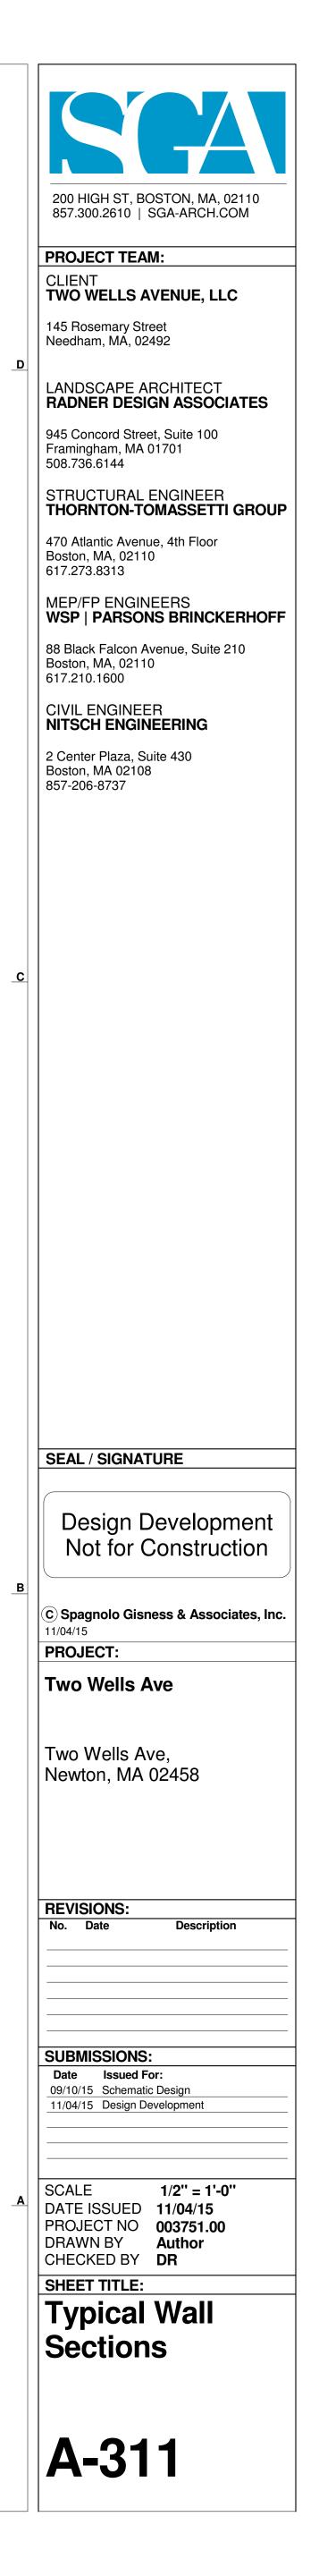

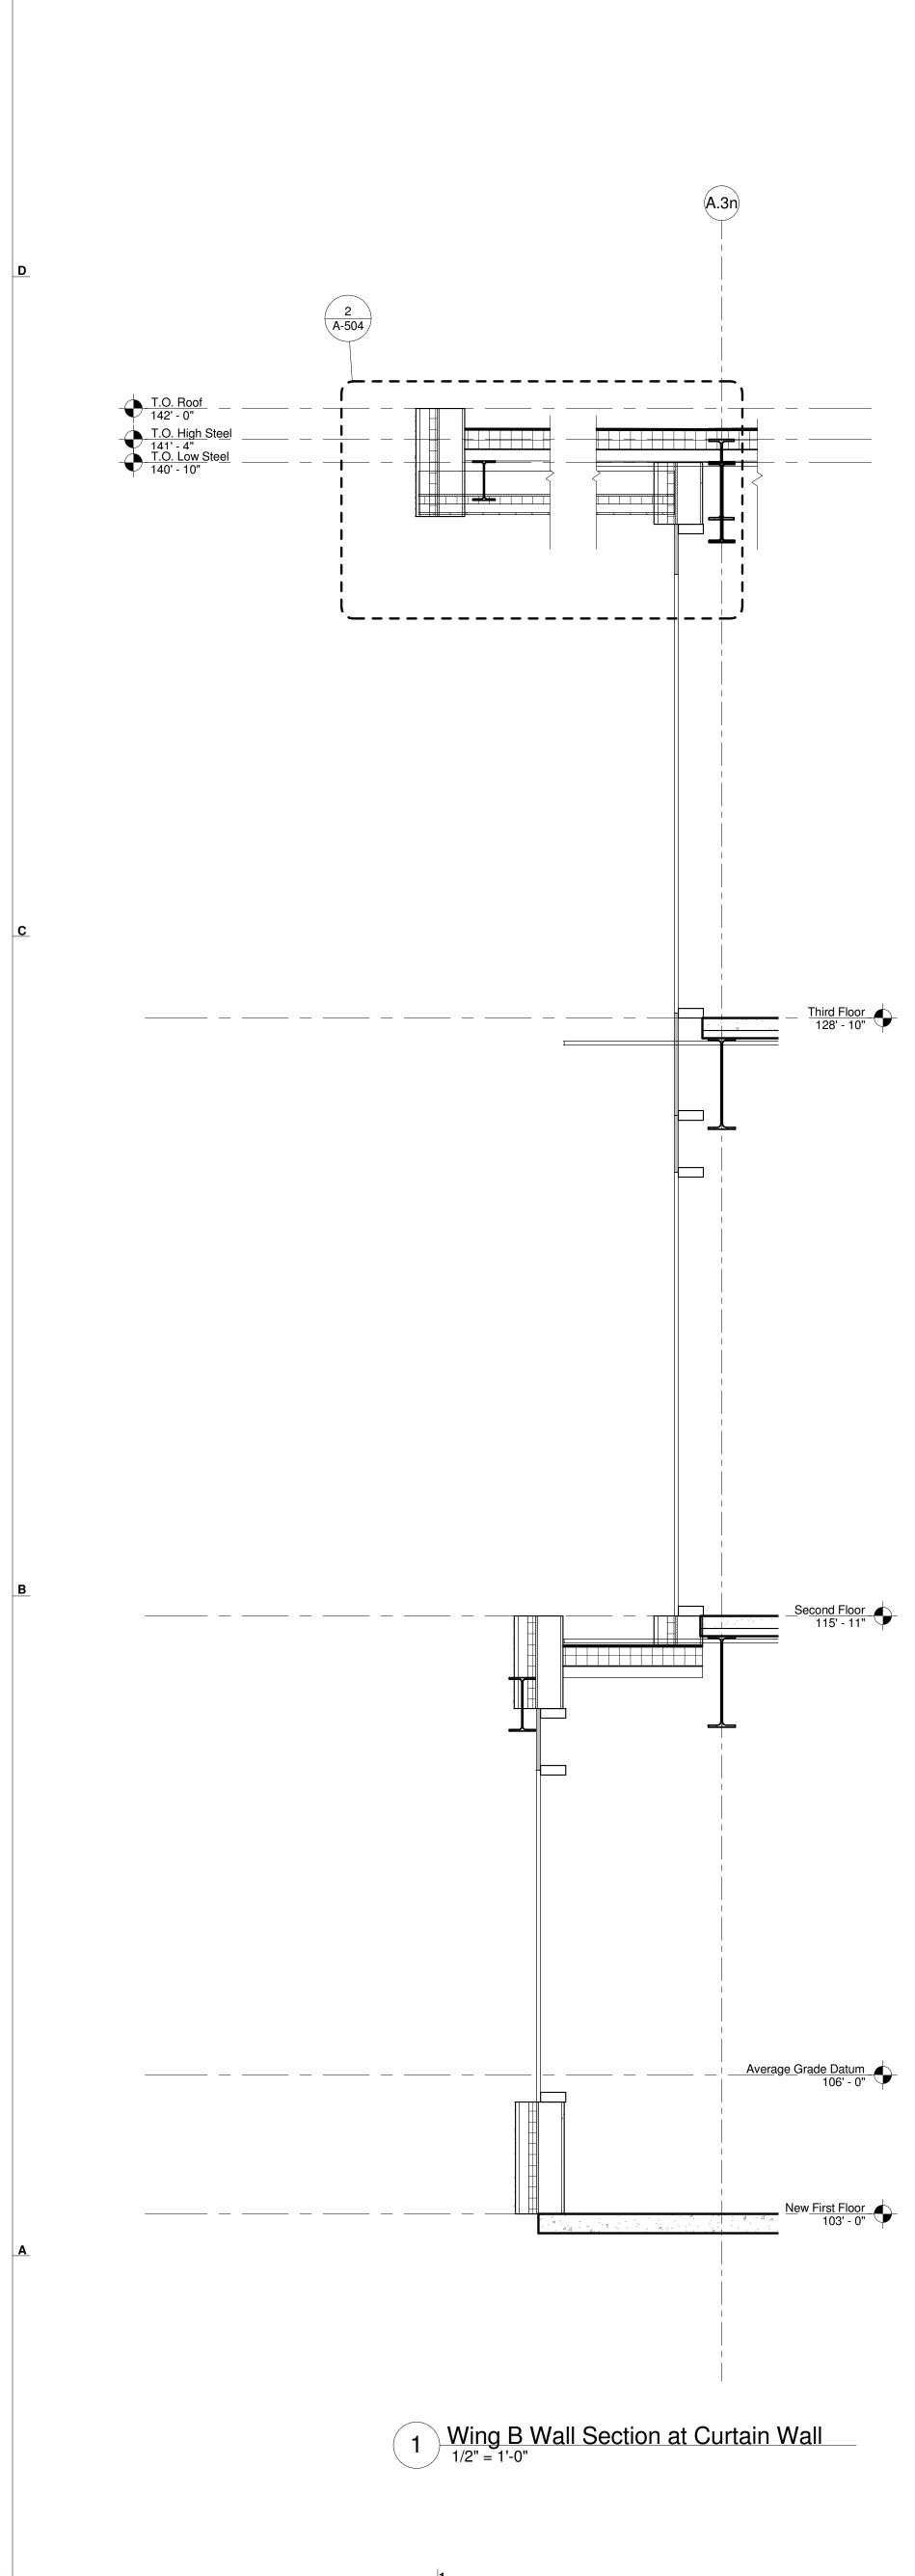



### 2 Wing B Wall Section at Vestibule

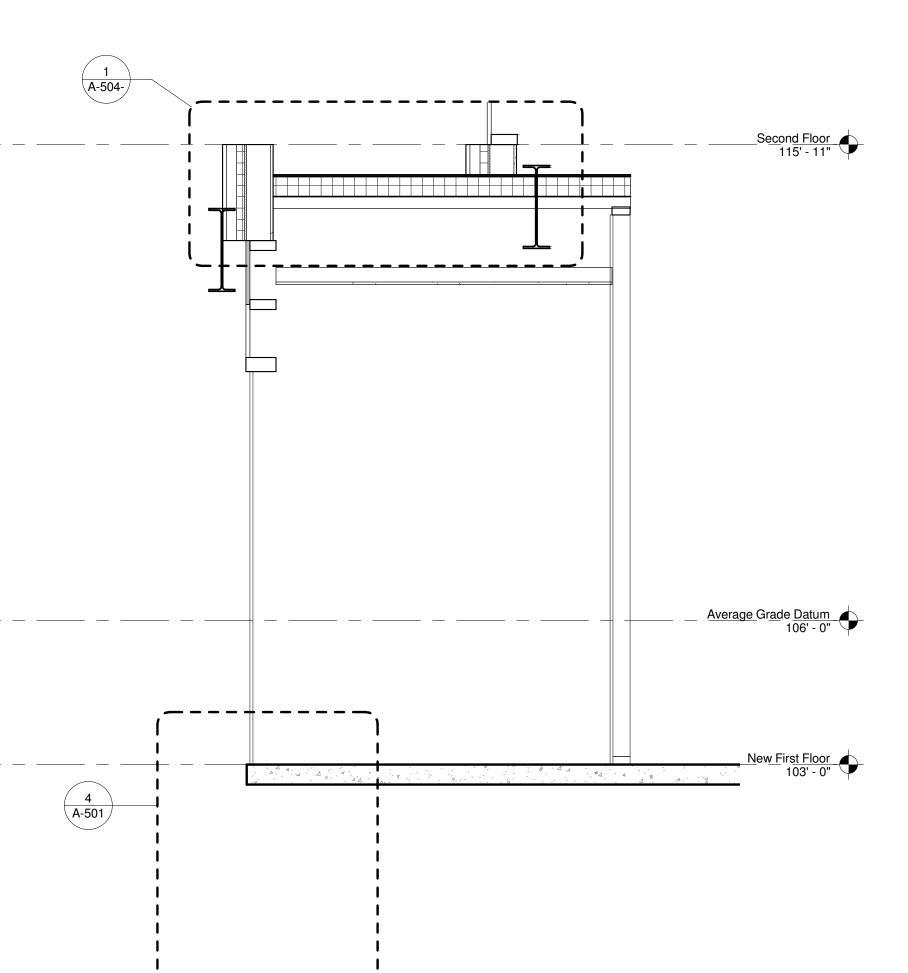



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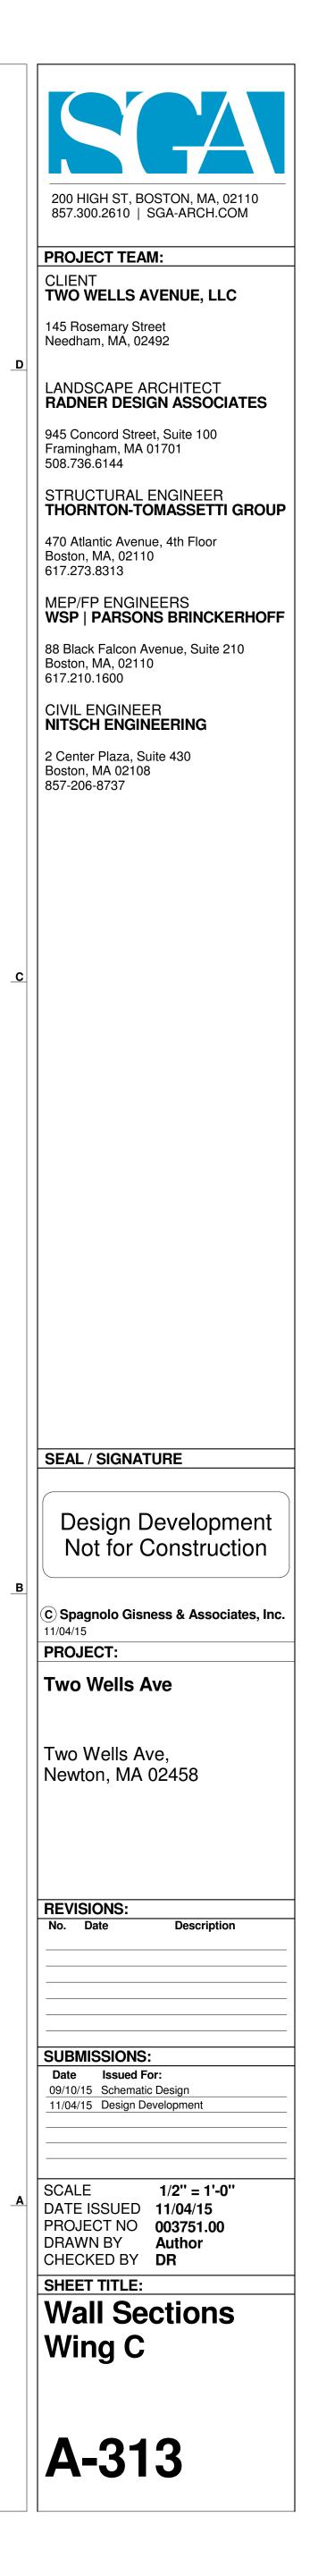
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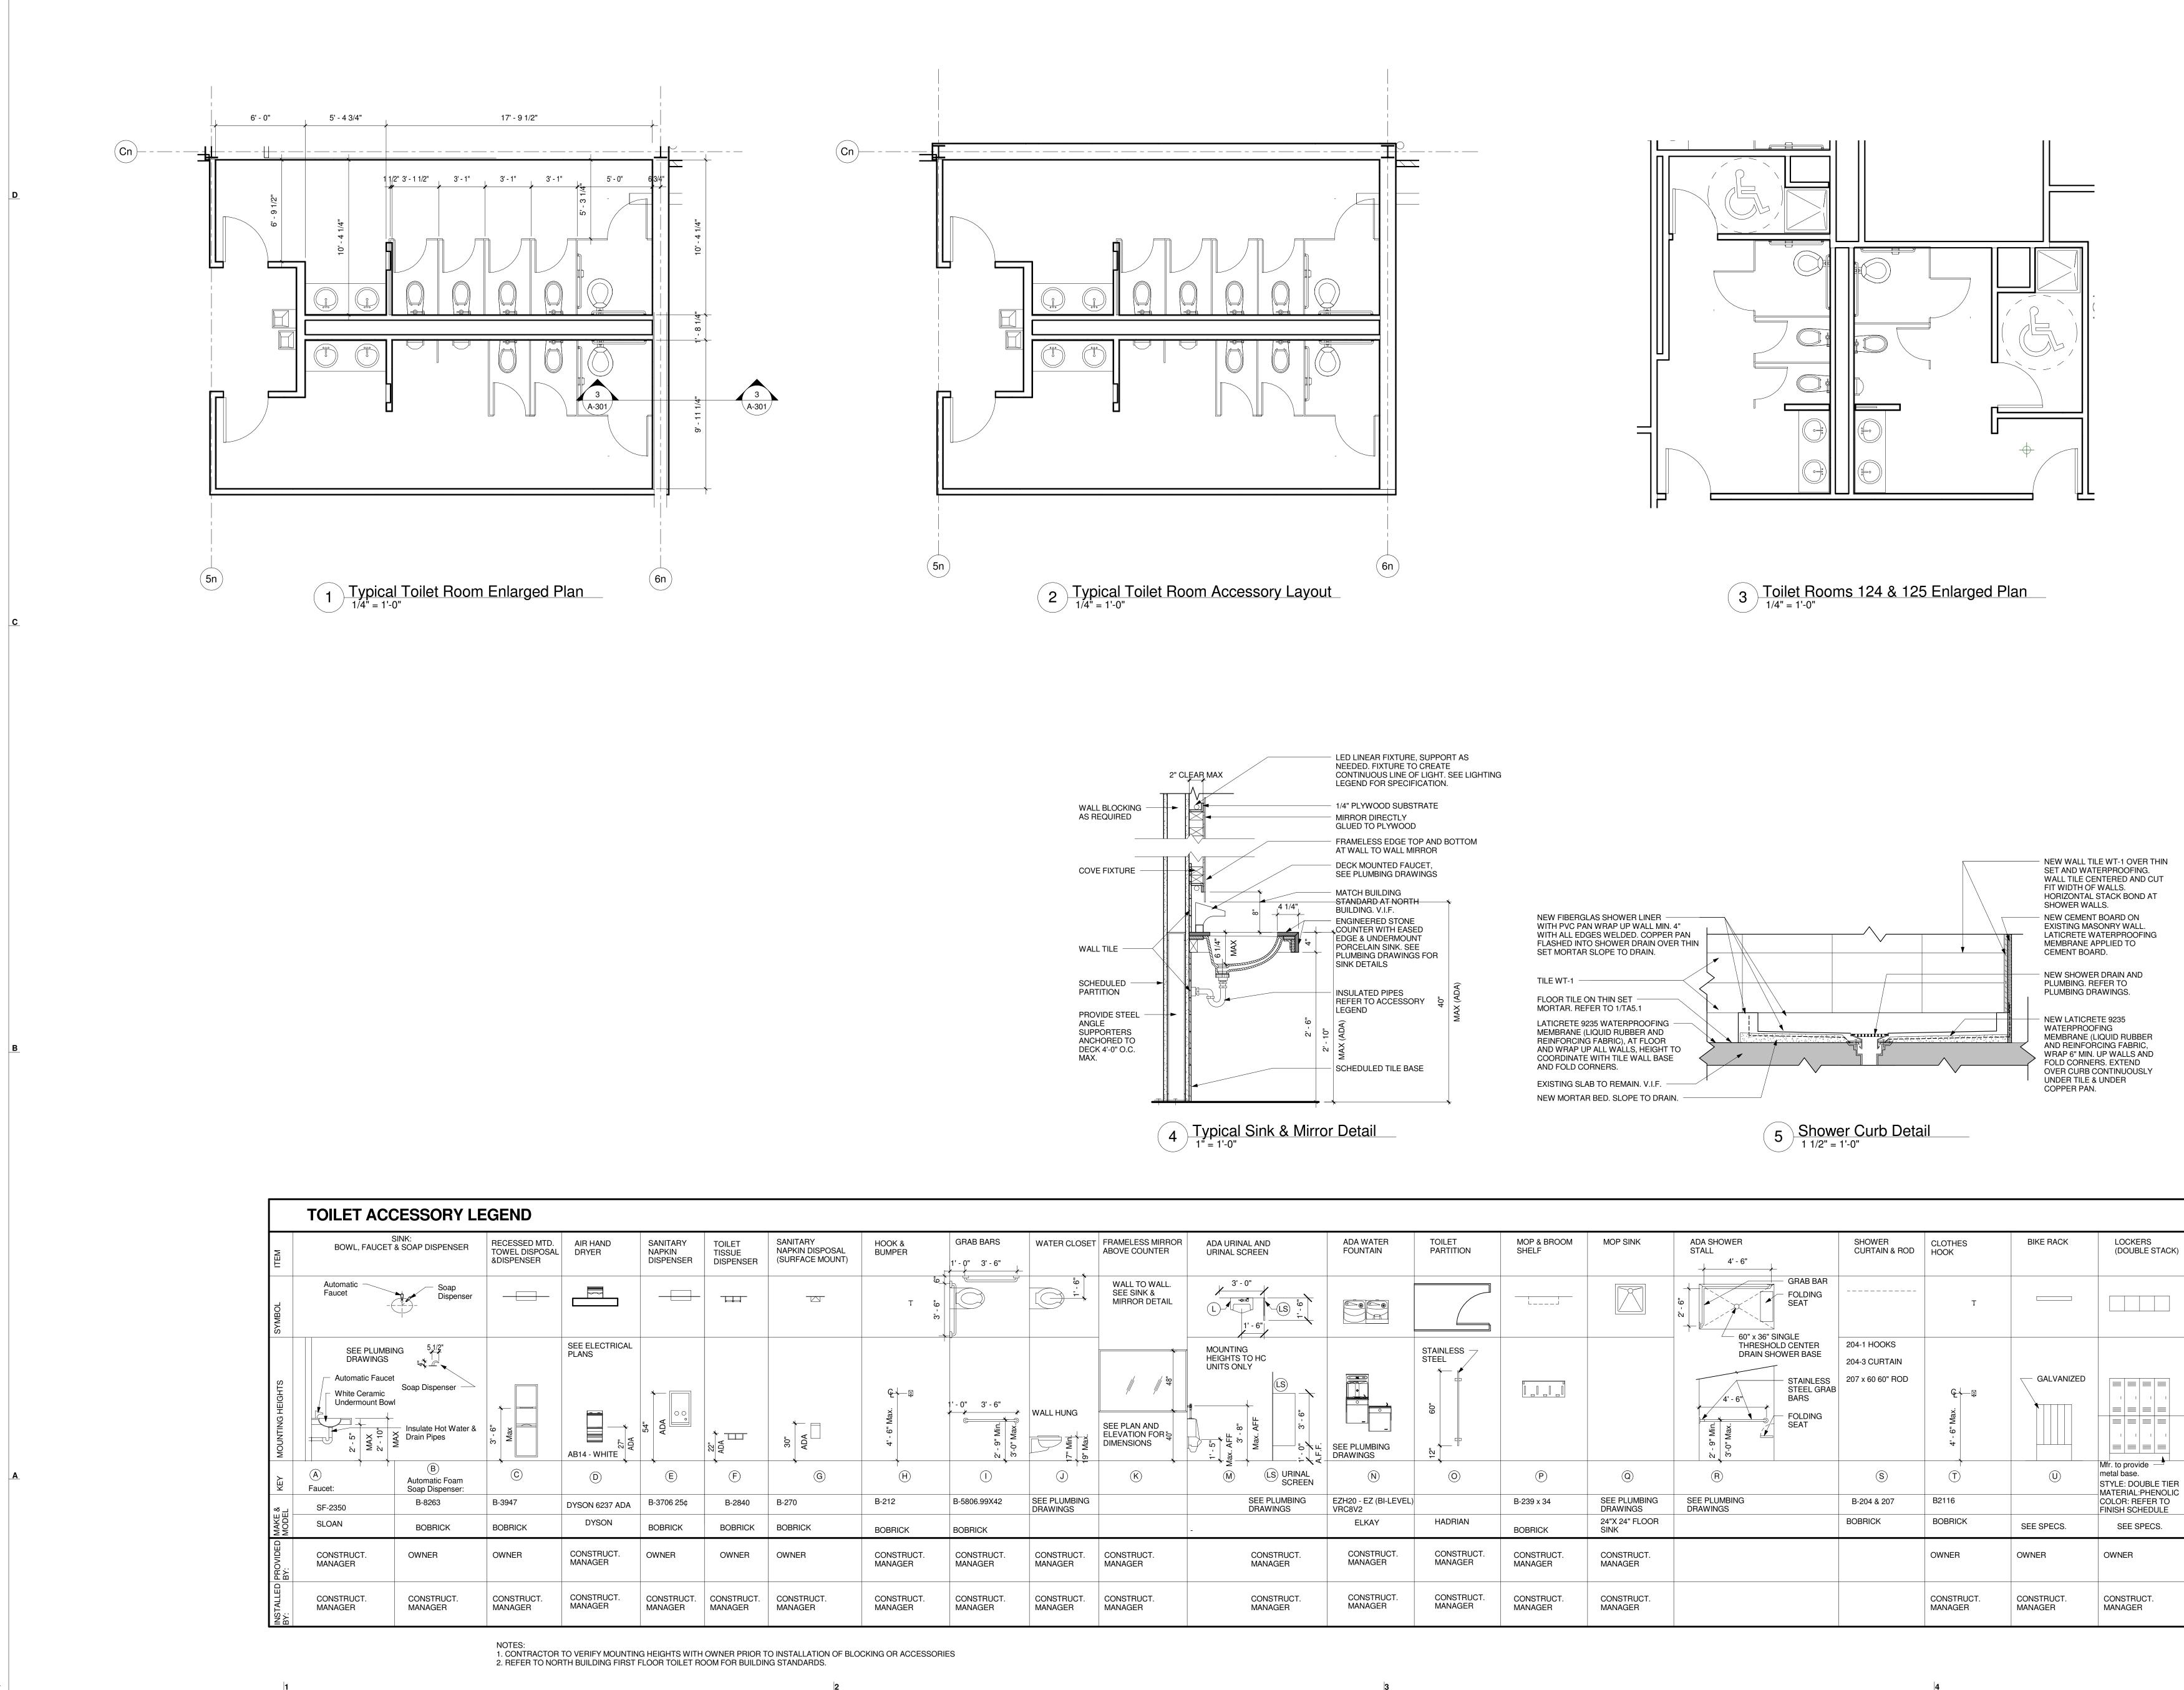




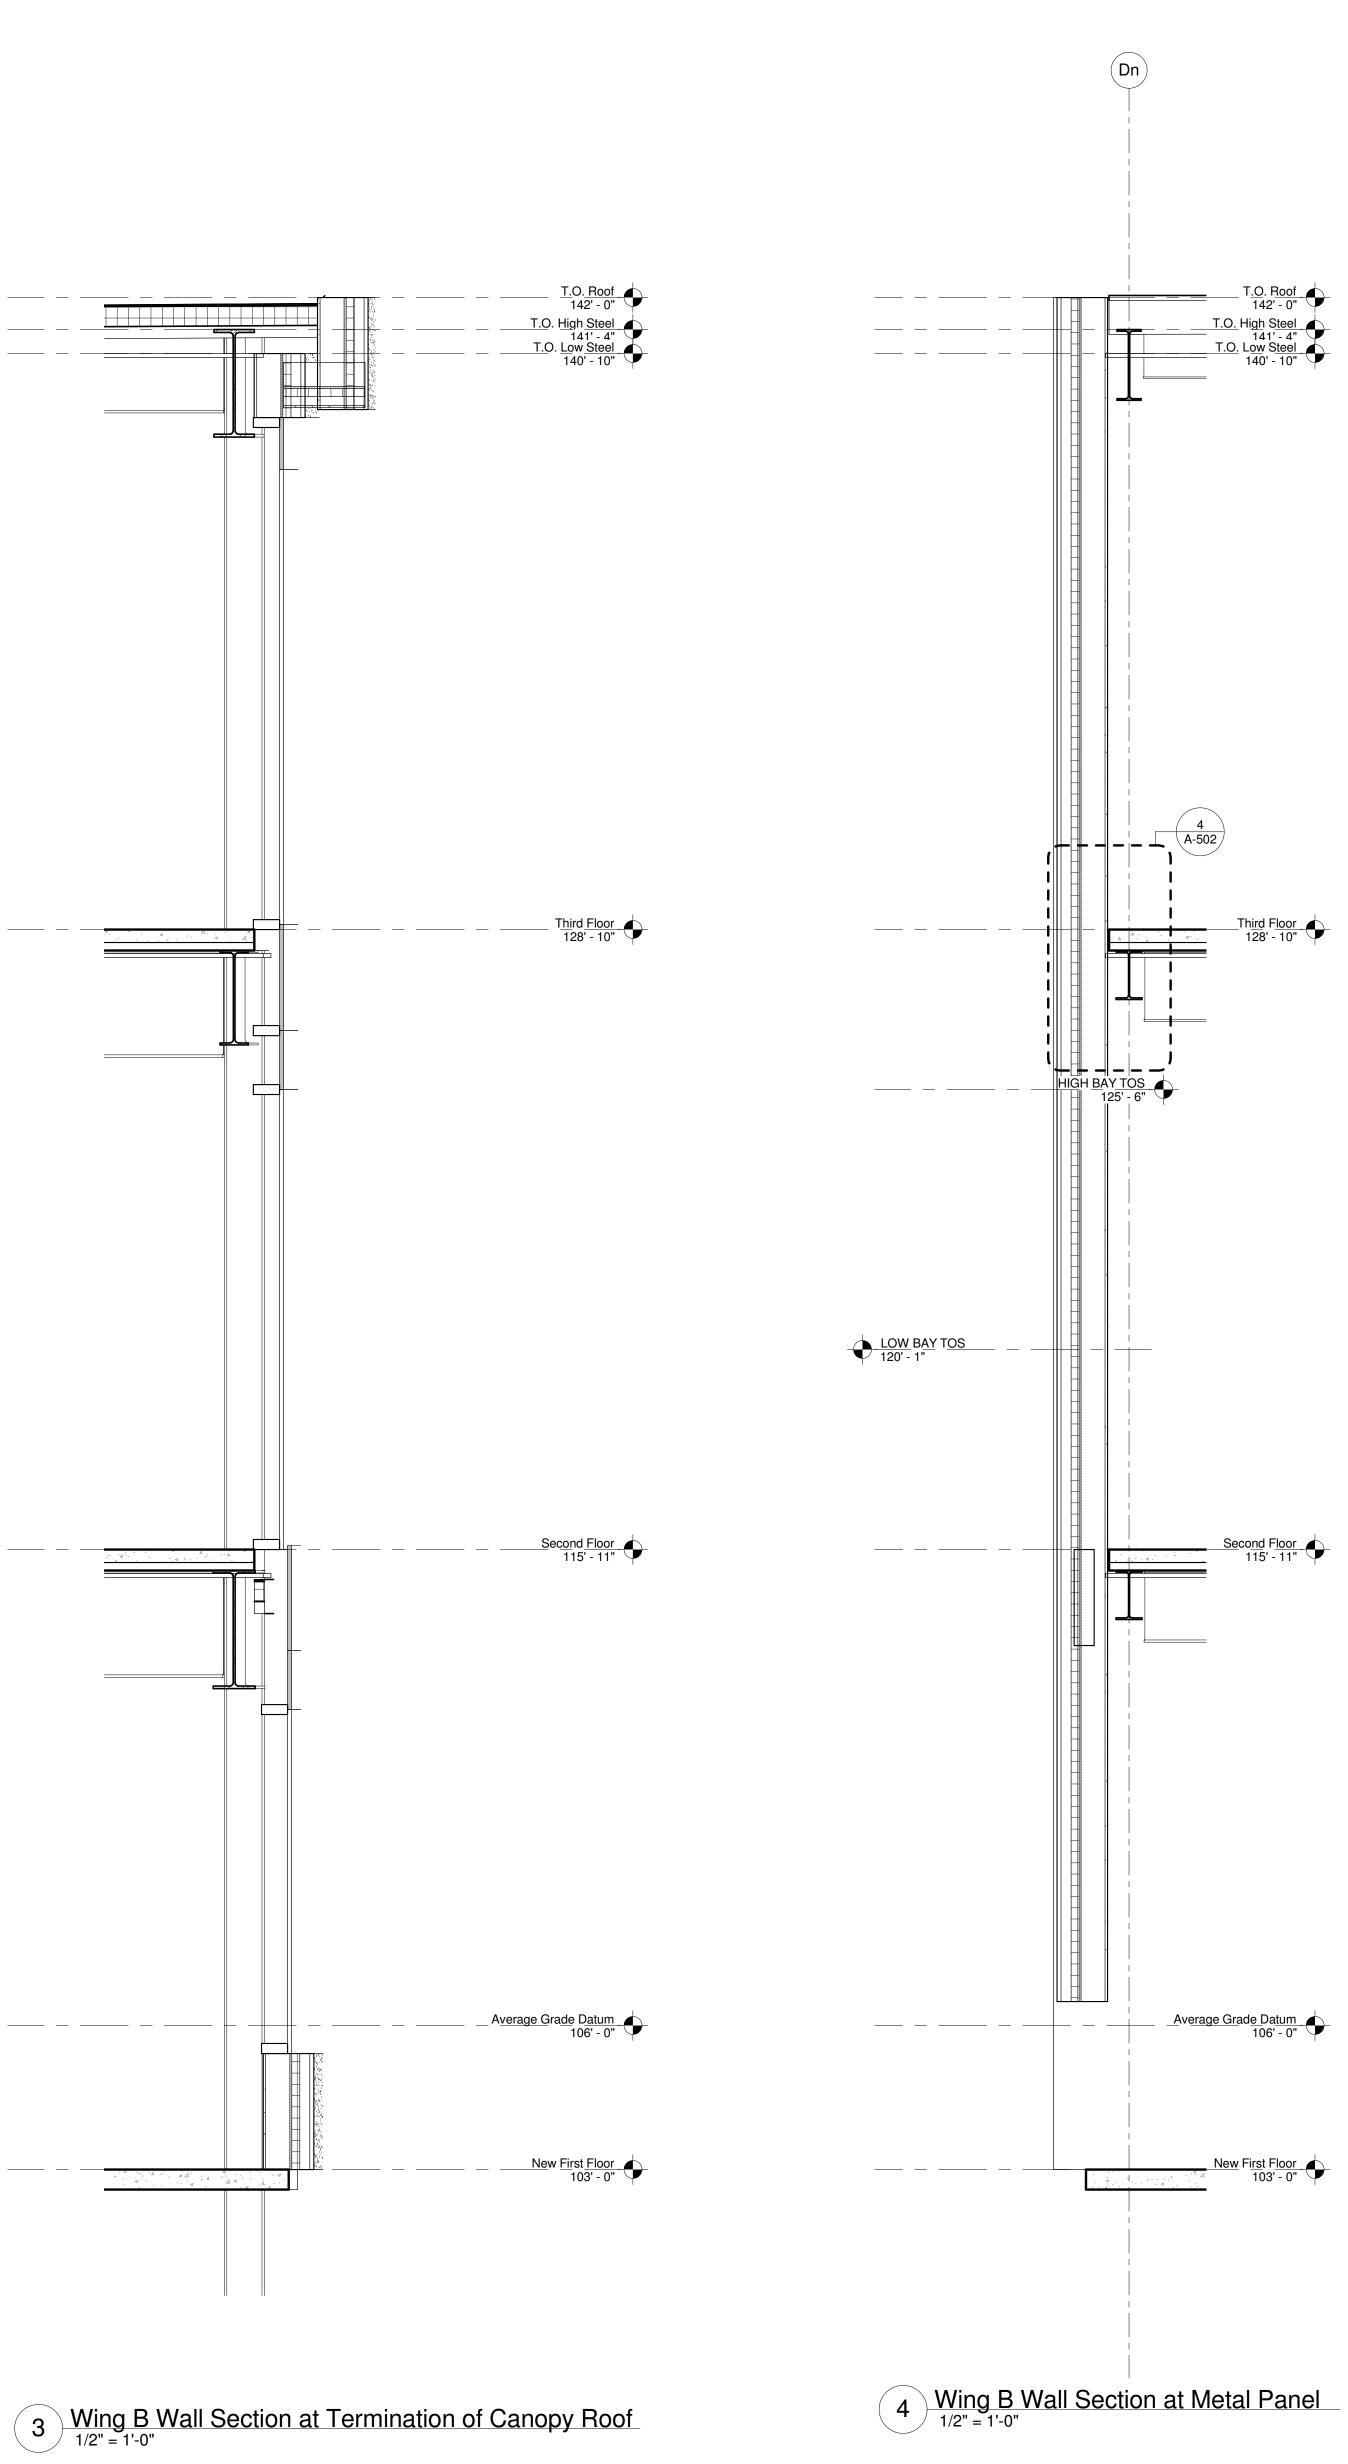

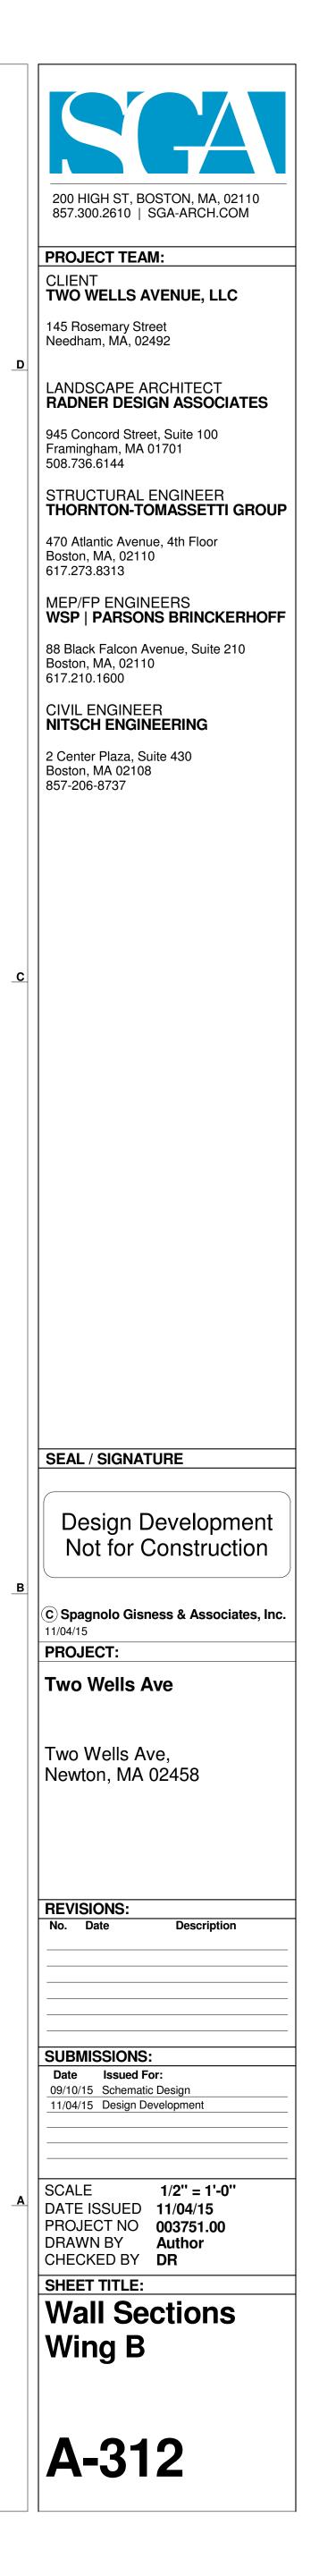


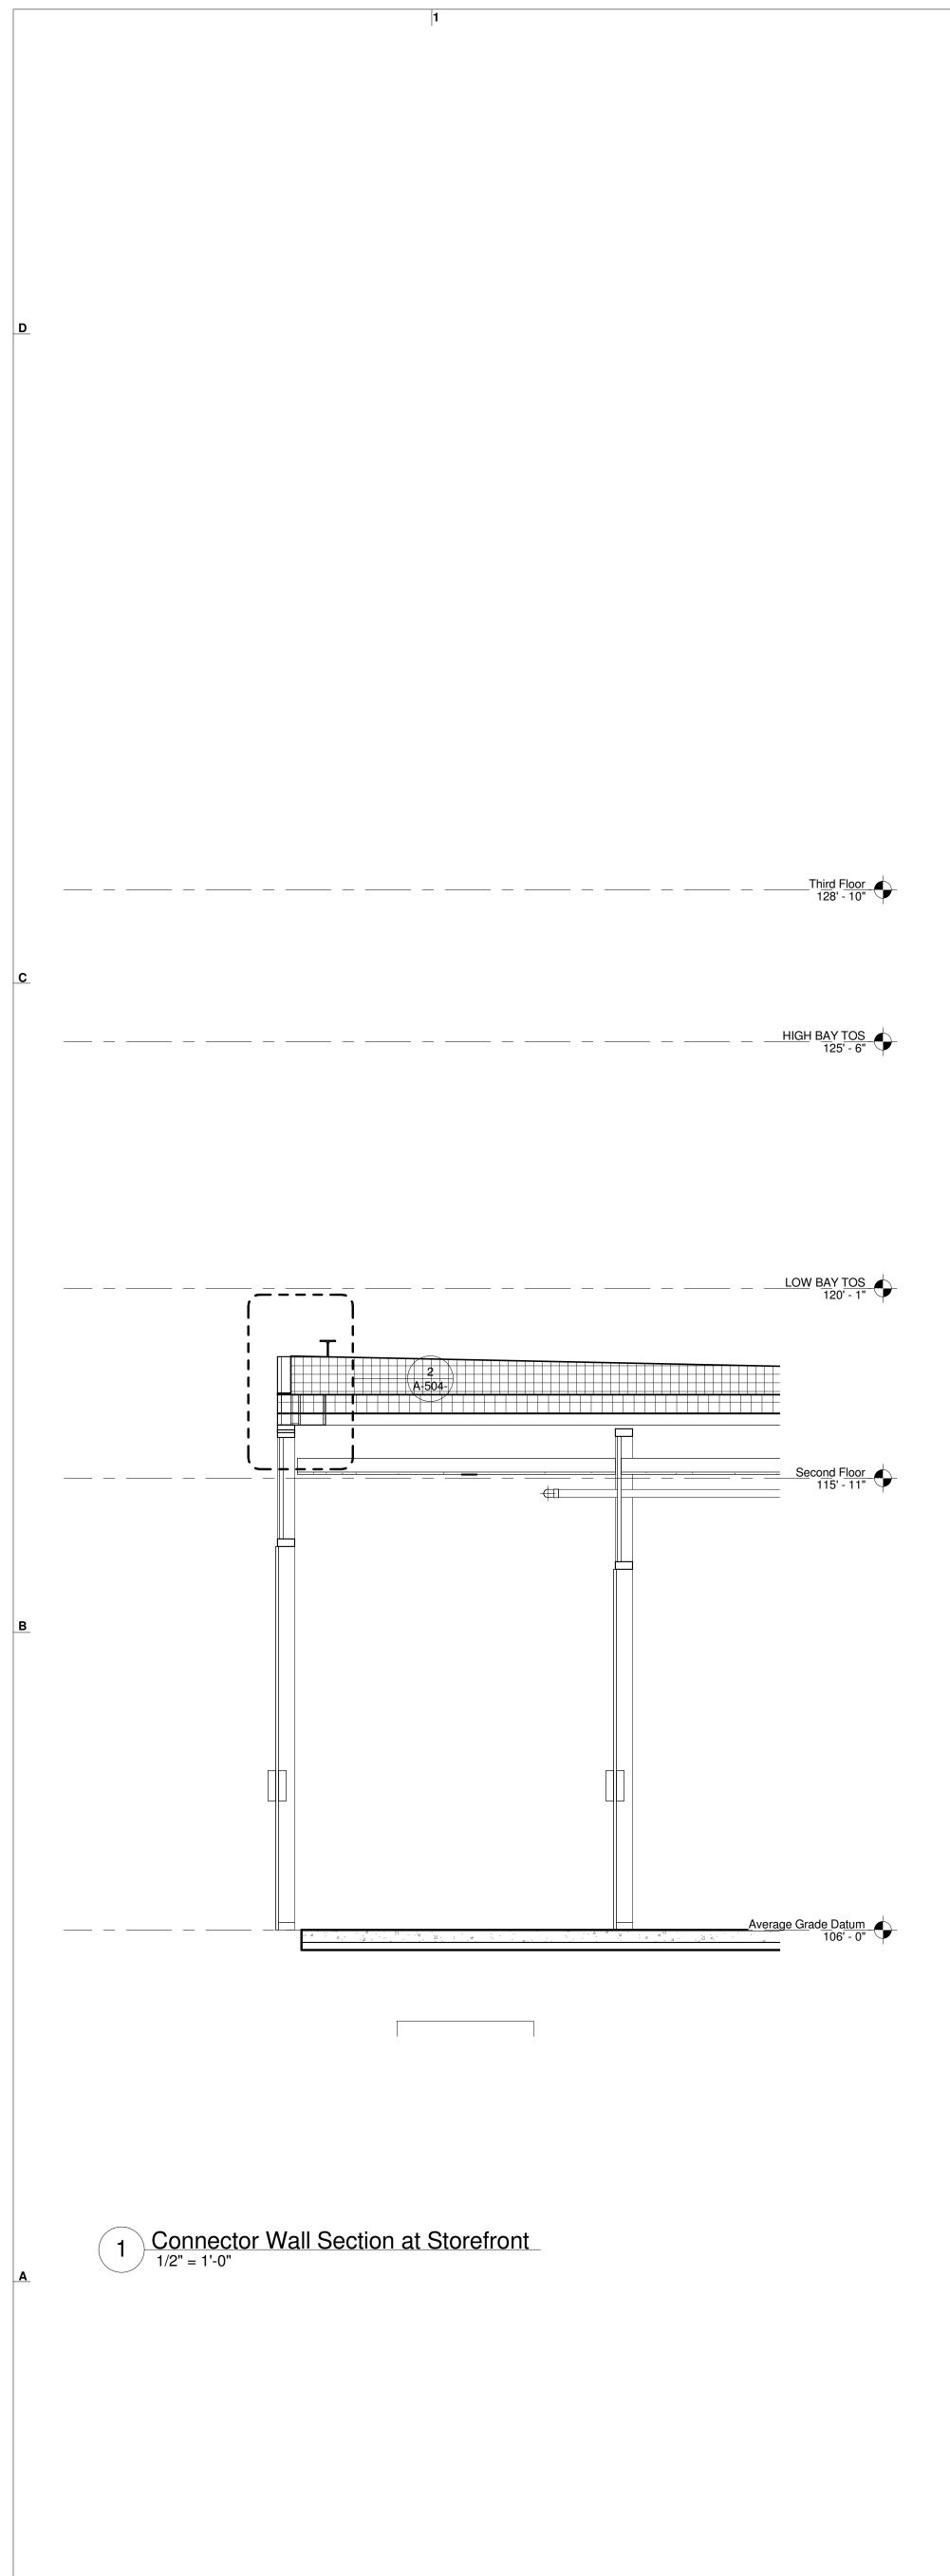


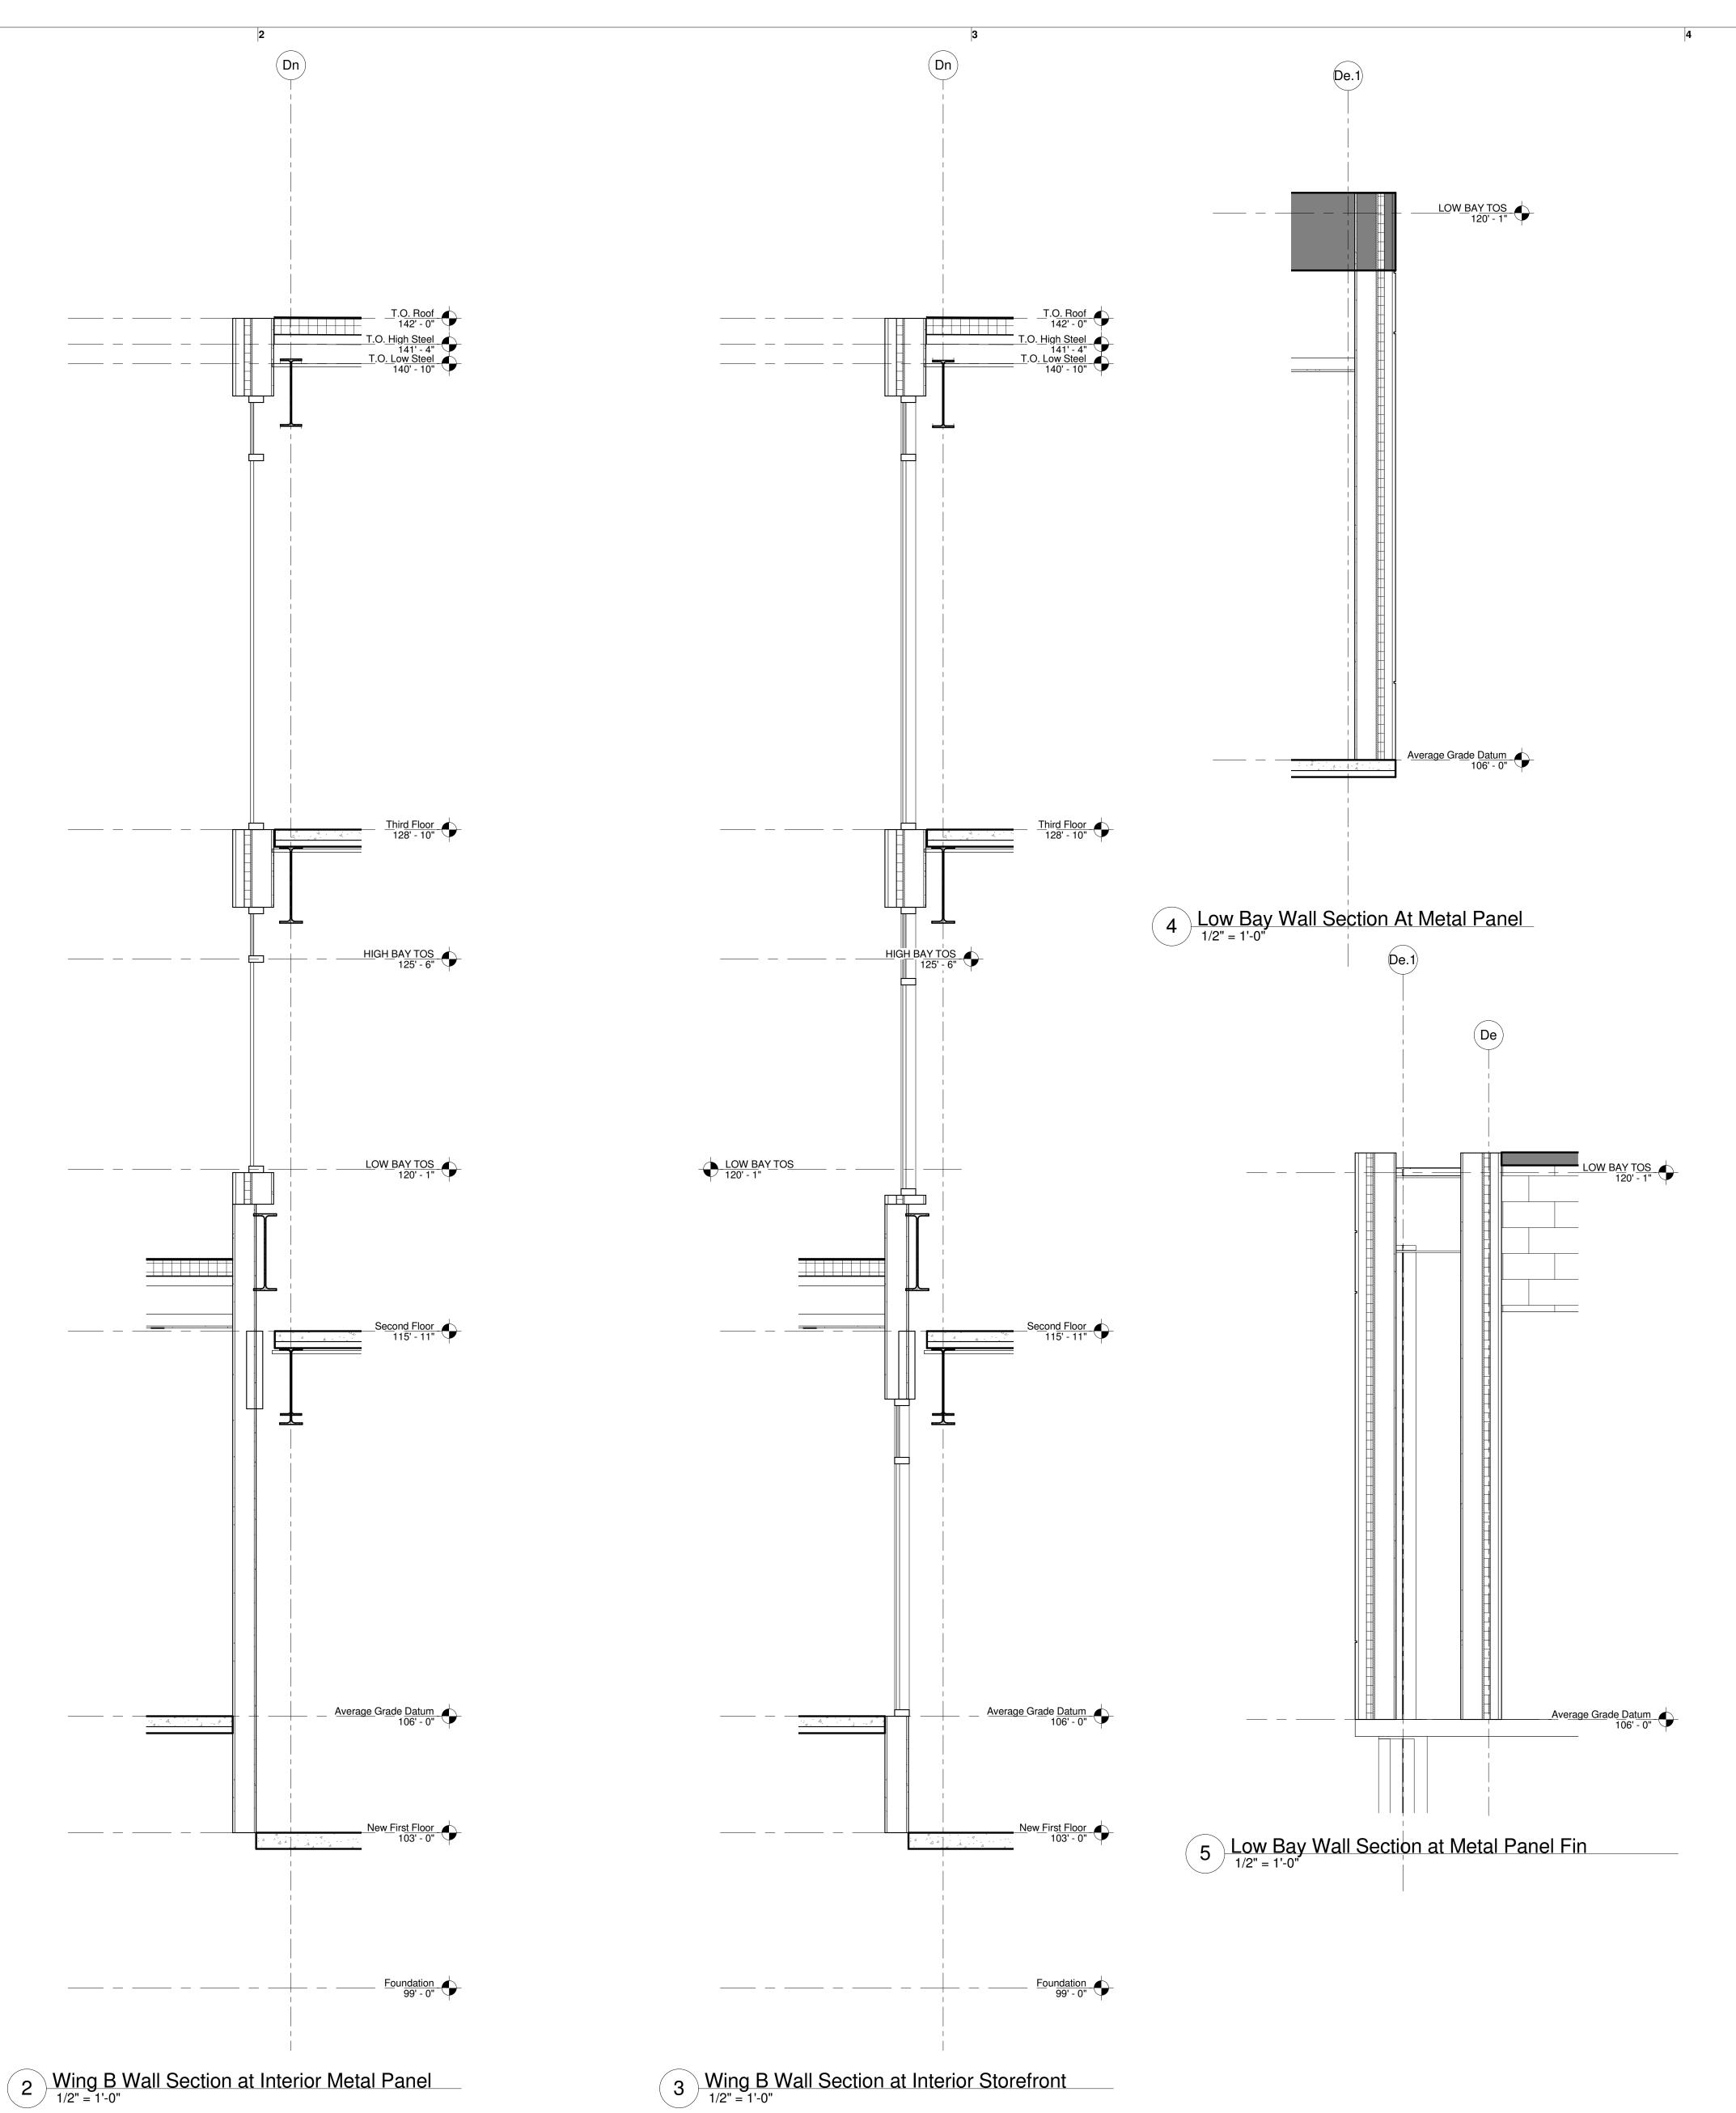



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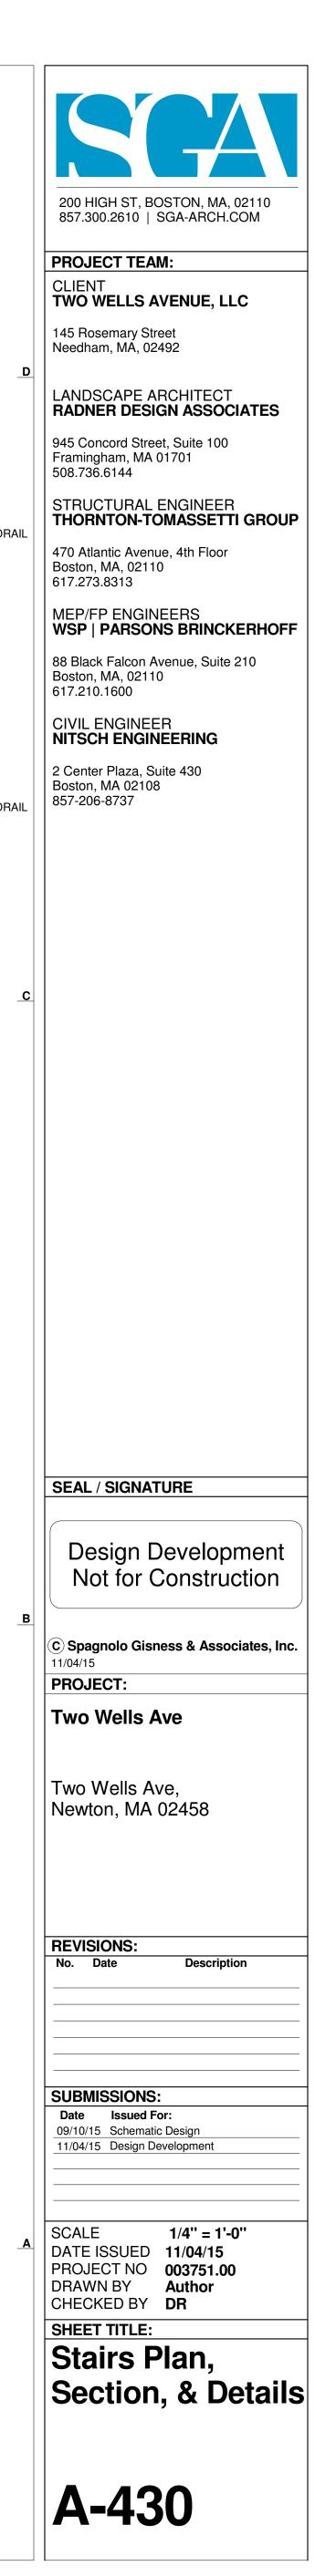
′ ER	TOILET TISSUE DISPENSER	SANITARY NAPKIN DISPOSAL (SURFACE MOUNT)	HOOK & BUMPER	GRAB BARS	WATER CLOSET	FRAMELESS MIRROR ABOVE COUNTER	ADA URINAL AND URINAL SCREEN	ADA WATER FOUNTAIN	TOIL PAR
		· · · ·	=						
<u> </u>			້. ອີ T ອີ		- e	WALL TO WALL. SEE SINK & MIRROR DETAIL	3'-0" L 1'-6"		
							MOUNTING HEIGHTS TO HC UNITS ONLY		STAINI STEEL
			₢ᢣ─ः፼			48"			
			lax.	1'-0" 3'-6"	WALL HUNG	<u>+</u>			60"
0		30" ADA	4' - 6" Max.	2' - 9" Min.			3, AF 8		
	ADA ADA	AI	4	- 0 30	19" Max.		A.F.F. 0 Max. AFF	SEE PLUMBING DRAWINGS	12
	F	G	Ĥ		J	K	M LS URINAL SCREEN	N	
¢	B-2840	B-270	B-212	B-5806.99X42	SEE PLUMBING DRAWINGS		SEE PLUMBING DRAWINGS	EZH20 - EZ (BI-LEVEL) VRC8V2	
	BOBRICK	BOBRICK	BOBRICK	BOBRICK			-	ELKAY	HA
	OWNER	OWNER	CONSTRUCT. MANAGER	CONSTRUCT. MANAGER	CONSTRUCT. MANAGER	CONSTRUCT. MANAGER	CONSTRUCT. MANAGER	CONSTRUCT. MANAGER	CO MA
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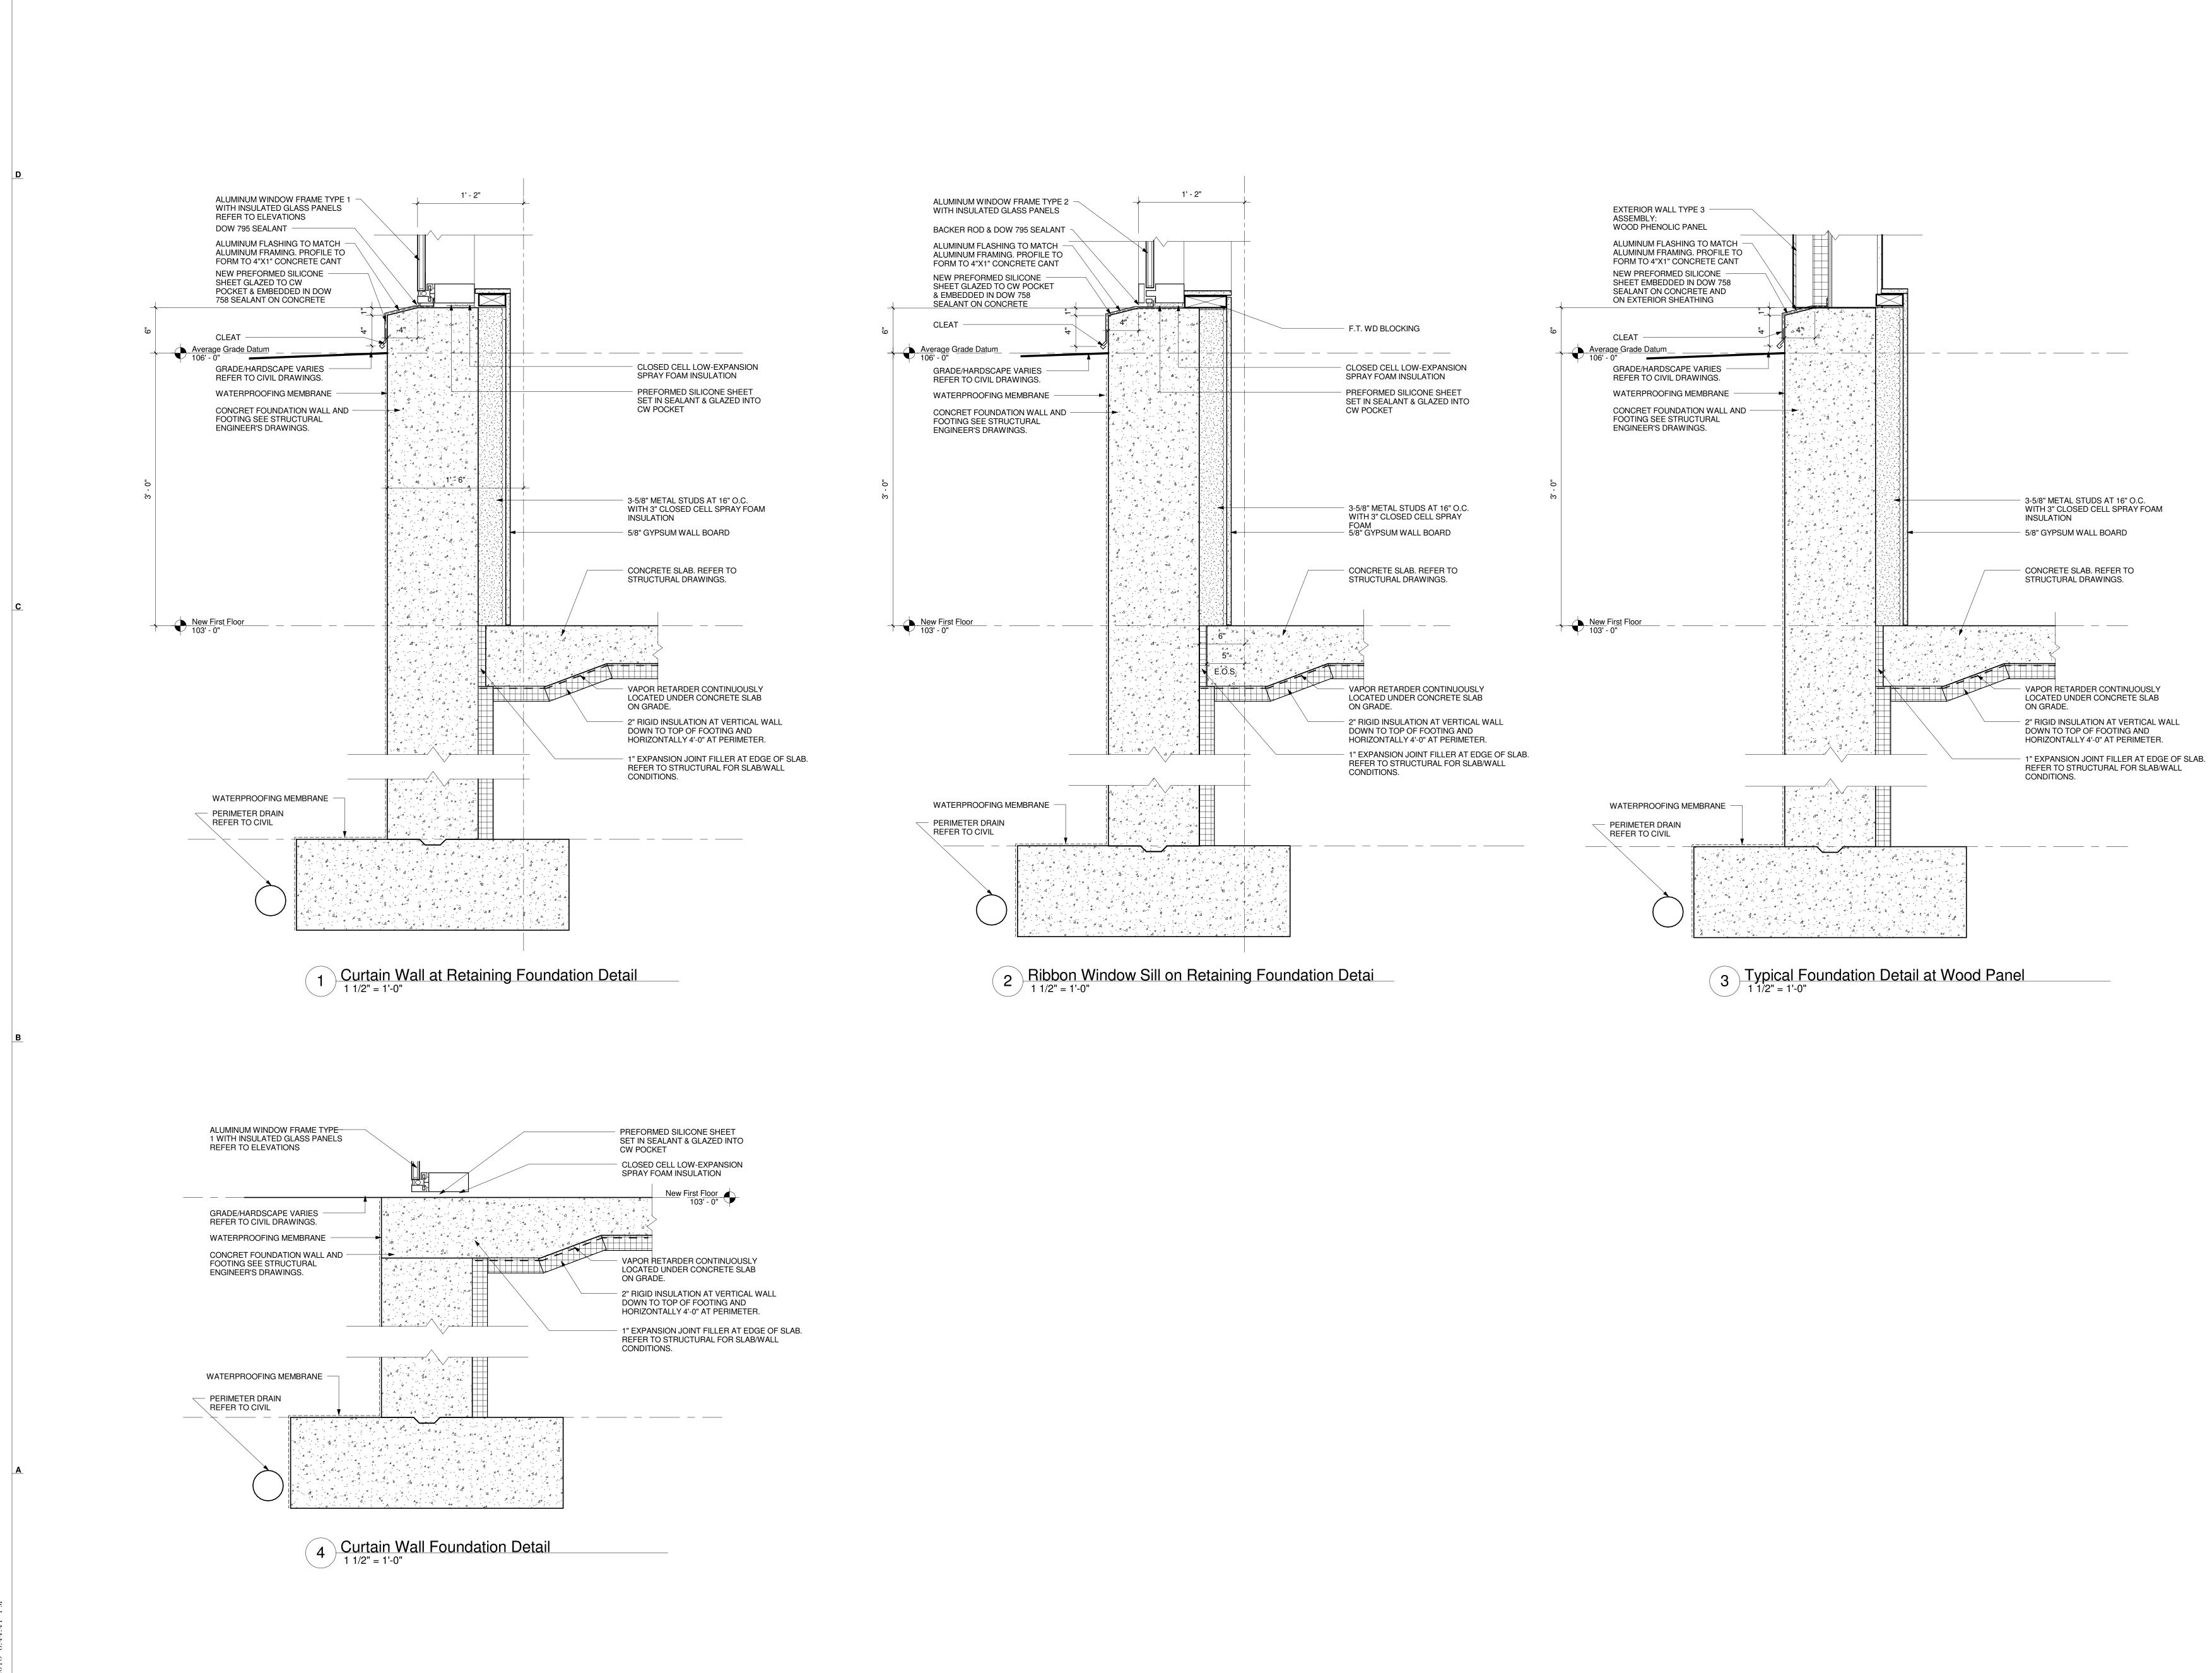





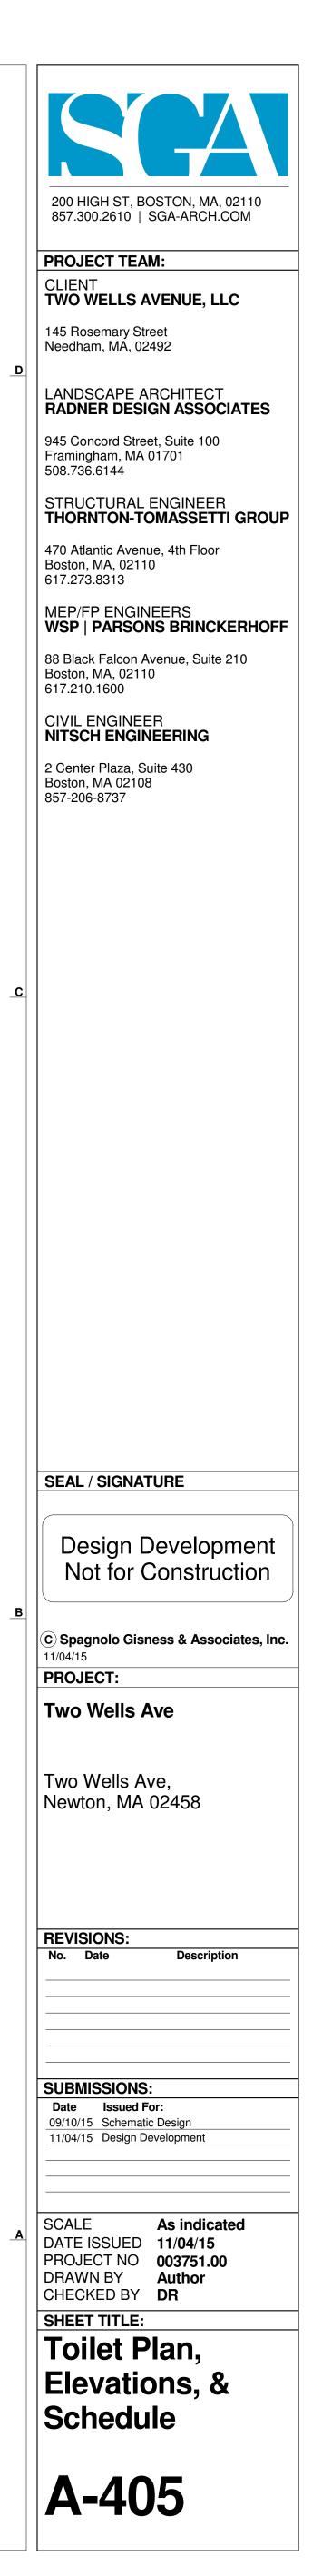


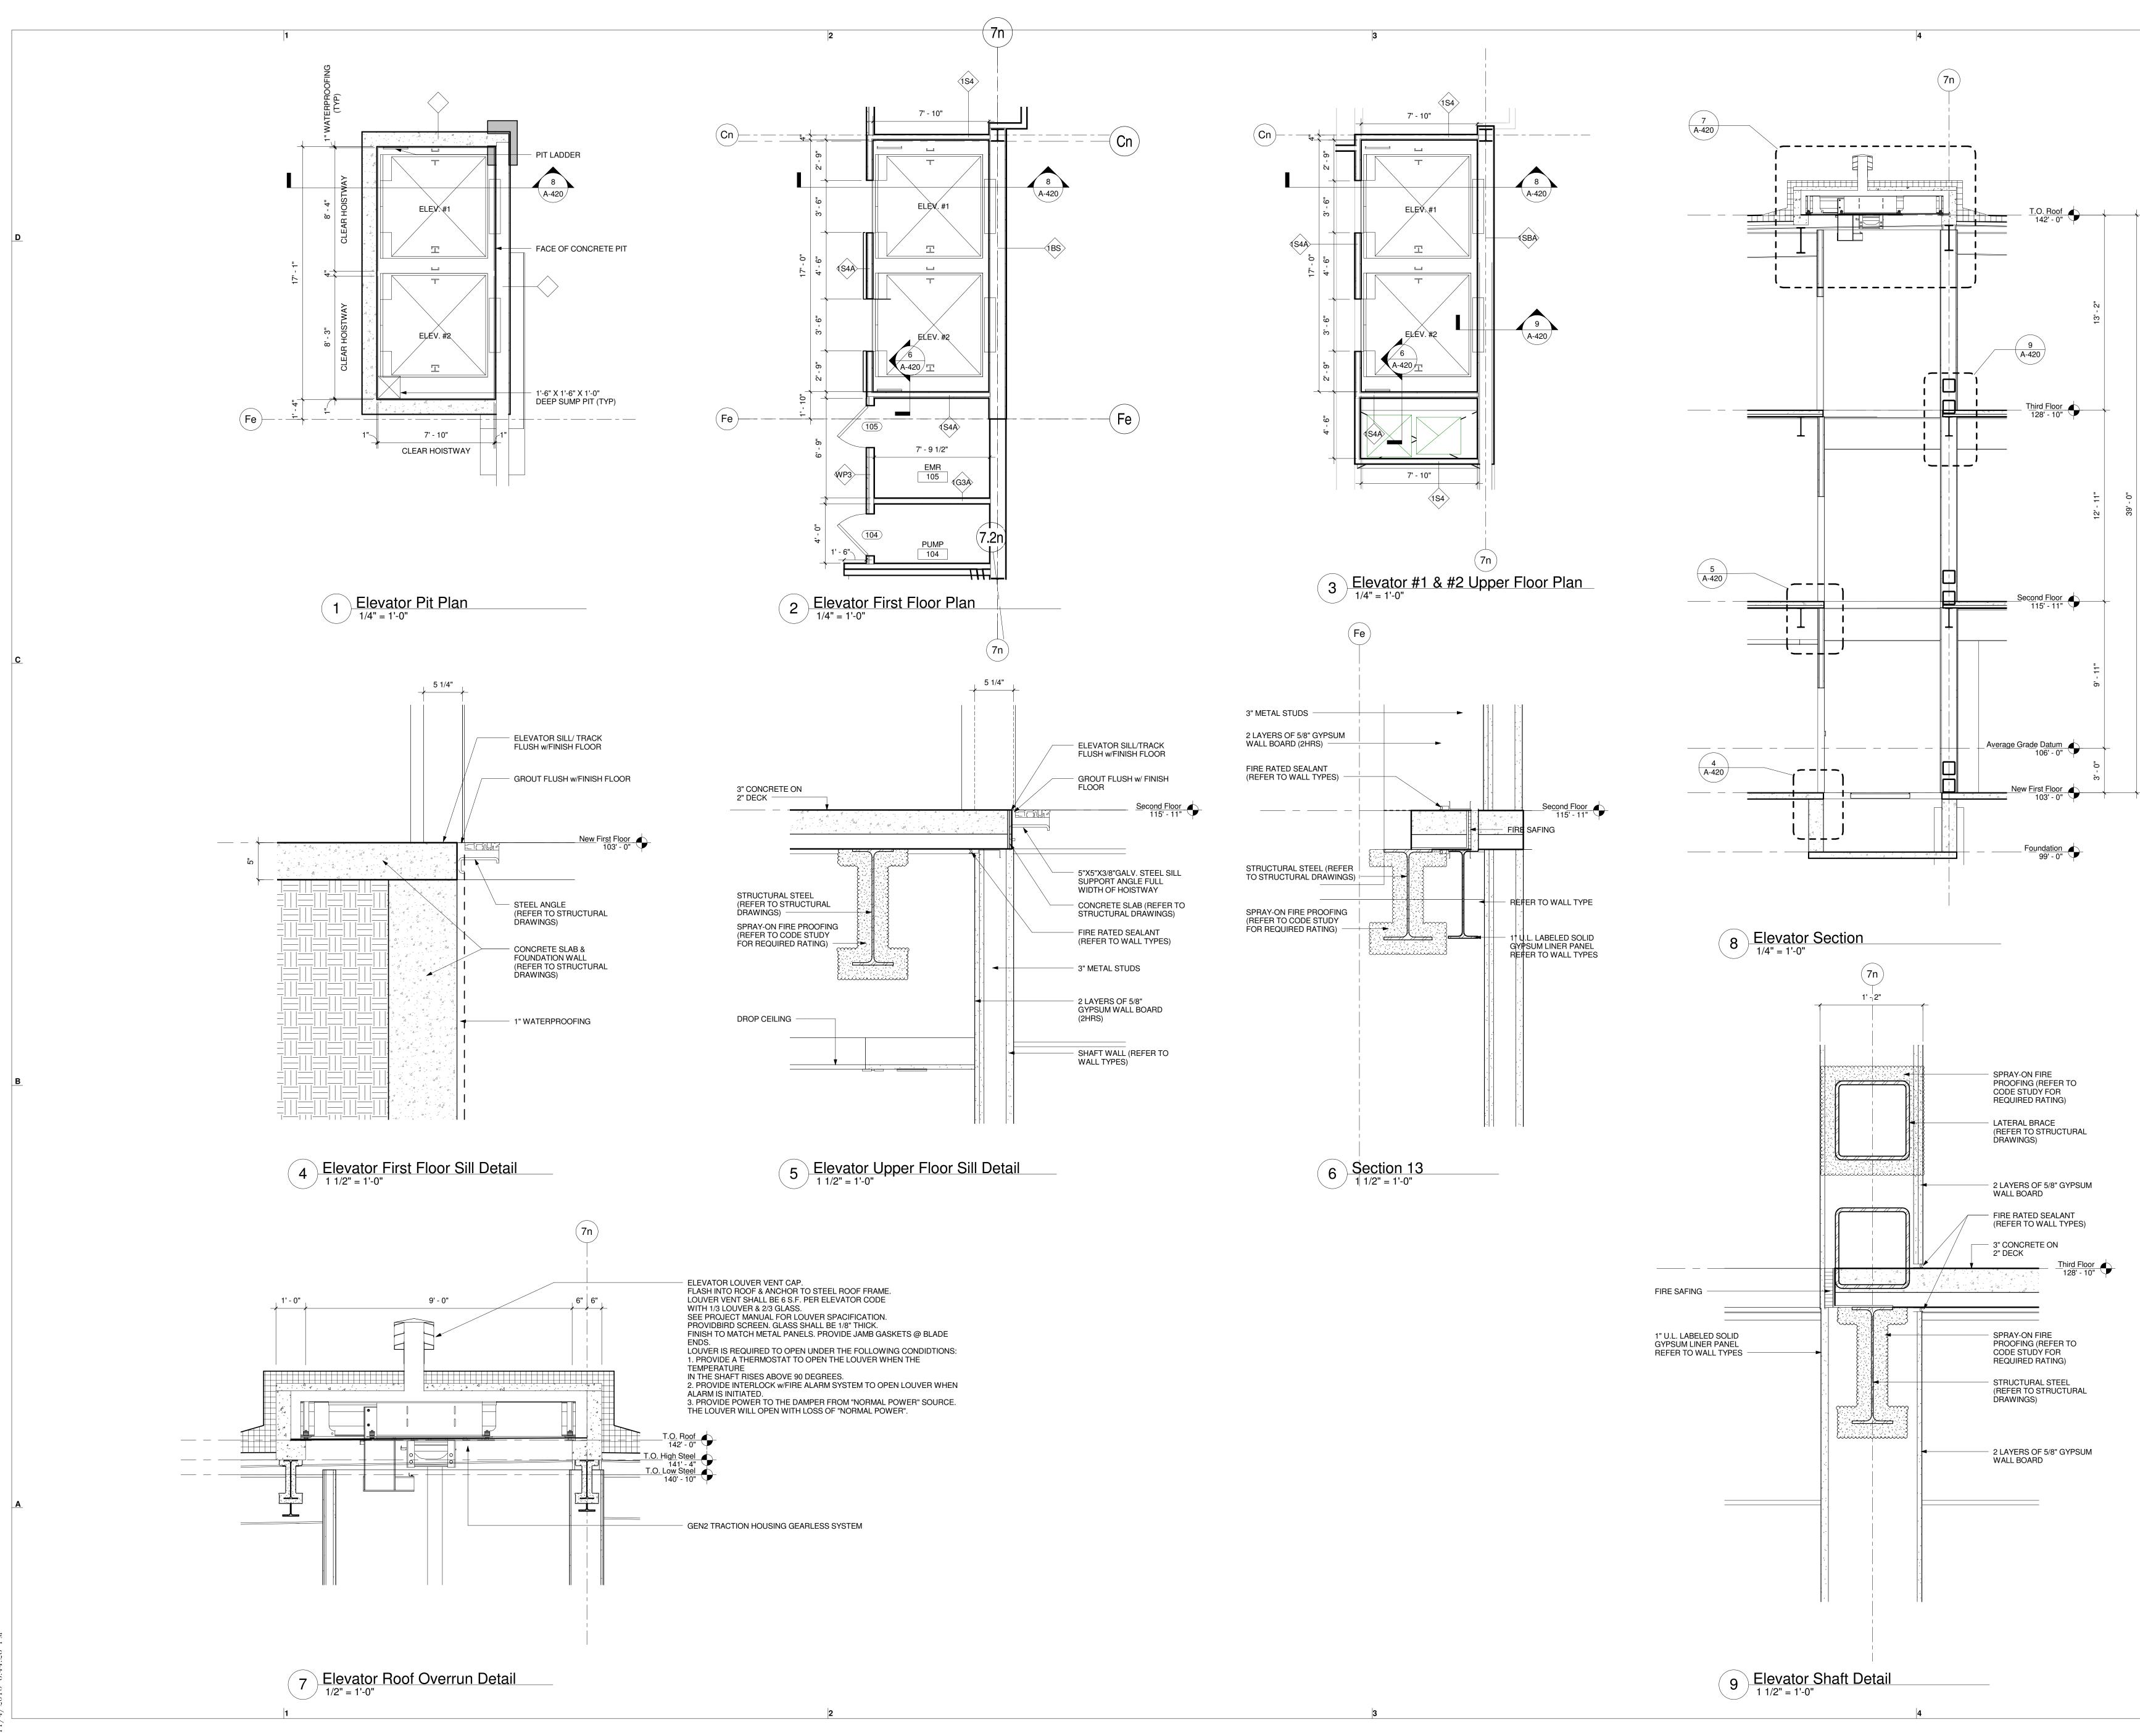

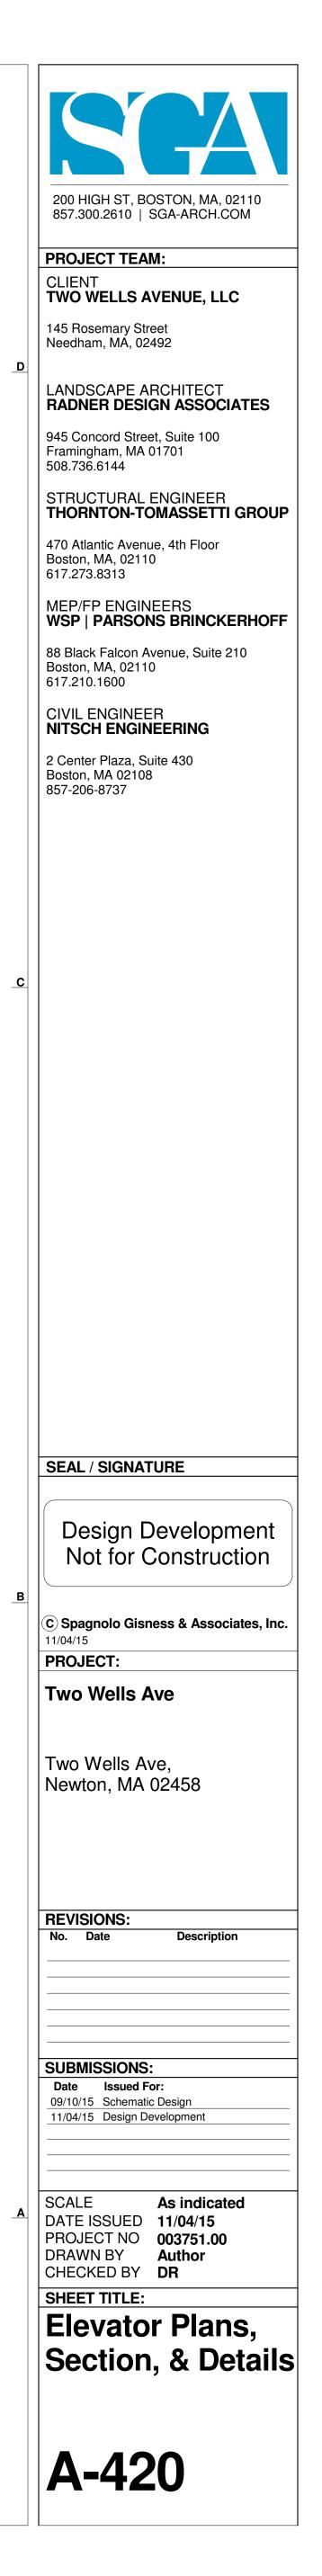


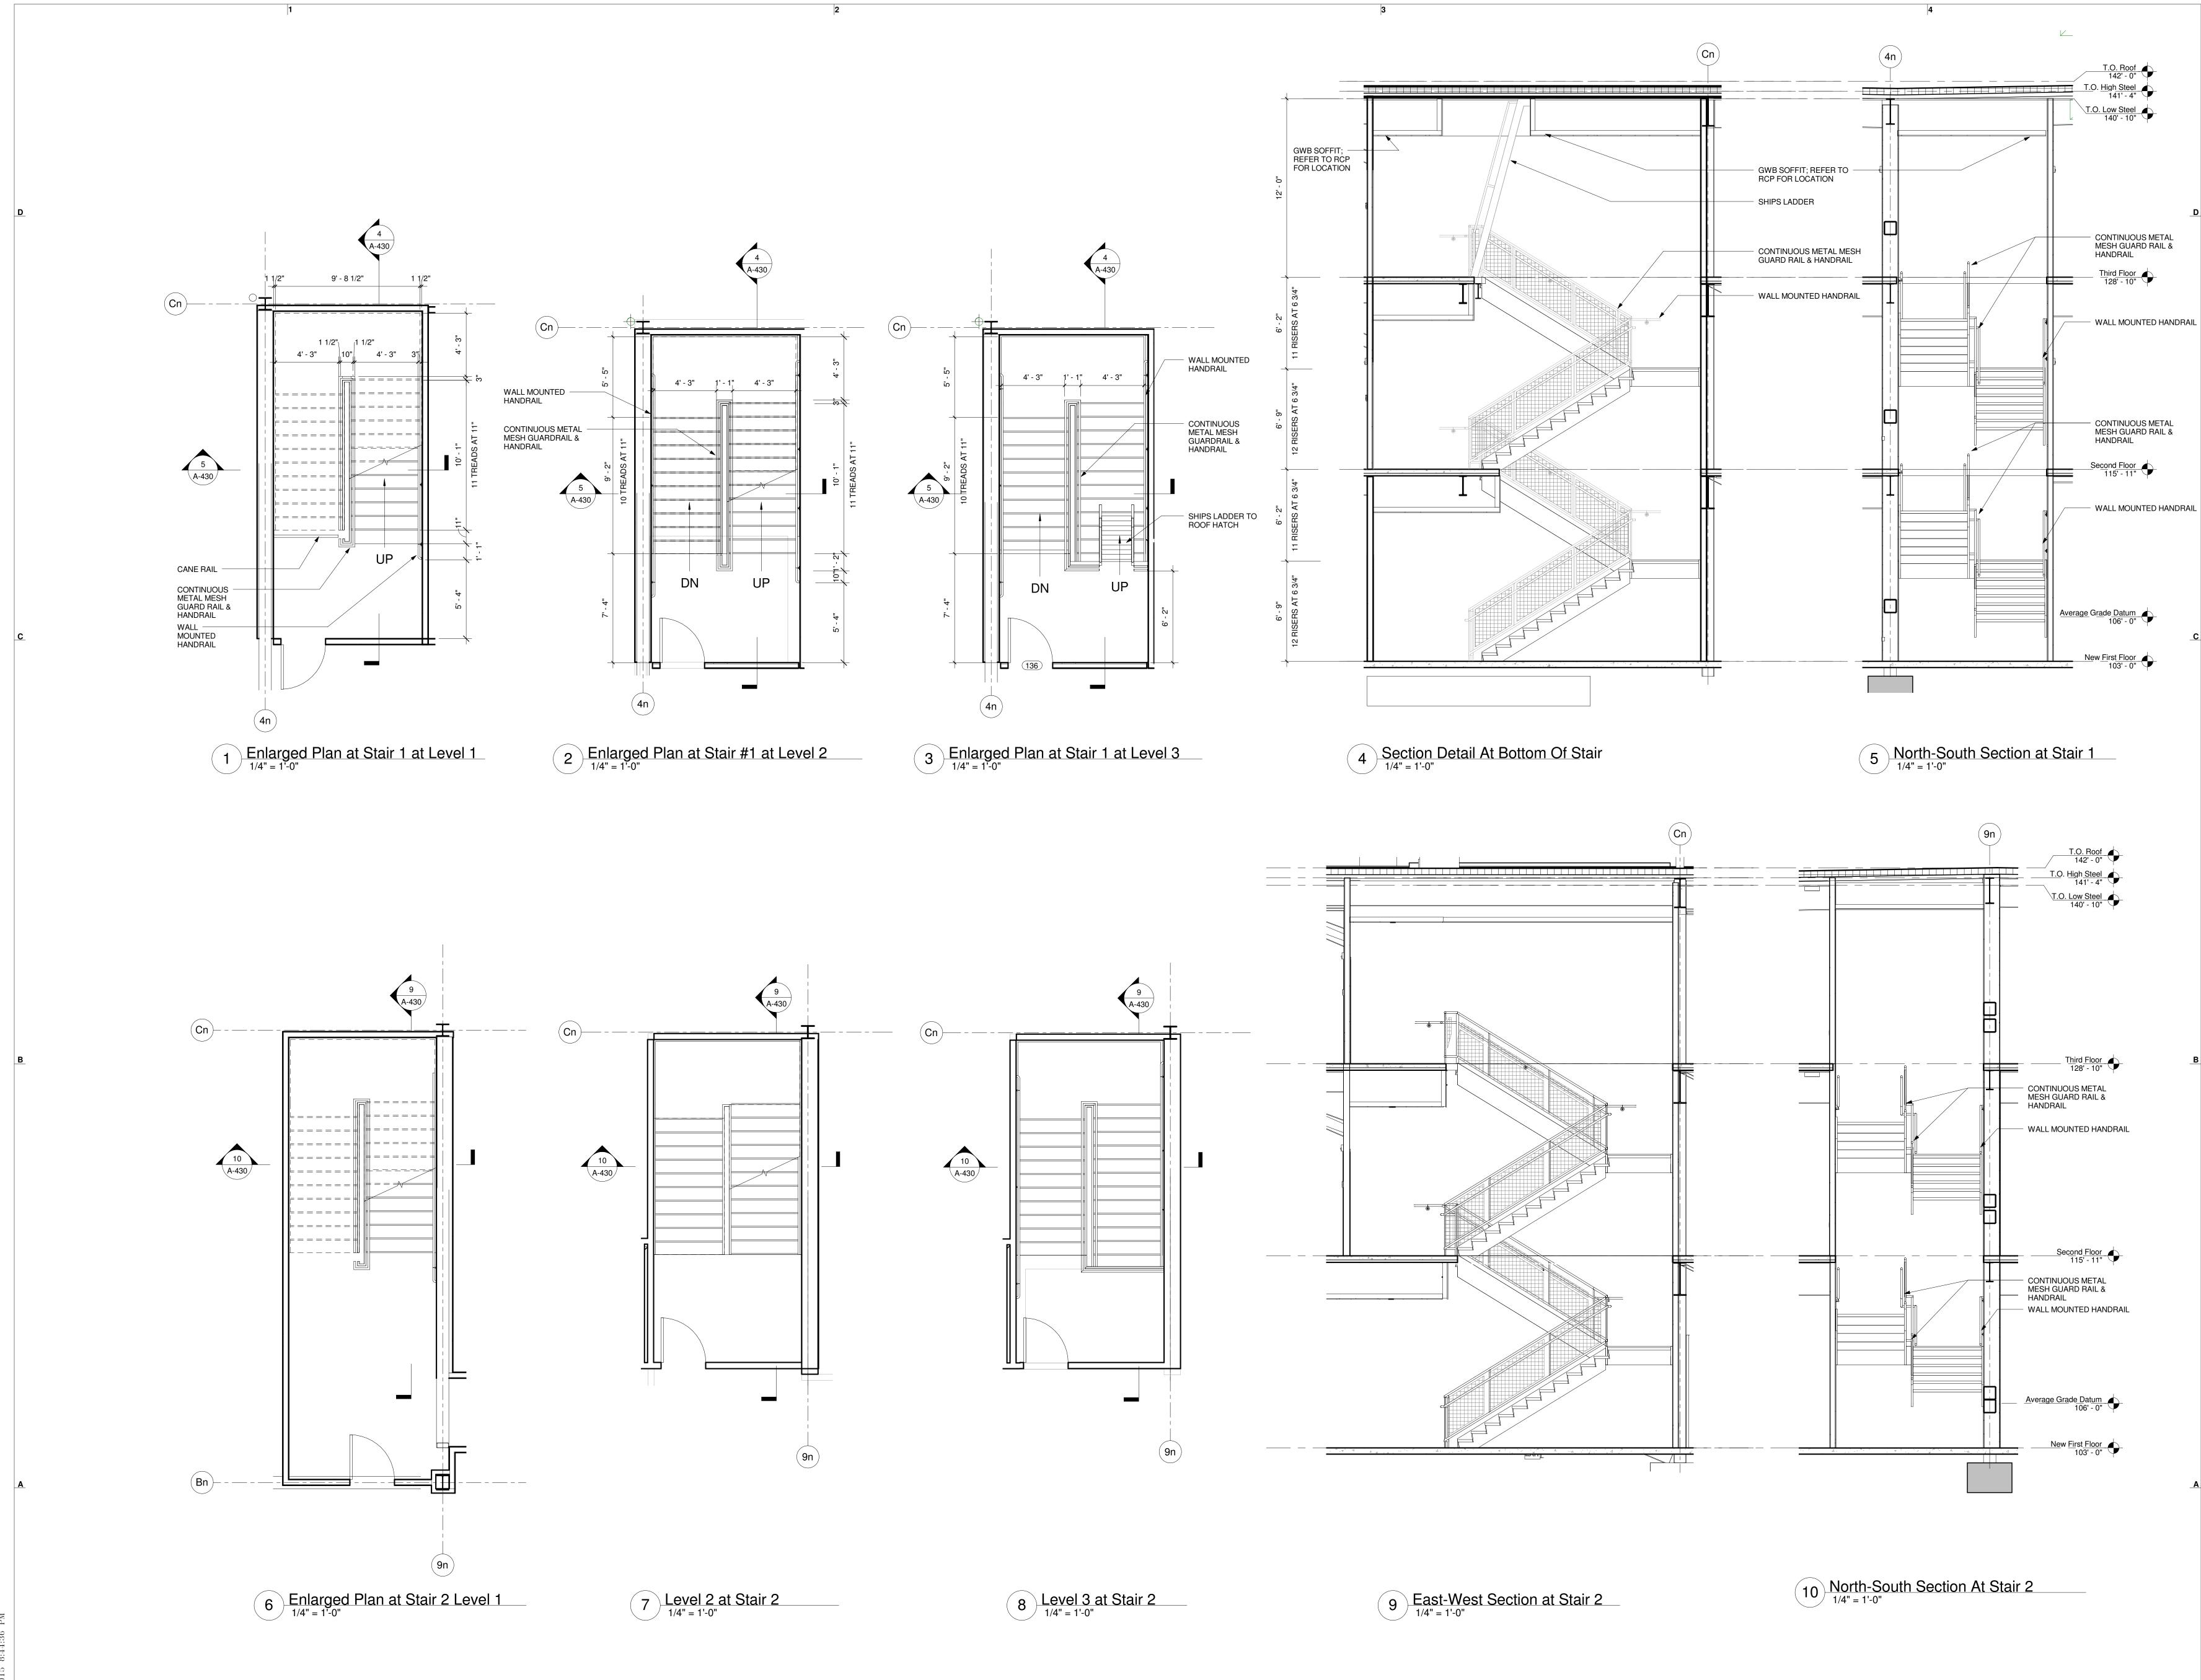

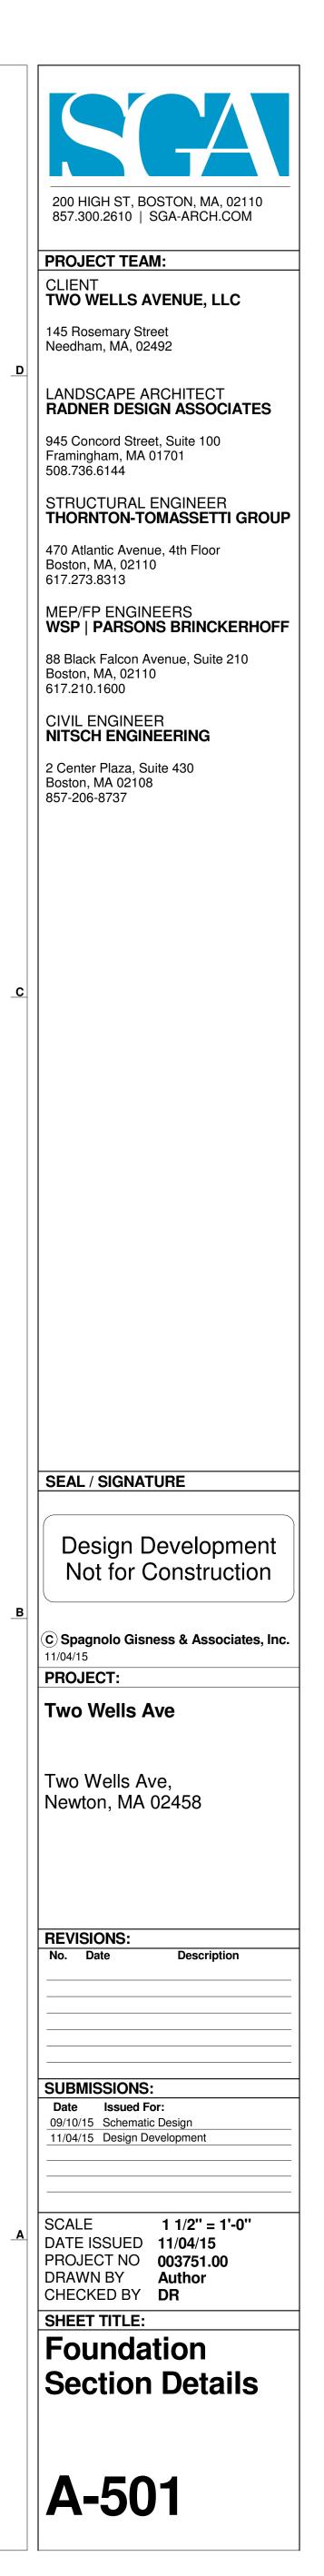


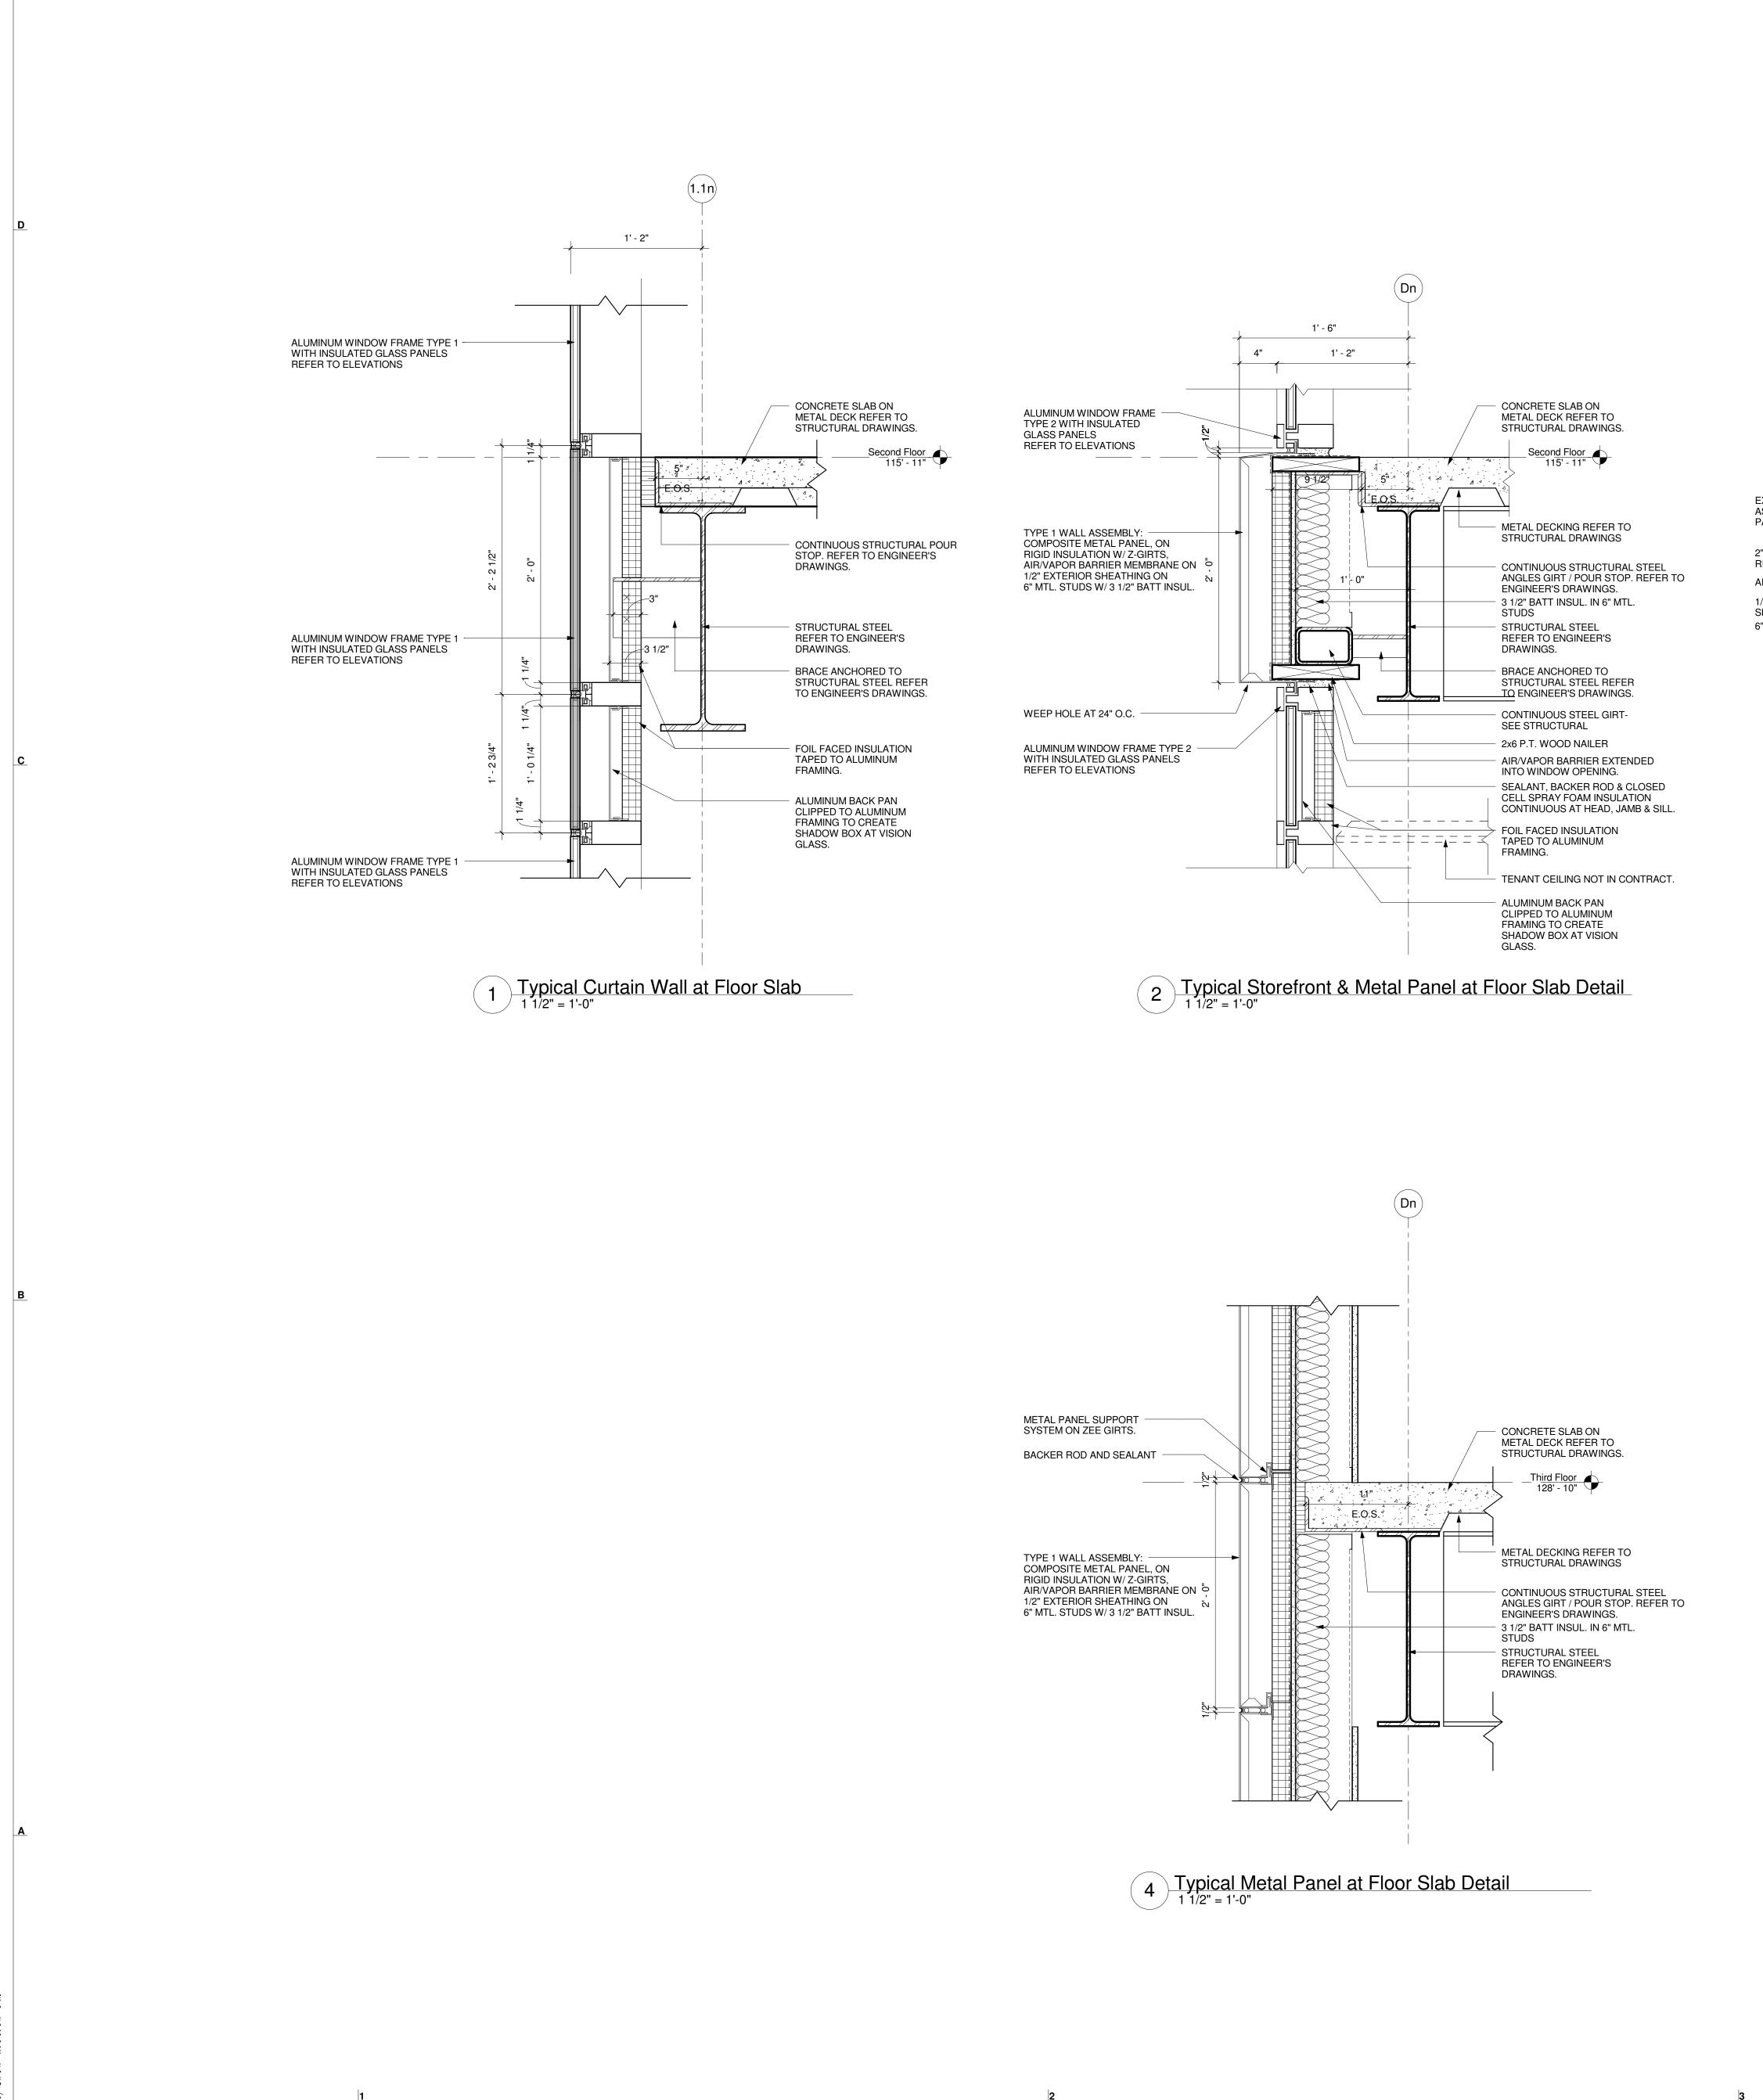



SHEATHING

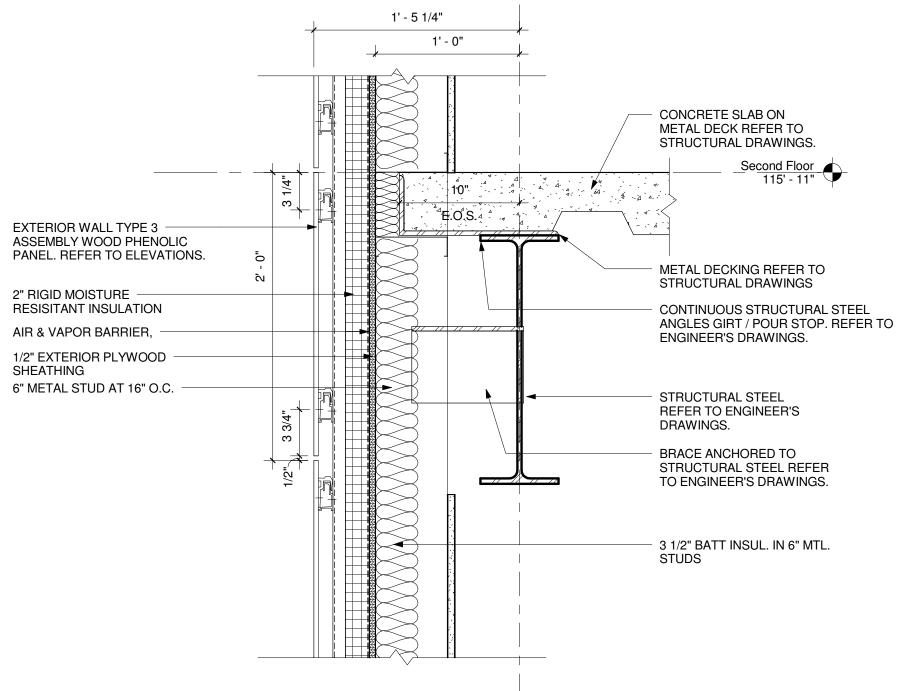


3 Typical Wood Panel at Floor Slab Detail

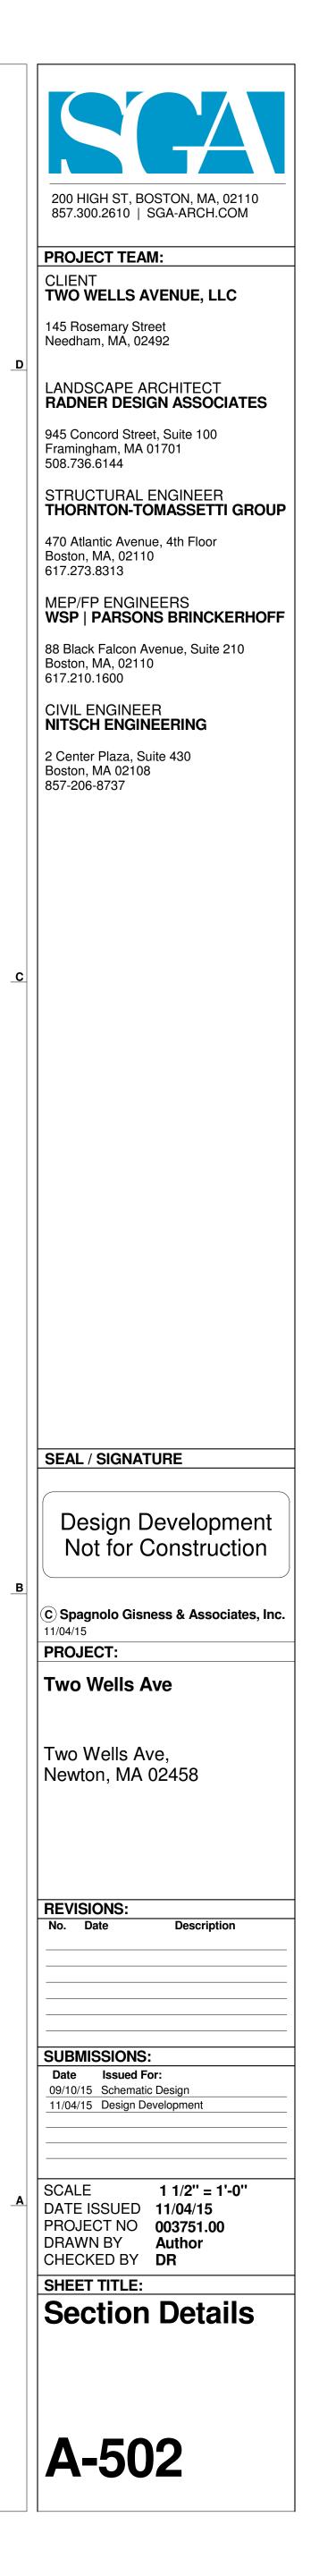

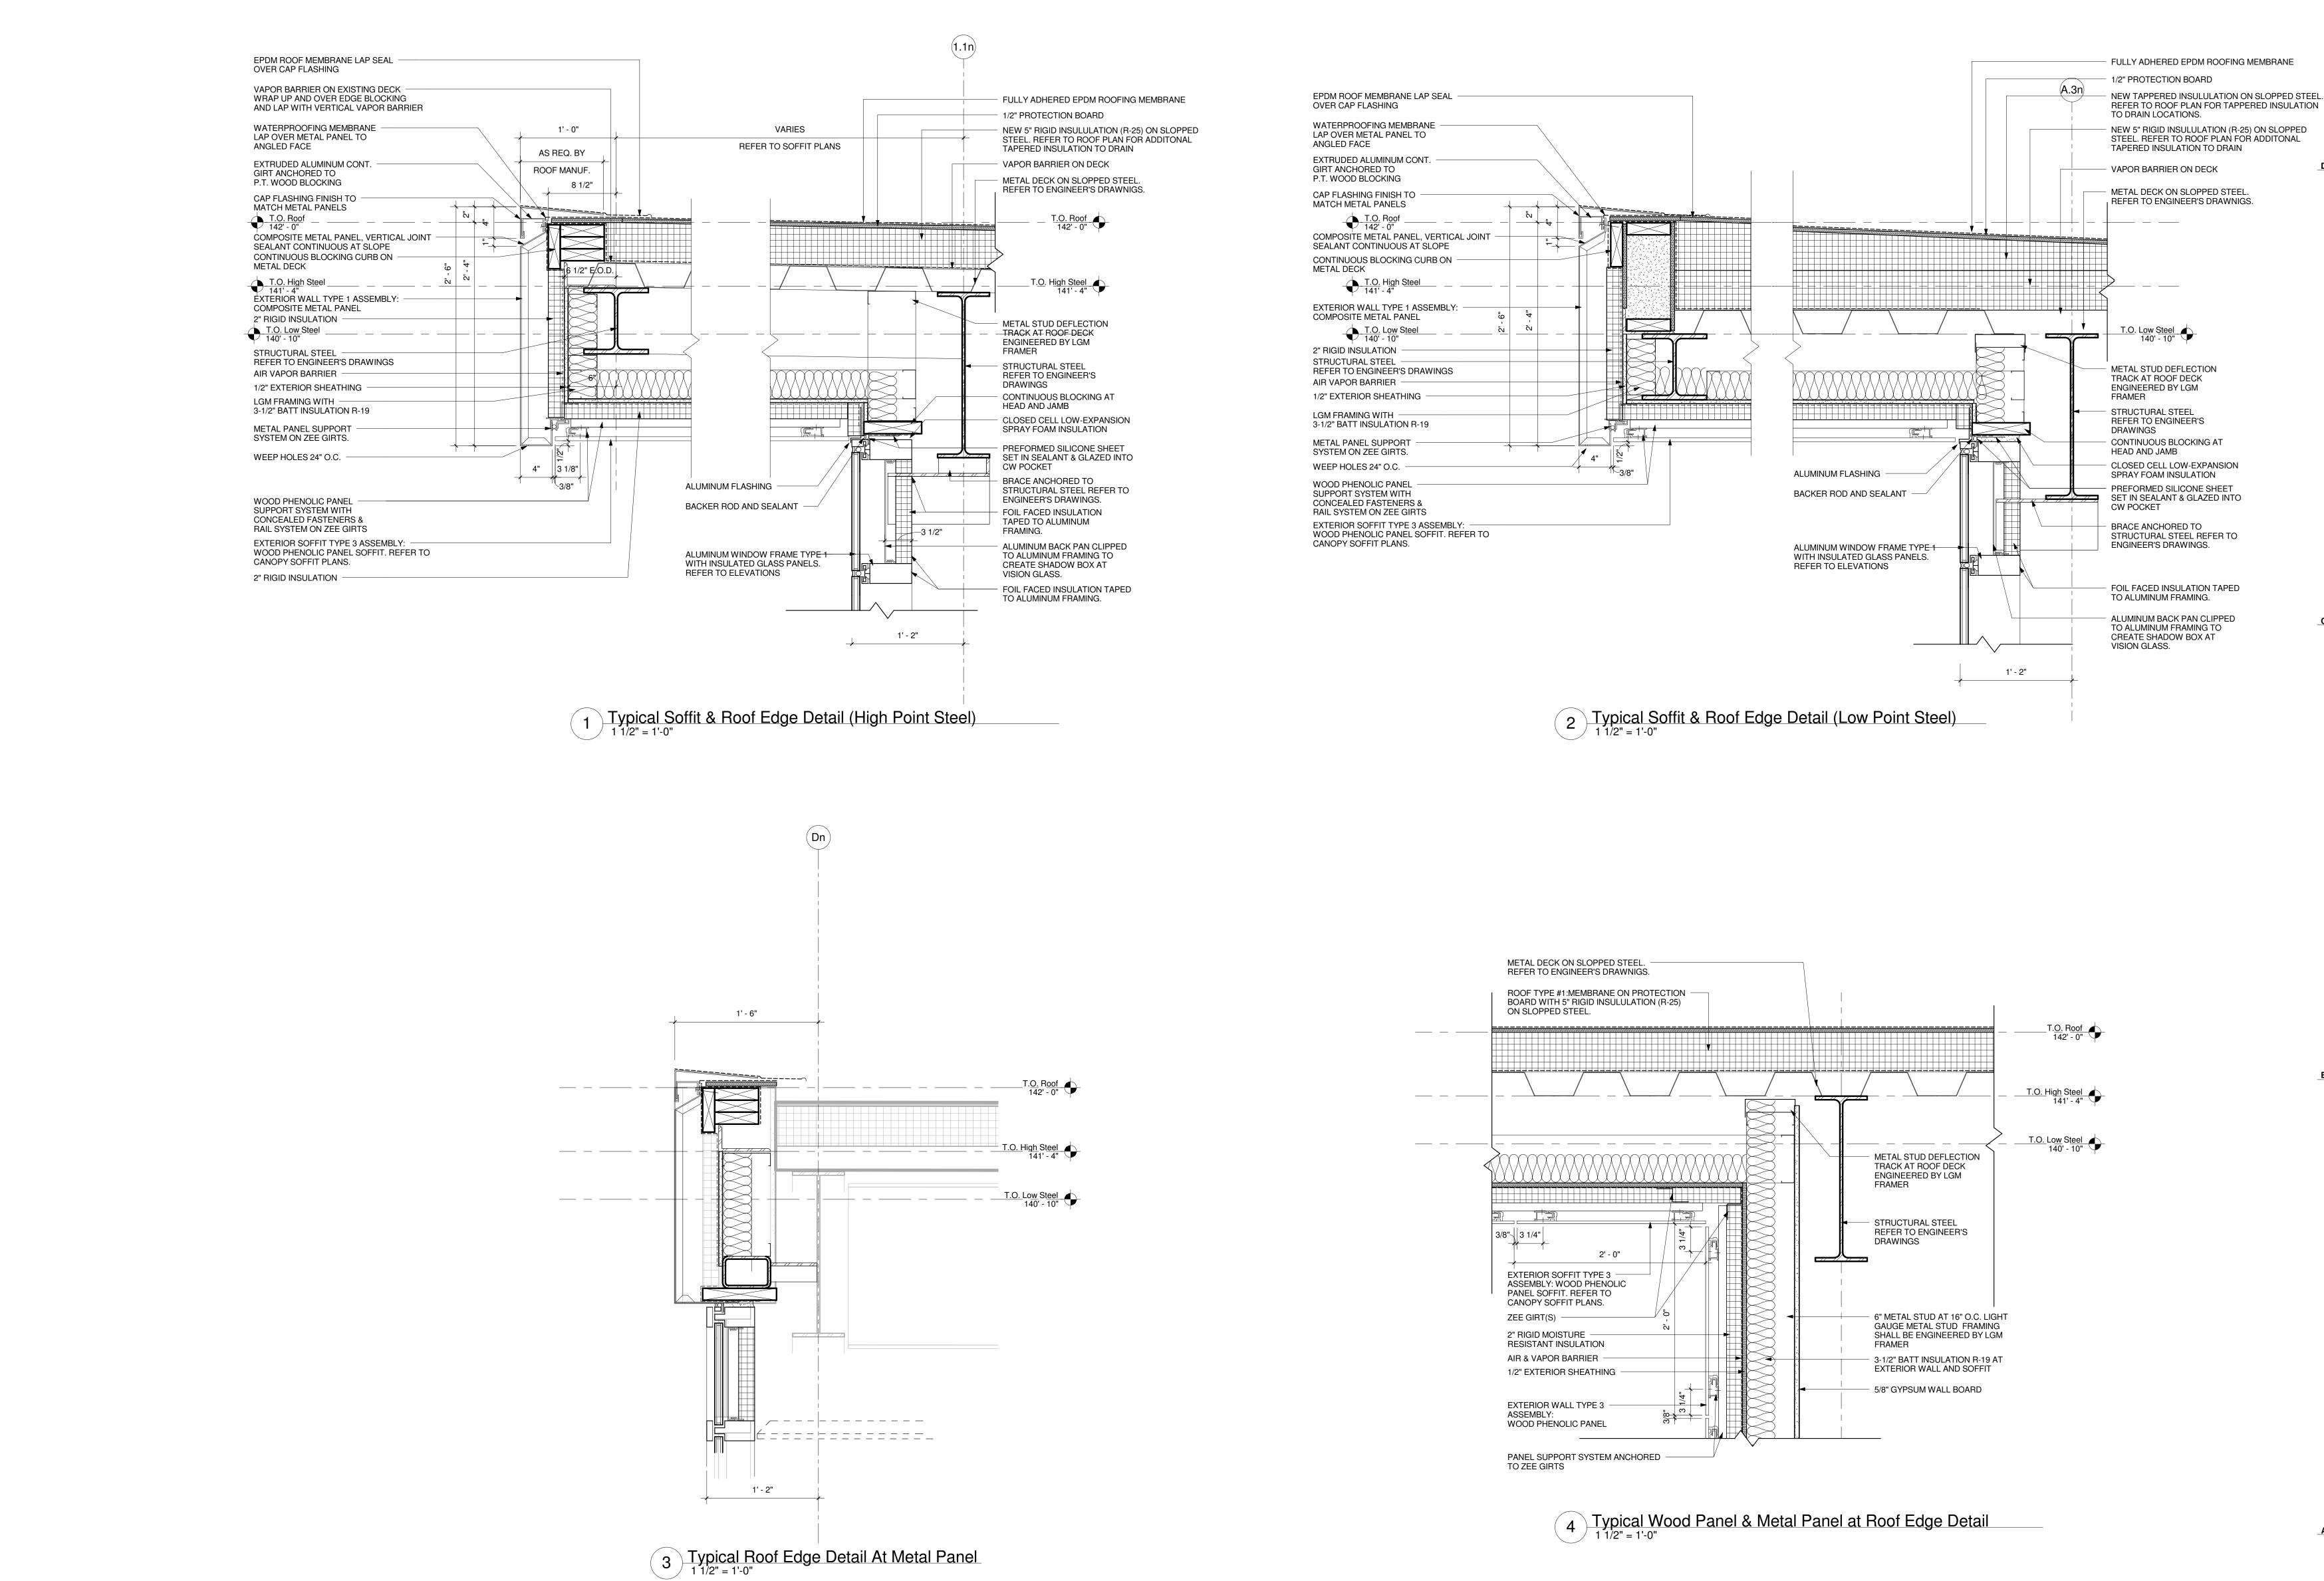

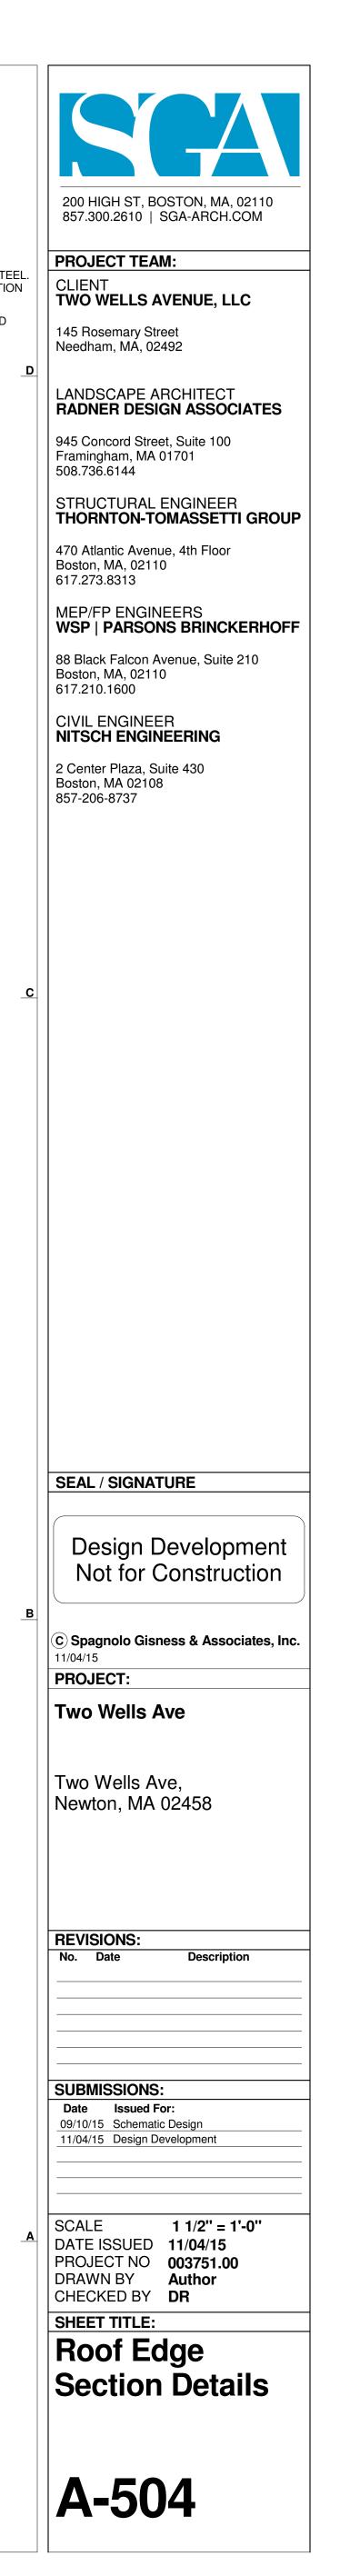

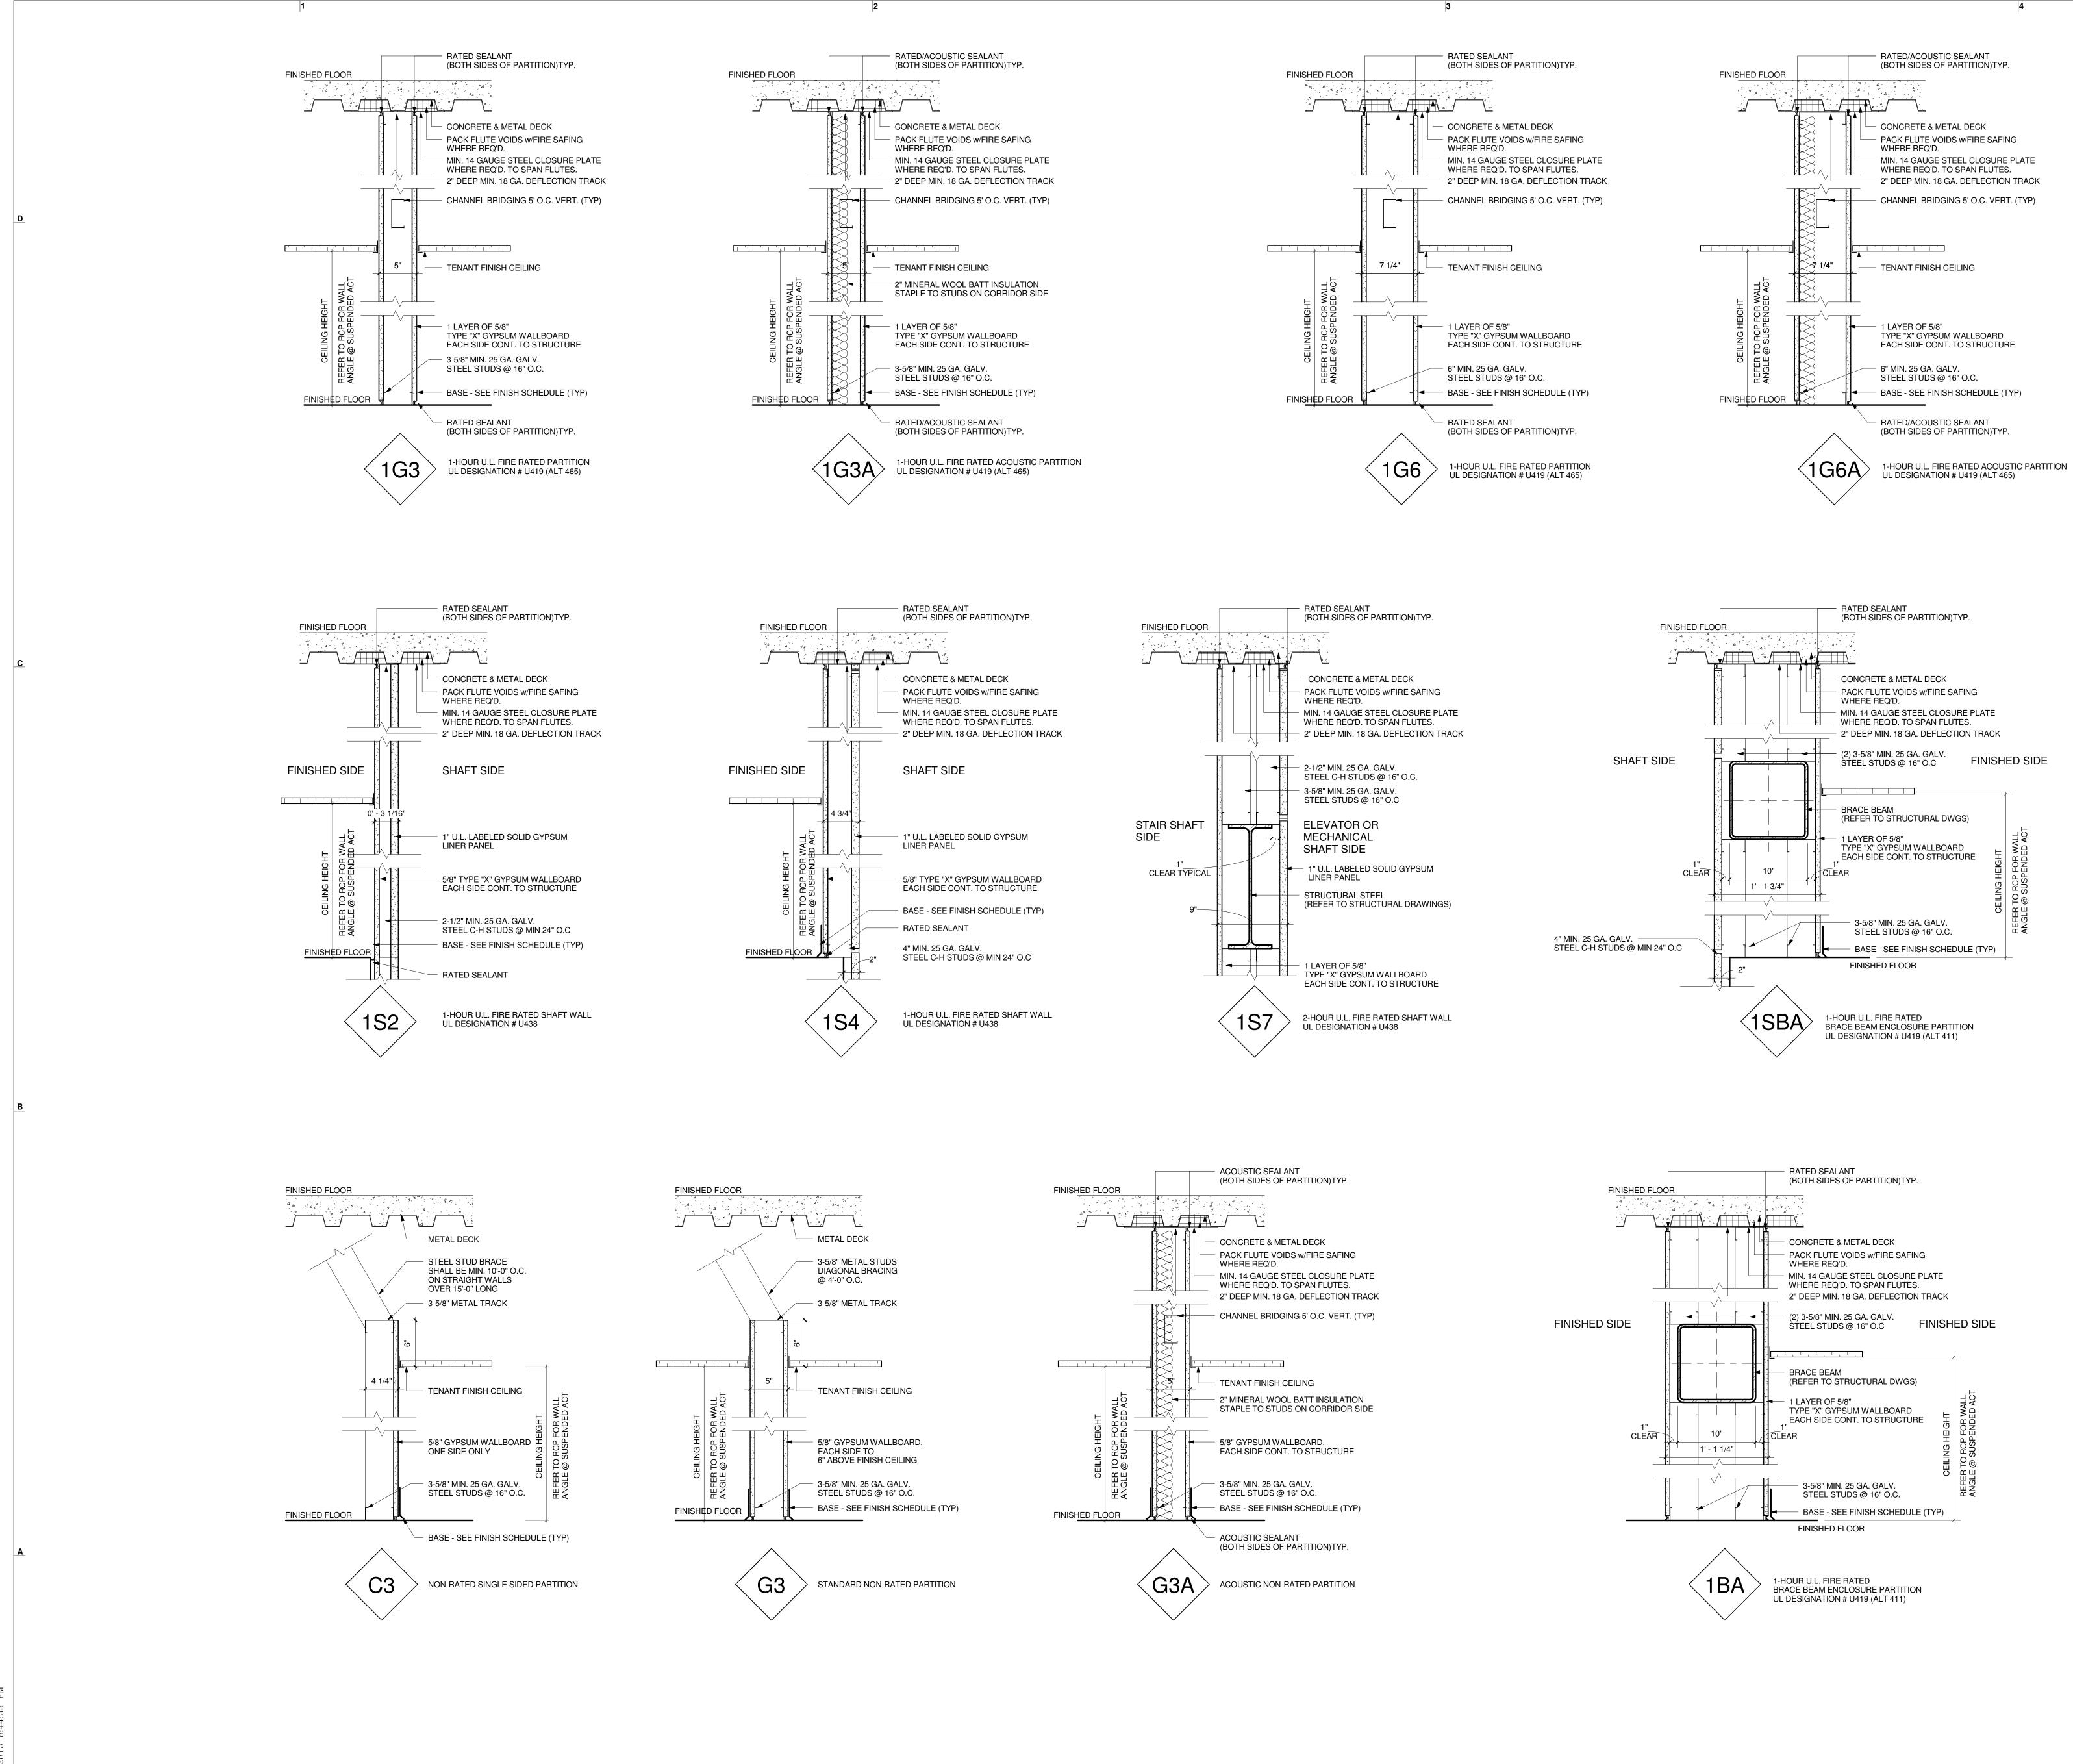

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