Two Wells Ave

Two Wells Ave, Newton, MA 02458

PROJECT TEAM:

CLIENT **TWO WELLS AVENUE, LLC** 145 Rosemary Street Needham, MA, 02492

ARCHITECT SGA 200 High Street Boston, MA, 02110 857.300.2610



LANDSCAPE ARCHITECT **RADNER DESIGN ASSOCIATES**

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STRUCTURAL ENGINEER **THORNTON-TOMASSETTI GROUP**


470 Atlantic Avenue, 4th Floor Boston, MA, 02110 617.273.8313


Boston, MA 02210 617.210.1600

CIVIL ENGINEER **NITSCH ENGINEERING** 2 Center Plaza, Suite 430 Boston, MA 02108 857-206-8737

MEP/FP ENGINEERS WSP | PARSONS BRINCKERHOFF

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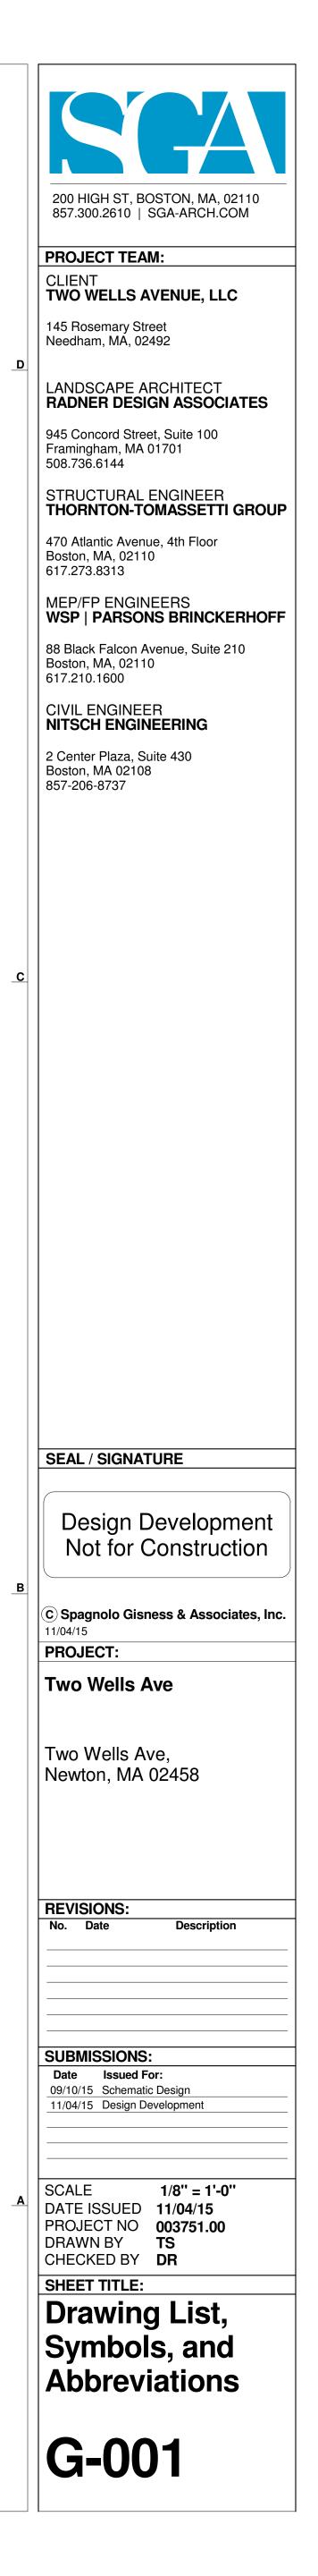


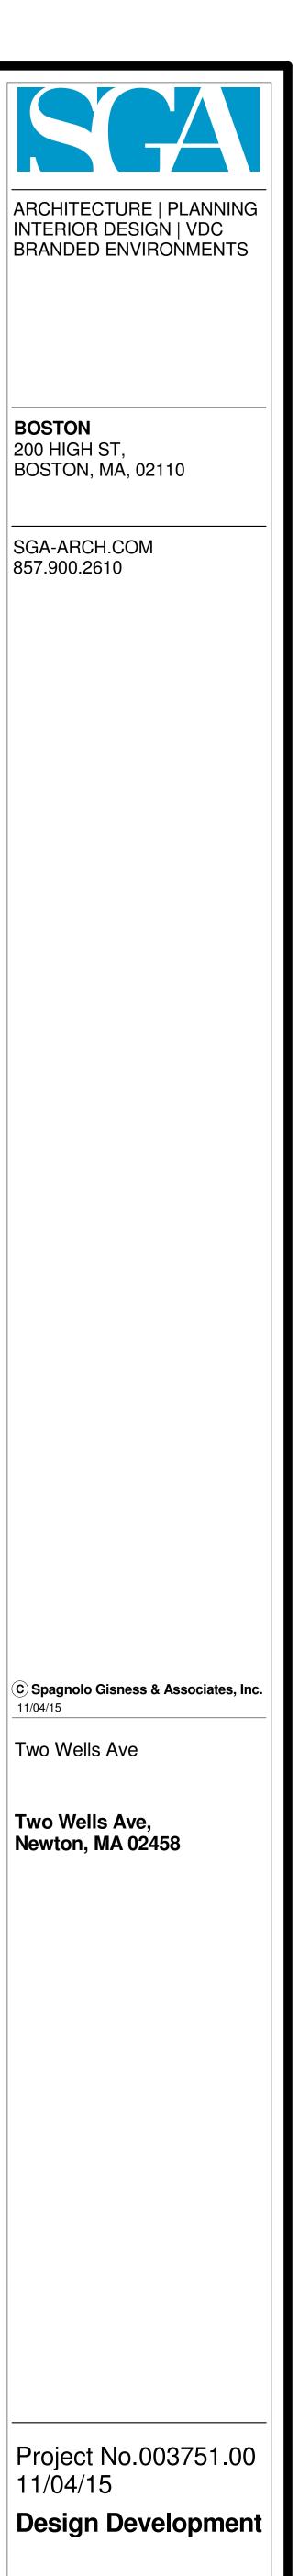


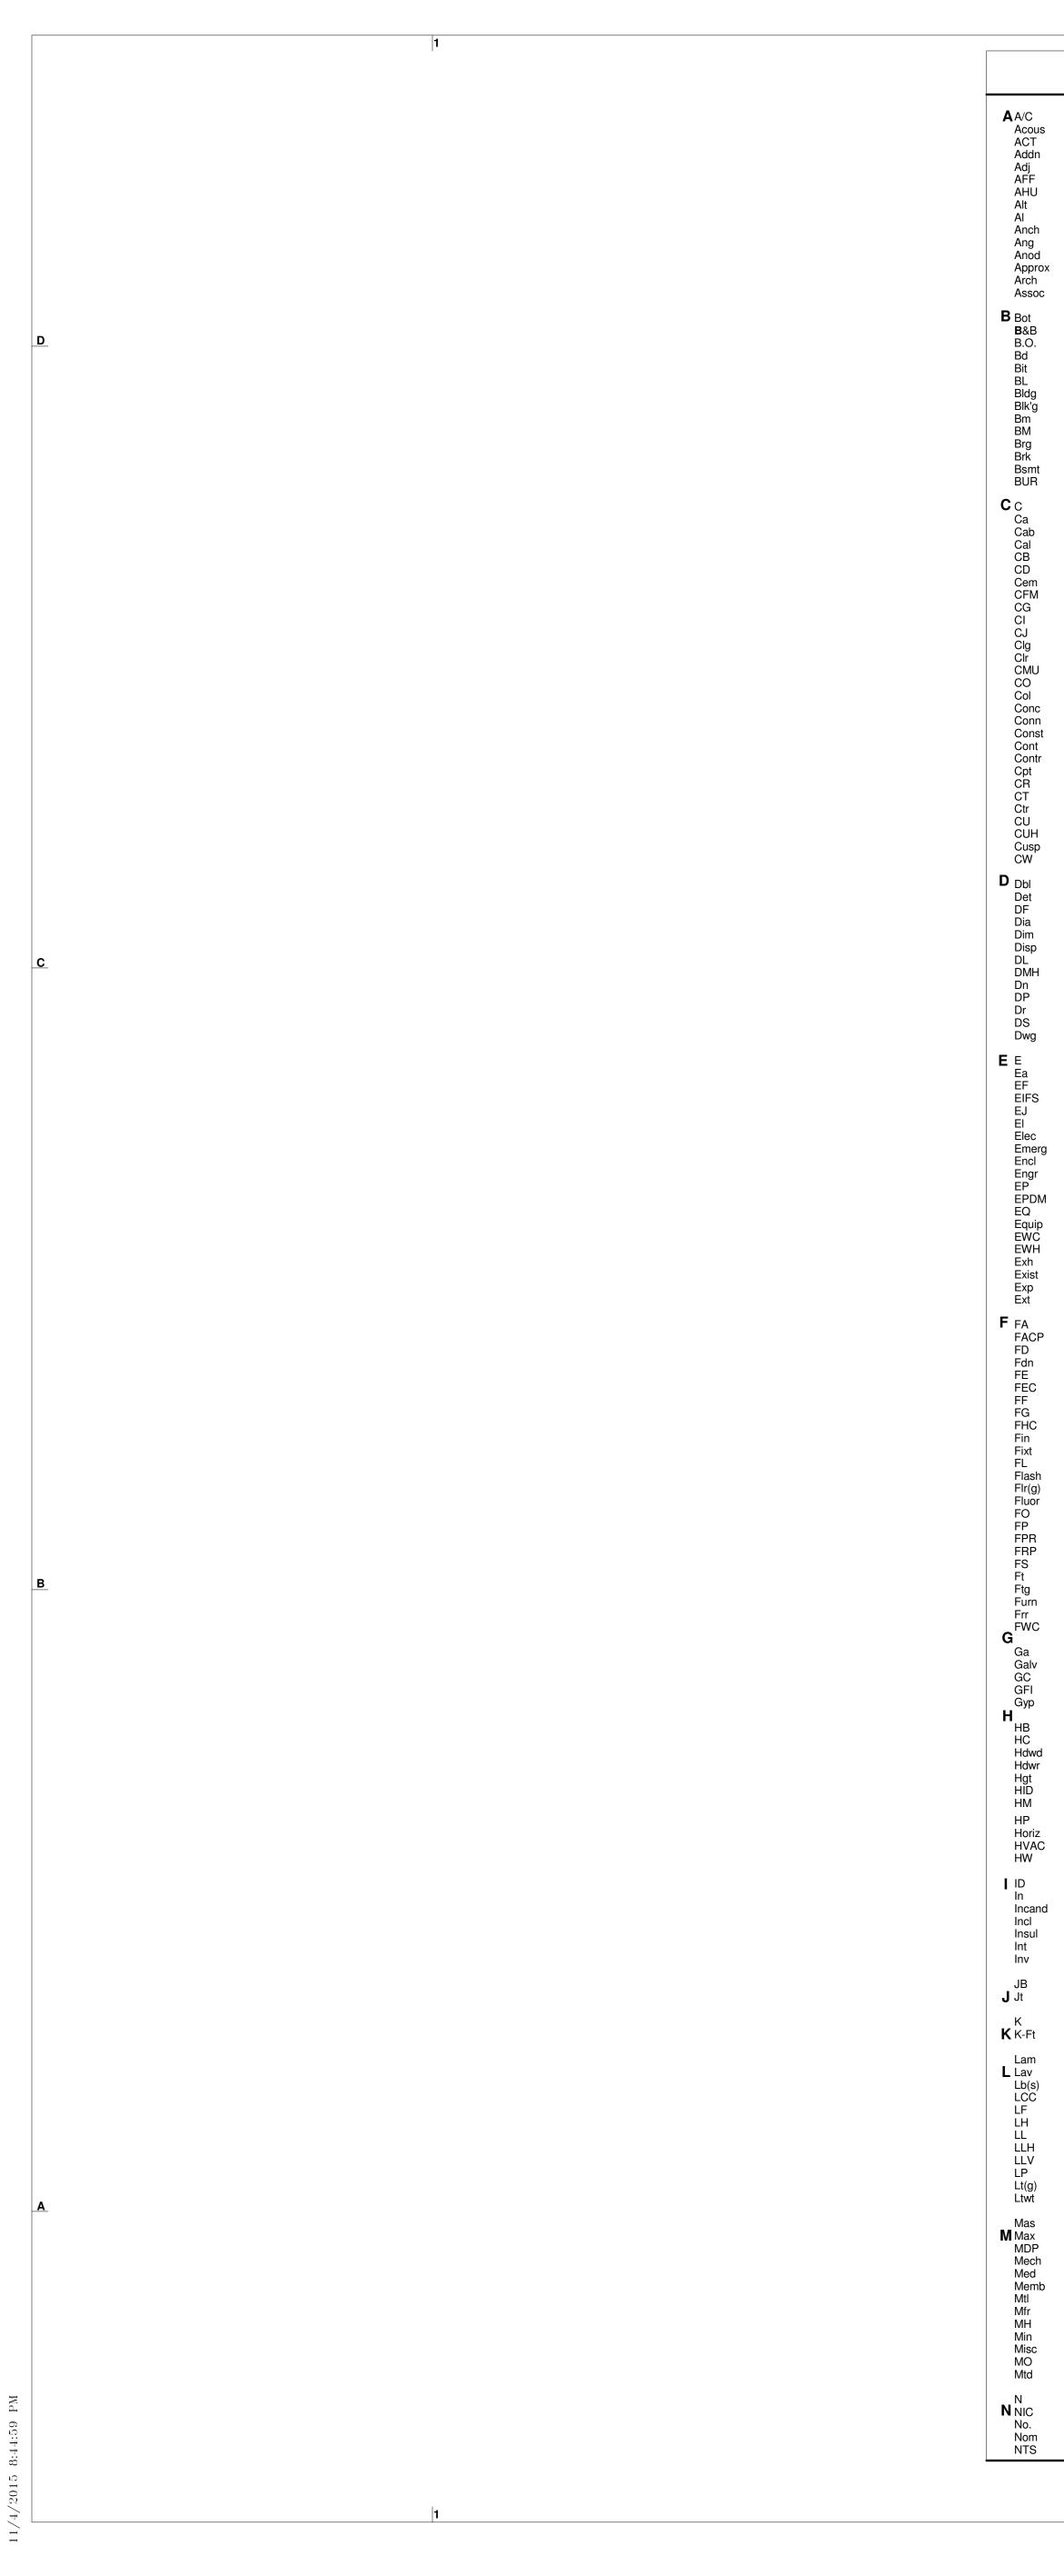
| Abbreviations | | | | Tags & Symbols | | | | |
|------------------|--|-----------------------|---|--|---|--|--|--|
| | Air Conditioning Acoustical | O OC | On Center(s) | General | | | | |
| T In | Acoustical Ceiling Tile Addition Adjacent | OD OI Opg | Outside Diameter Open Item Opening | Sheet Number | 0 Keynote Number | | | |
| = J | Above Finished Floors Air Handling Unit Alternate | Opp ORD Oz | Opposite Overflow Roof Drain Ounce | A512 | | | | |
| h | Aluminum Anchor Angle | P PA PCF | Project Architect Pounds Per Cubic Foot | Sheet Number | Annotation Text | | | |
| od prox | Anodized Approximate Architect | Perf Pl Plam | Perforated Plate Plastic Laminate | Category Number Discipline Letter | | | | |
| 60C | Associated Bottom | Plas Plbg PLF | Plaster Plumbing Pounds Per Linear Foot | Discipline | Annotation Tag Number- Boxed | | | |
| B). | Balled and Bur Lapped Bottom of Board | Plywd Pnl Pol | Plywood Panel Polish(ed) | G GENERAL C CIVIL L LANDSCAPE | € Center Line | | | |
| a | Bituminous Building Line Building | PP Pr Proj | Power Panel Pair Project | S STRUCTURAL A ARCHITECTURAL | د Center Line | | | |
| g | Block(ing) Beam Bench Mark | Prtn PSF PSI | Partition Pounds Per Square Foot Pounds Per Square Inch | -AD DEMOLITION -AF FINISHES | Align Symbol | | | |
| nt | Bearing Brick Basement | Pt Ptd PV | Point Painted Plumbing Vent | F FIRE PROTECTION P PLUMBING | | | | |
| R | Built-up Roofing Door Contact | PVC Pvmt | Polyvinyl Chloride Pavement | M MECHANICAL E ELECTRICAL | $(s) \rightarrow$ Sealant Symbol | | | |
| D | Card Reader Cabinet Caliper | Q QT Qty | Quarry Tile Quantity | T TELECCOMMUNICATION | Dresk Line | | | |
| n | Catch Basin Ceiling Diffuser Cement | R RB RCP | Radius Rubber Base Reflected Ceiling Plan | <u>Category</u> | Break Line | | | |
| M | Cubic Feet Per Minute Corner Guard Cast Iron | RD Re Recpt | Roof Drain Refer Receptacle | 000 General 100 Floor Plans | Project North | | | |
| | Control Joint Ceiling Clear | Ref Reinf Req | Reference Reinforce(d)/(ing) Required | 200 Elevations 300 Sections | True North | | | |
| U | Concrete Masonry Unit Clean Out | Resil Rev Rfg | Resilient Revisions, Revised Roofing | 400 Large Scale Views 500 Details | | | | |
| าท | Column Concrete Connection | RH Rm RO | Right Hand Room Rough Opening | 600 Schedules & Diagrams 700 User Defined (typical Details) | | | | |
| nst nt ntr | Construction Continuous Contract(or) | ROW Rr RTU | Right of Way Restroom Roof Top Unit | 800 User Defined 900 3d Representations | 1 / A101 View Reference | | | |
| | Carpet Ceiling Register Ceramic Tile | RWL RV | Rain Water Leader Roof Vent | <u>Tags</u> | | | | |
| Н | Center Condensing Unit Cabinet Unit Heater | San | South Sanitary Suspended Acoustical Tile | Room name | Revision Tag | | | |
| | Cuspidor Cold Water | SAT SC Sched | Solid Core Schedule | Name | $\langle \zeta \rangle$ | | | |
| | Double Detail Drinking Fountain | SD Sect Serv | Storm Drain Section Service | 101 C1 Room Tag With | Specialty Equipment | | | |
| ו ס | Diameter Dimension Dispenser | SF Sht Sim | Square Feet Sheet Similar | B1 Finishes P1 | Tag Standard | | | |
| Н | Dead Load Drainage Manhole Down | SMH SOV Spec | Sanitary Manhole Spray on Vinyl Specifications | Building Section | (1)(1.2) (2) | | | |
| | Distribution Panel Door Downspout | Sq SS SSTL | Square Solid Surface Stainless Steel | 1 SIM 1 SIM | | | | |
| g | Drawing | Std Stl Stor | Standard Steel Storage | A101 A101 | (A) - + - + + | | | |
| S | Each Epoxy Flooring Exterior Insulation Finish System | Struc Susp Sym | Structural Suspended Symmetrical | Wall Section | (A.5) + | | | |
| | Expansion Joint Elevation Electrical | Syst T ⊤ | System Tread | 1 SIM A101 | | | | |
| | Emergency Enclosure Engineer | T.O. T&G Tel | Top Of Tongue and Groove Telephone | Detail Section | | | | |
| , | Electrical Panel Ethylene Propylene Diene Monomer | Temp Thk Thres | Temperature, Tempered Thick Threshold | 1 SIM | | | | |
| uip C | Equal Equipment Electric Water Cooler | TP TS | Toilet Partition Transition Strip | A101 | (101) Door Tag | | | |
| 'H n st | Electric Water Heater Exhaust Existing | Typ TV | Typical Television | | A Window Tag | | | |
|) | Exterior | U UG UH UNO | Underground Unit Heater Unless Noted Otherwise | SIM | ESF | | | |
| CP | Fire Alarm Fire Alarm Control Panel Floor Drain | Unfin UV | Unfinished Ultra Violet | | Storefront / Curtain Wall Tag | | | |
| ı C | Foundation Fire Extinguisher Fire Extinguisher Cabinet | V VCT Vert Vent | Vinyl Composition Tile Vertical Ventilator | | Type Number | | | |
| | Finished Floor Finished Grade Fire Hose Cabinet | VIF VWC | Verify in Field Vinyl Wall Covering | | Curtain Panel Wall Tag | | | |
| | | W w w/ w/o | west with without | Name Elevation Tag | Fire Rating Wall Construction Stud Size | | | |
| sh g) or | Flashing Floor(ing) Fluorescent | wc wd wh | water Closet wood water Heater | Elevation | Specialty Construction | | | |
| | Face Of Fireproof Fire Proof | wp wpt wr | waterproof work Point water Resistant | • 4-0 Spot Elevation | 1G3A Wall/Partition Tag | | | |
| | Fiber Reinforced Panel Floor Sink Foot, Feet | wsct wt wv | wainscot weight water Valve | | | | | |
| n | Footing Furnish(ed) | wwf | welded Wire Fabric | 1 <u>View Name</u> 1/8" = 1'-0" | GYP 1'-0" Ceiling Tag With Height | | | |
| С | Furring Fabric Wall Covering | Y yd | yalu | View Title | Type Name Ceiling Height | | | |
| V | Gauge, Gage Galvanized General Contractor | | | - | 20 R @ 7 1/2" Stair Tag | | | |
|) | Ground Fault Interrupter Gypsum | | | Interior Elevation Mark | | | | |
| vd | Hose Bibb Hollow Core Hardwood | | | ~ r . | 1iSpecialty EquipmentTag Boxed | | | |
| vr) | Hardware Height High Intensity Discharge | | | | 1i Case Work Tag Boxed | | | |
| iz | Hollow Metal High Point Horizontal | | | - A202 - Exterior Elevation Mark | 1i Case Work Tag Boxed | | | |
| AC | Heat, Vent, A/C Hot Water | | | | | | | |
| and | Inside Diameter Inch Incandescent | | | Material Cut Patterns | | | | |
| | Include(d)/(ing) Insulat(ed)/(ion) Interior | | | | | | | |
| | Junction Box | | | Concrete | | | | |
| | Joint | | | Earth Compacted | | | | |
| | Kip (1,000 Pounds) Kip Feet | | | Earth Undisturbed | | | | |
| s) | Laminated Lavatory Pound(s) | | | Gravel | | | | |
| ر | Lead Coated Copper Linear Feet Left Hand | | | Gypsum Wall Board | | | | |
| H / | Live Load Long Leg Horizontal Long Leg Vertical | | | | | | | |
| J) t | Low Point Light(ing) Lightweight | | | | | | | |
| x | Masonry Maximum | | | Masonry-brick | | | | |
| P ch d | Main Distribution Panel Mechanical Medium | | | Masonry-conc Block | | | | |
| | Membrane Metal Manufacturer | | | Masonry-stone | | | | |
| | Manhole Minimum Miscellaneous | | | Metal- Steel | | | | |
| - | Masonry Opening Mounted | | | Wood-finish | | | | |
| | North Not In Contract Number | | | | | | | |
| n S | Nominal Not to Scale | | | Veneer Core Plywood | | | | |
| | | | | | | | | |

| Sheet | Sheat Nama | 10/09/15 Demo & Enabling | 11/04/15 DD Set |
|----------------------------|---|--------------------------|-----------------|
| 1) General | Sheet Name | 5 | Ŧ |
| G-000 G-001 | Cover Drawing List, Symbols, and Abbreviations | | • |
| G-003 2) Civil | Overall Plan | | • |
| C-0.0 C-1.0 | Notes, Abbreviations, And Legend Area Wide Plan And Key Plan | | • |
| C-2.0 C-2.1 | Layout And Materials Plan Layout And Materials Plan | | • |
| C-2.2 C-2.3 | Layout And Materials Plan Layout And Materials Plan | | • |
| C-2.4 C-2.5 | Fire Access Plan Soil Test Pit Data (Form 11) | | • |
| C-2.6 C-3.0 | Soil Test Pit Data (Form 11) Grading And Utility Plan | | • |
| C-3.1 C-3.2 | Grading And Utility Plan Grading And Utility Plan | | • |
| C-3.3 C-3.4 | Grading And Utility Plan Average Grade Plane Plan | | • |
| C-4.0 C-5.0 | Erosion And Sedimentation Control Plan Erosion And Sedimentation Control Details | | • |
| C-5.1 C-5.2 | Erosion And Sedimentation Control Details Civil Construction Details 1 | | • |
| C-5.3 C-5.4 | Civil Construction Details 2 Civil Construction Details 3 | | • |
| C-5.5 C-5.6 | Civil Construction Details 4 Civil Construction Details 5 | | • |
| C-6.1 EX-1.1 | Site Cross-Sections Existing Conditions Plan | | • |
| EX-1.2 EX-1.3 | Existing Conditions Plan Existing Conditions Plan | | • |
| EX-1.4 EX-1.5 | Existing Conditions Plan Existing Conditions Plan | | • |
| 3) Landscaping L-0.0 | Tree Removal Plan 1 | | • |
| L-0.1 L-0.2 | Tree Removal Plan 2 Tree Removal Plan 3 | | • |
| L-0.3 L-1.0 | Tree Removal Plan 4 Planting Plan 1 | | • |
| L-1.1 L-1.2 | Planting Plan 2 Planting Plan 3 | | • |
| L-1.3 L-1.4 | Planting Plan 4 Plant Schedule And Details | | • |
| L-2.0 L-2.1 | Lighting Plan 1 Lighting Plan 2 | | • |
| L-2.2 L-2.3 | Lighting Plan 3 Lighting Plan 4 | | • |
| 4) Demolition & DE-A-01 | Demolition Plan | • | |
| DE-A-02 DE-A-03 | Construction Plan Construction RCP | • | |
| DE-A-04 5) Architecture | Wall Sections | • | |
| A-101a A-101b | First Floor Construction Partial Plan - Wing A First Floor Construction Partial Plan - Wing B | | • |
| A-101c A-102a | First Floor Construction Partial Plan - Wing C Second Floor Construction Partial Plan - Wing A | | • |
| A-102b A-103a | Second Floor Construction Partial Plan - Wing B Third Floor Construction Partial Plan - Wing A | | • |
| A-103b A-104a | Third Floor Construction Partial Plan - Wing B Roof Construction Partial Plan - Wing A | | • |
| A-104b A-106 | Roof Construction Partial Plan - Wing B Typical Roof Details | | • |
| A-107 A-111b | Soffit Plans First Floor Finish Plans & Schedule First Floor Finish Plans & Schedule | | • |
| A-111c A-112b A-113b | Second Floor Finish Plans & Schedule Third Floor Finish Plans & Schedule | | |
| A-1130 A-121 A-122 | First Floor Reflected Ceiling Plans & Details Second Floor Reflected Ceiling Plans & Details | | • |
| A-122 A-123 A-131a | Third Floor Reflected Ceiling Plans & Details First Floor Edge of Foundation Wall Plan Wing A | | • |
| A-131b A-132a | First Floor Edge of Foundation Wall Plan Wing B Second Floor Edge of Foundation Wall Plan Wing A | | |
| A-132a A-132b A-133a | Second Floor Edge of Foundation Wall Plan Wing A Second Floor Edge of Foundation Wall Plan Wing B Third Floor Edge of Foundation Wall Plan Wing A | | |
| A-133b A-201 | Third Floor Edge of Foundation Wall Plan Wing A Third Floor Edge of Foundation Wall Plan Wing B North & South Exterior Elevations | | • |
| A-201 A-202 A-203 | East Exterior Elevations West Exterior Elevations | | • |
| A-301 A-302 | Building Sections Building Sections | | |
| A-405 A-420 | Toilet Plan, Elevations, & Schedule Elevator Plans, Section, & Details | | • |
| A-501 A-502 | Foundation Section Details Section Details | | • |
| A-504 6) Structural | Roof Edge Section Details | | • |
| DE-S-01 DE-S-02 | DEMOLITION FOUNDATION PLAN DEMOLITION ROOF PLAN | • | |
| DE-S-03 S0-000 | DEMOLITION SECTIONS & DETAILS Cover Sheet & Drawing List | • | • |
| S0-001 S0-002 | General Notes I General Notes II | | • |
| S1-101a S1-101b | First Floor Foundation Plan-A First Floor Foundation Plan-B | | • |
| S1-101c S1-102a | First Floor Foundation Plan-C Second Floor Framing Plan-A | | • |
| S1-102b S1-103a | Second Floor Framing Plan-B Third Floor Framing Plan-A | | • |
| S1-103b S1-104a | Third Floor Framing Plan-B Roof Framing Plan-A | | • |
| S1-104b S1-501 | Roof Framing Plan-B Corridor Sections | | • |
| S2-103 S2-105 | Typical Footing Details Typical Slab On Grade Details | | • |
| S2-106 S2-108 | Typical Slab On Grade Details Typical Foundation Wall Details | | • |
| S3-001 S3-100 | Reference Braced Frame Elevations And Notes Typical Braced Frame Connection Details | | • |
| S5-001 S5-100 | Steel Column Schedule Typical Steel Column Details | | • |
| S5-101 S5-200 | Typical Steel Column Details Typical Steel Beam Details | | • |
| S5-201 S5-202 | Typical Steel Beam Details Typical Steel Beam Details | | • |
| S5-300 S5-301 | Typical Composite Steel Deck Details Typical Composite Steel Deck Details | | • |
| S5-302 | Typical Composite Steel Deck Details | | • |


| Sheet Number | Sheet Name | 10/09/15 Demo & Enabling | 11/04/15 DD Set |
|-------------------------|--|--------------------------|-----------------|
| | FIRE PROTECTION LEGEND | | - |
| DE-F-01 DE-F-11 | FIRE PROTECTION LEVEL 1 DEMO | • | |
| DE-F-21 DE-F-31 | FIRE PROTECTION LEVEL 1 PLAN FIRE PROTECTIO DETAILS | • | |
| F-001 | Fire Protection Legend | | • |
| F-101a F-101b | Fire Protection First Floor Plan - Wing A Fire Protection First Floor Plan - Wing B | | • |
| F-101c | Fire Protection First Floor Plan - Wing C | | • |
| F-102a F-102b | Fire Protection Second Floor Plan - Wing A Fire Protection Second Floor Plan - Wing B | | • |
| F-103a F-103b | Fire Protection Third Floor Plan - Wing A Fire Protection Third Floor Plan - Wing B | | • |
| F-1035 F-104a | Fire Protection Roof Plan - Wing A | | • |
| F-104b F-200 | Fire Protection Roof - Wing B Fire Protection Riser | | • |
| F-300 | Fire Protection Details | | • |
| 8) Plumbing DE-P-01 | PLUMBING LEGEND | • | |
| DE-P-11 | PLUMBING LEVEL 1 DEMO PLAN | • | |
| DE-P-21 DE-P-31 | PLUMBING LEVEL 1 PLAN PLUMBING DETAILS | • | |
| DE-P-41 P-001 | PLUMBING SCHEDULES Plumbing Legend | • | • |
| P-101a | Plumbing First Floor Plan - Wing A | | • |
| P-101b P-101c | Plumbing First Floor Plan - Wing B Plumbing First Floor Plan - Wing C | | • |
| P-102a | Plumbing Second Floor Plan - Wing A | | • |
| P-102b P-103a | Plumbing Second Floor Plan - Wing B Plumbing Third Floor Plan - Wing A | | • |
| P-103b P-104a | Plumbing Third Floor Plan - Wing B Plumbing Roof Plan - Wing A | | • |
| P-104b | Plumbing Roof Plan - Wing B | | • |
| P-200 P-201 | Plumbing Water, San & Vent Riser Diagrams Plumbing Storm Riser Diagram & Schedules | | • |
| 9) Mechanical | | | - |
| DE-M-01 DE-M-02 | MECHANICAL LEGEND & ABBREVIATIONS MECHANICAL SPECIFICATIONS | • | |
| DE-M-11 DE-M-12 | MECHANICAL DEMOLITION - LEVEL 1 MECHANICAL DEMOLITION - ROOF | • | |
| DE-M-12 DE-M-21 | MECHANICAL DEMOLITION - ROOP MECHANICAL NEW WORK PLAN - LEVEL 1 | • | |
| DE-M-22 DE-M-31 | MECHANICAL NEW WORK PLAN - ROOF MECHANICAL DETAILS 1 | • | |
| DE-M-32 | MECHANICAL DETAILS 2 | • | |
| DE-M-41 DE-M-51 | MECHANICAL SCHEDULES MECHANICA CONTROL LEGEND 1 | • | |
| DE-M-52 | MECHANICAL CONTROL LEGEND 2 MECHANICAL GENERAL CONTROLS | • | |
| DE-M-53 DE-M-54 | HOT WATER PLANT CONTROLS | • | |
| M-001 M-002 | Mechanical Legend And Abbreviations Mechanical Schedules | | • |
| M-101A | Mechanical 1st Floor Plan - Wing A | | • |
| M-101B M-101C | Mechanical 1st Floor Plan - Wing B Mechanical 1st Floor Plan - Wing c | | • |
| M-102A M-102B | Mechanical 2nd Floor Plan | | • |
| M-103A | Mechanical 2nd Floor Plan - Wing B Mechanical 3rd Floor Plan - Wing A | | • |
| M-103B M-104A | Mechanical 3rd Floor Plan - Wing B Mechanical Roof Plan - Wing A | | • |
| M-104B | Mechanical Roof Plan - Wing B | | • |
| M-200 M-201 | Mechanical Details 1 Mechanical Details 2 | | • |
| M-300 M-301 | Mechanical Controls Legend Mechanical Controls RTU-1 & RTU-2 | | • |
| M-302 | Mechanical Controls RTU-3 | | • |
| M-303 10) Electrical | Mechanical General Controls | | • |
| DE-E-01 | ELECTRICAL LEGEND & ABBREVIATIONS | • | |
| DE-E-02 DE-E-03 | ELECTRICAL NOTES ELECTRICAL SPECIFICATIONS | • | |
| DE-E-04 DE-E-10 | ELECTRICAL SPECIFICATIONS ELECTRICAL EXISTING LEVEL 1 | • | |
| DE-E-20 | ELECTRICAL LEVEL 1 POWER & LIGHTING | • | |
| DE-E-21 DE-E-22 | ELECTRICAL ROOF POWER AND LIGHTING ELECTRICAL LEVEL 1 FIRE ALARM | • | |
| DE-E-40 E-001 | ELECTRICAL SCHEDULES & DETAILS Electrical Legend And Notes | • | • |
| E-002 | Electrical Notes | | • |
| E-003 E-101a | Electrical Site Plan Electrical Level 1 Power Plan - A | | • |
| E-101b | Electrical Level 1 Power Plan - B | | • |
| E-101c E-102a | Electrical Level 1 Power Plan - C Electrical Level 2 Power Plan - A | | • |
| E-102b E-103a | Electrical Level 2 Power Plan - B Electrical Level 3 Power Plan - A | | • |
| E-103b | Electrical Level 3 Power Plan - B | | • |
| E-104a E-104b | Electrical Roof Power Plan - A Electrical Roof Power Plan - B | | • |
| E-105 | Electrical Roof Power Plan | | • |
| E-201a E-201b | Electrical Level 1 Lighting Plan - A Electrical Level 1 Lighting Plan - B | | • |
| E-201c E-202a | Electrical Level 1 Lighting Plan - C Electrical Level 2 Lighting Plan - A | | • |
| E-202b | Electrical Level 2 Lighting Plan - B | | • |
| E-203a E-203b | Electrical Level 3 Lighting Plan - A Electrical Level 3 Lighting Plan - B | | • |
| E-301a | Electrical Level 1 Fire Alarm Plan - A | | • |
| E-301b E-301c | Electrical Level 1 Fire Alarm Plan - B Electrical Level 1 Fire Alarm Plan - C | | • |
| E-302a E-302b | Electrical Level 2 Fire Alarm Plan - A Electrical Level 2 Fire Alarm Plan - B | | • |
| E-303a | Electrical Level 3 Fire Alarm Plan - A | | • |
| E-303b | Electrical Level 3 Fire Alarm Plan - B | 1 | • |



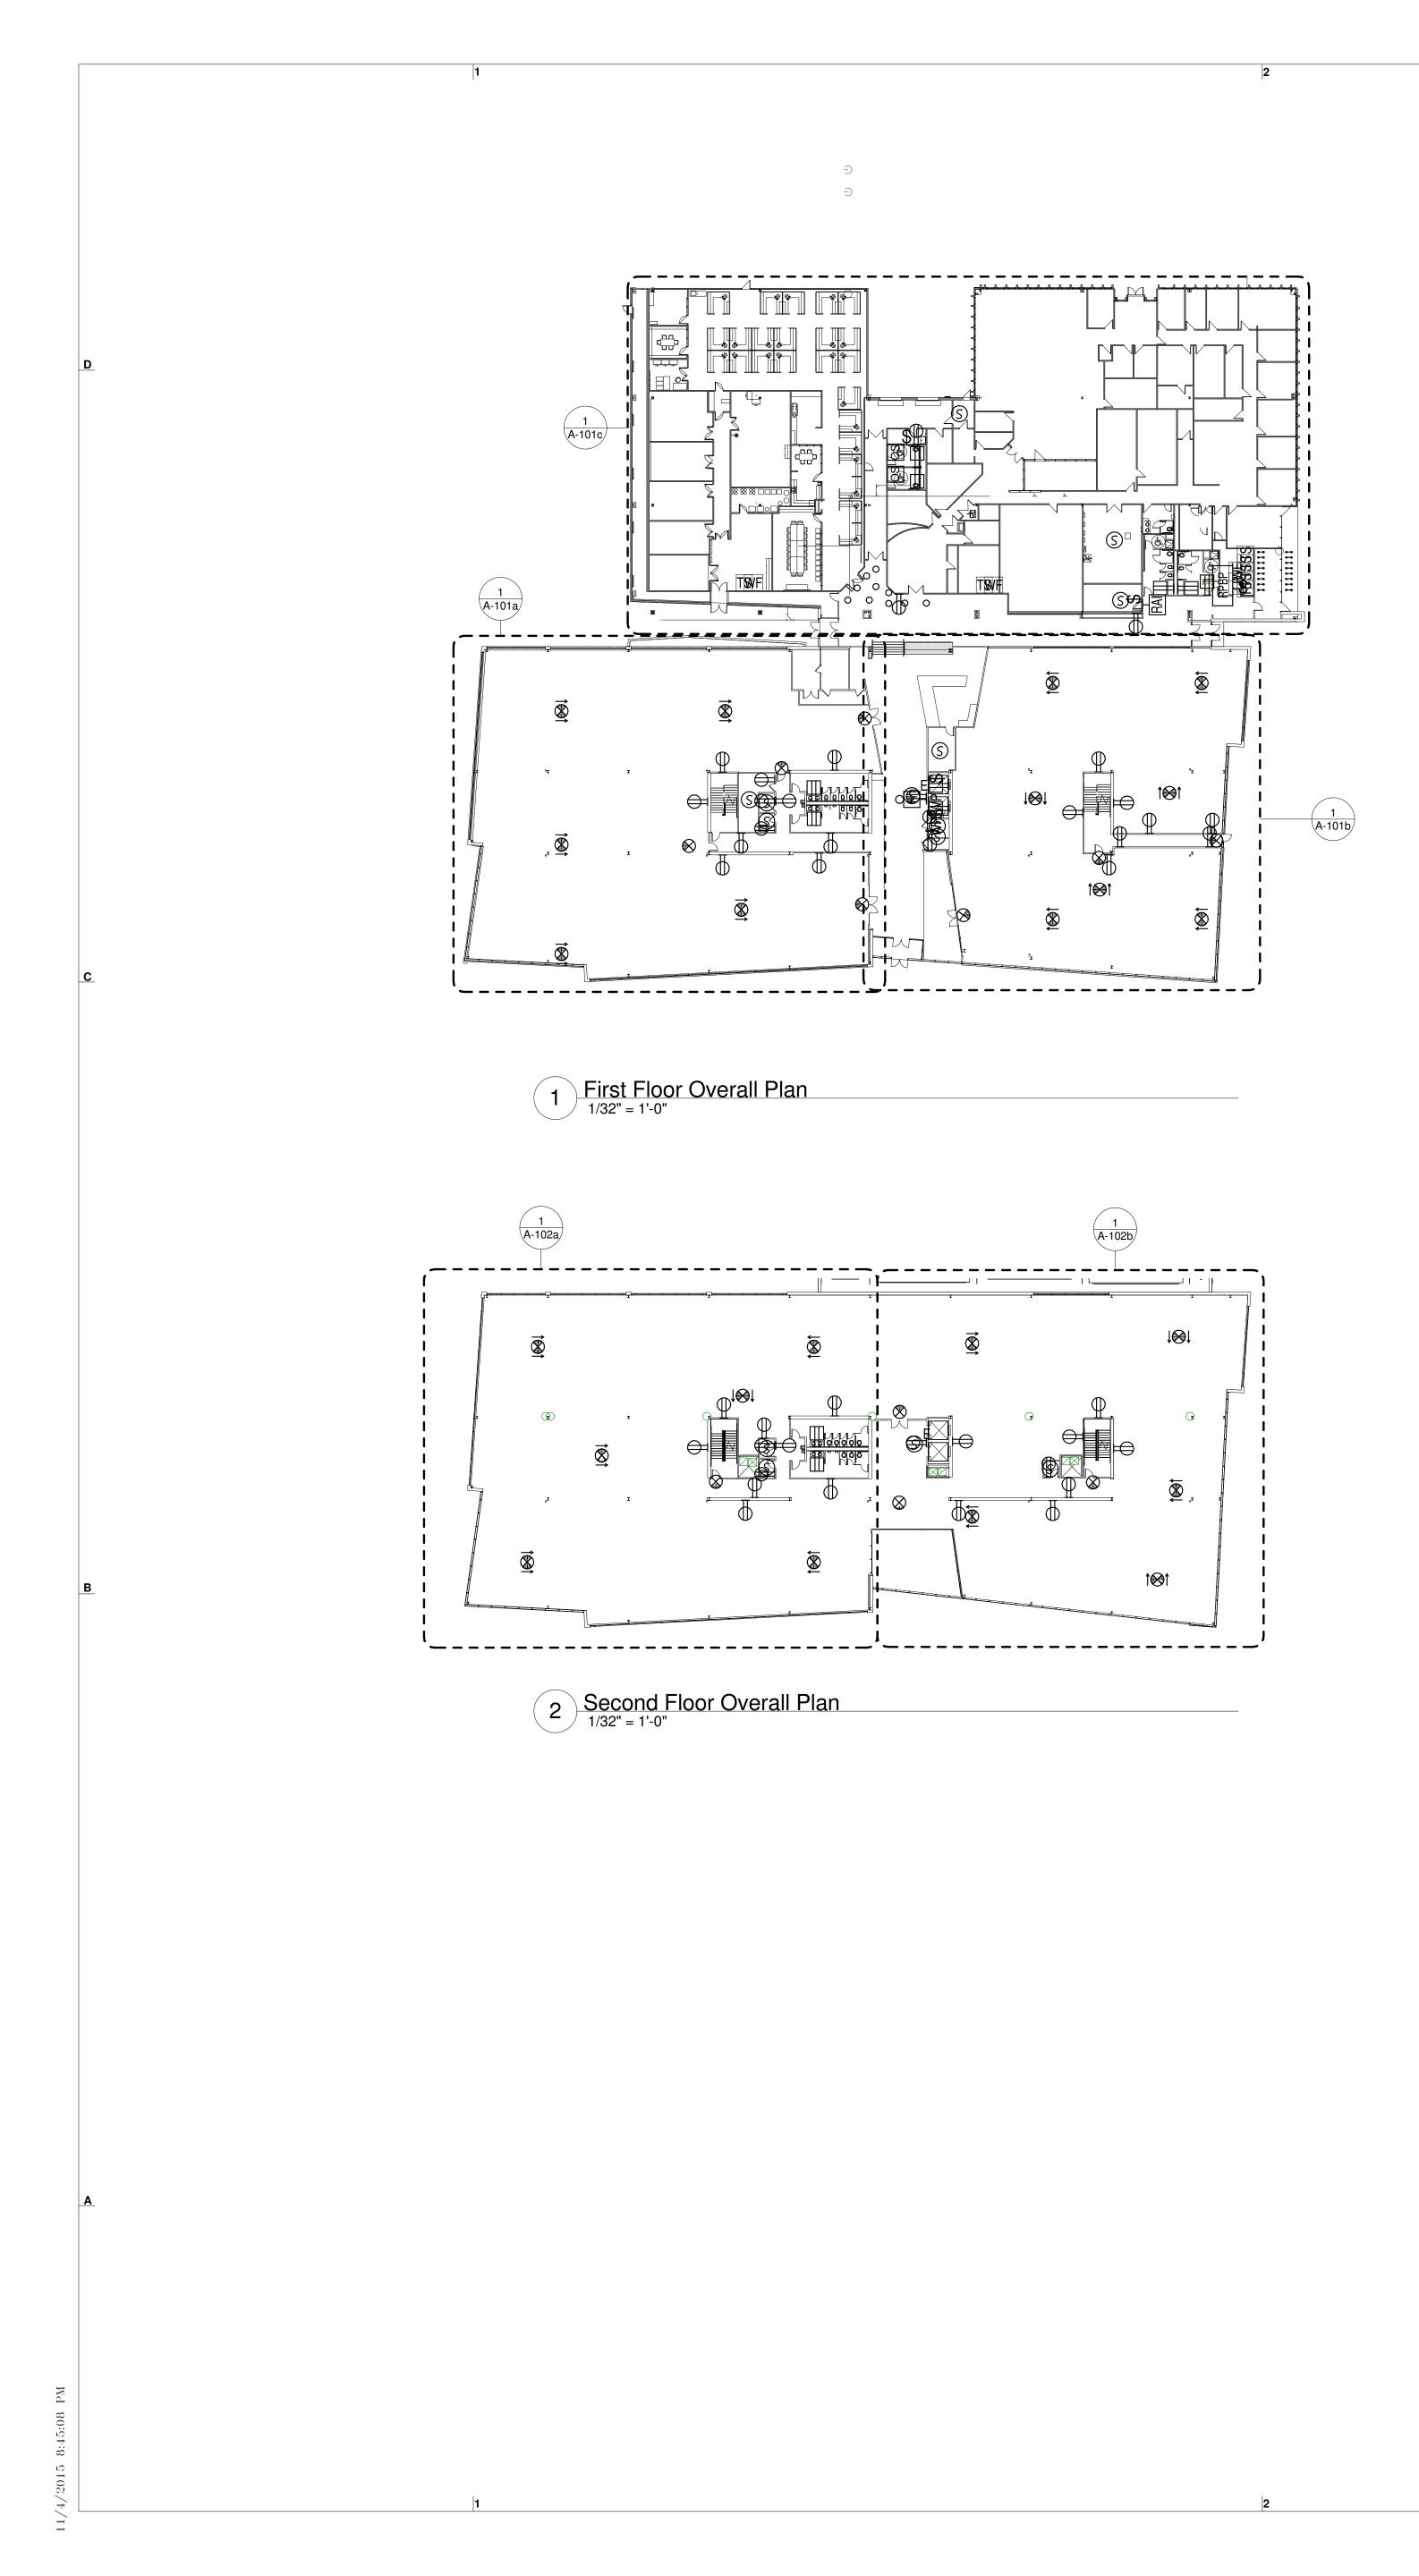

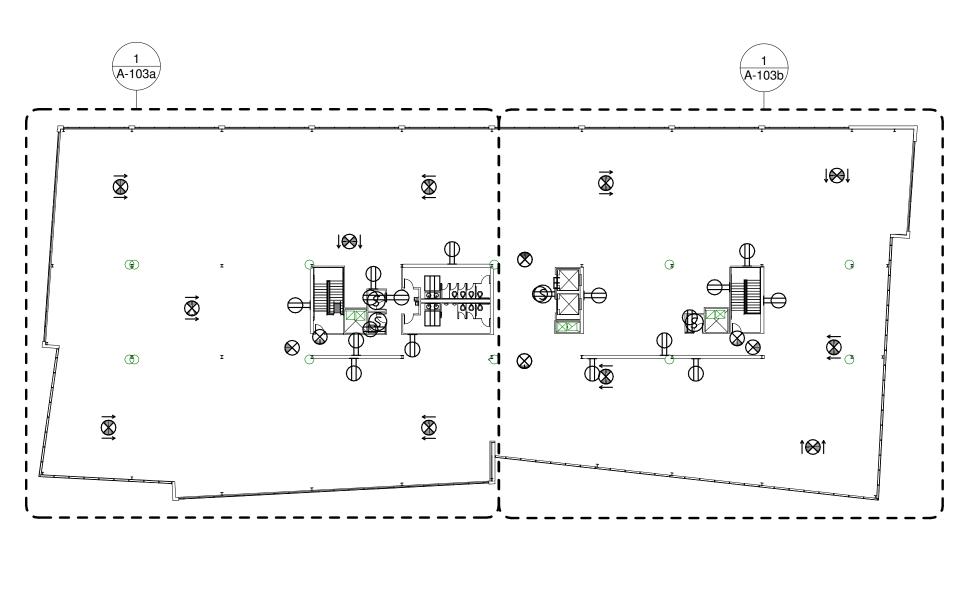





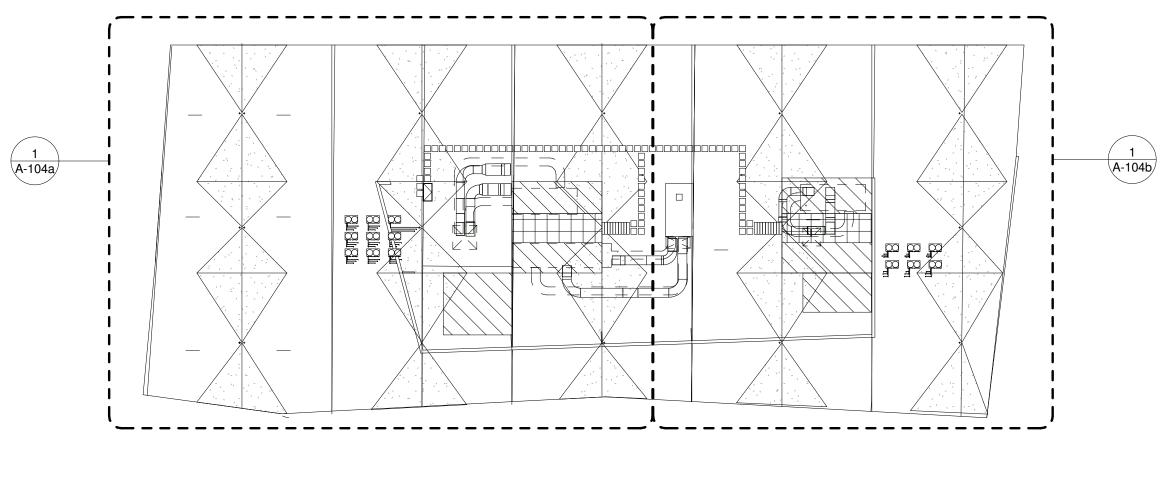

4 Roof Plan Overall Plan 1/32" = 1'-0"




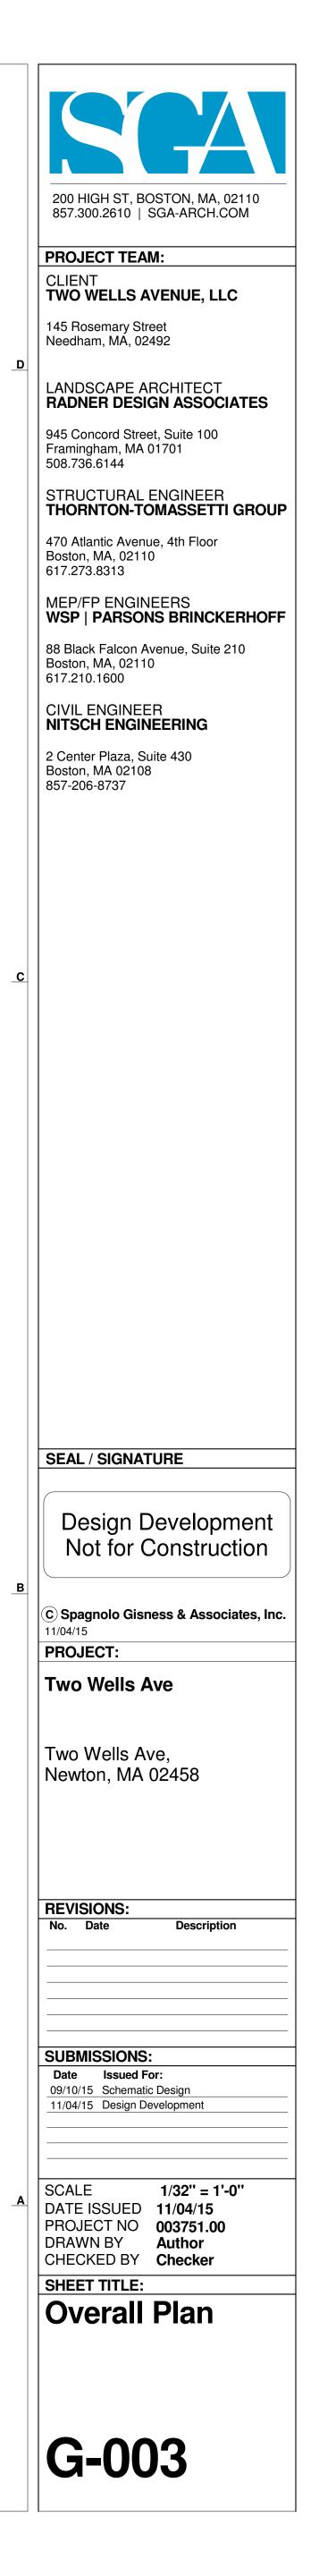


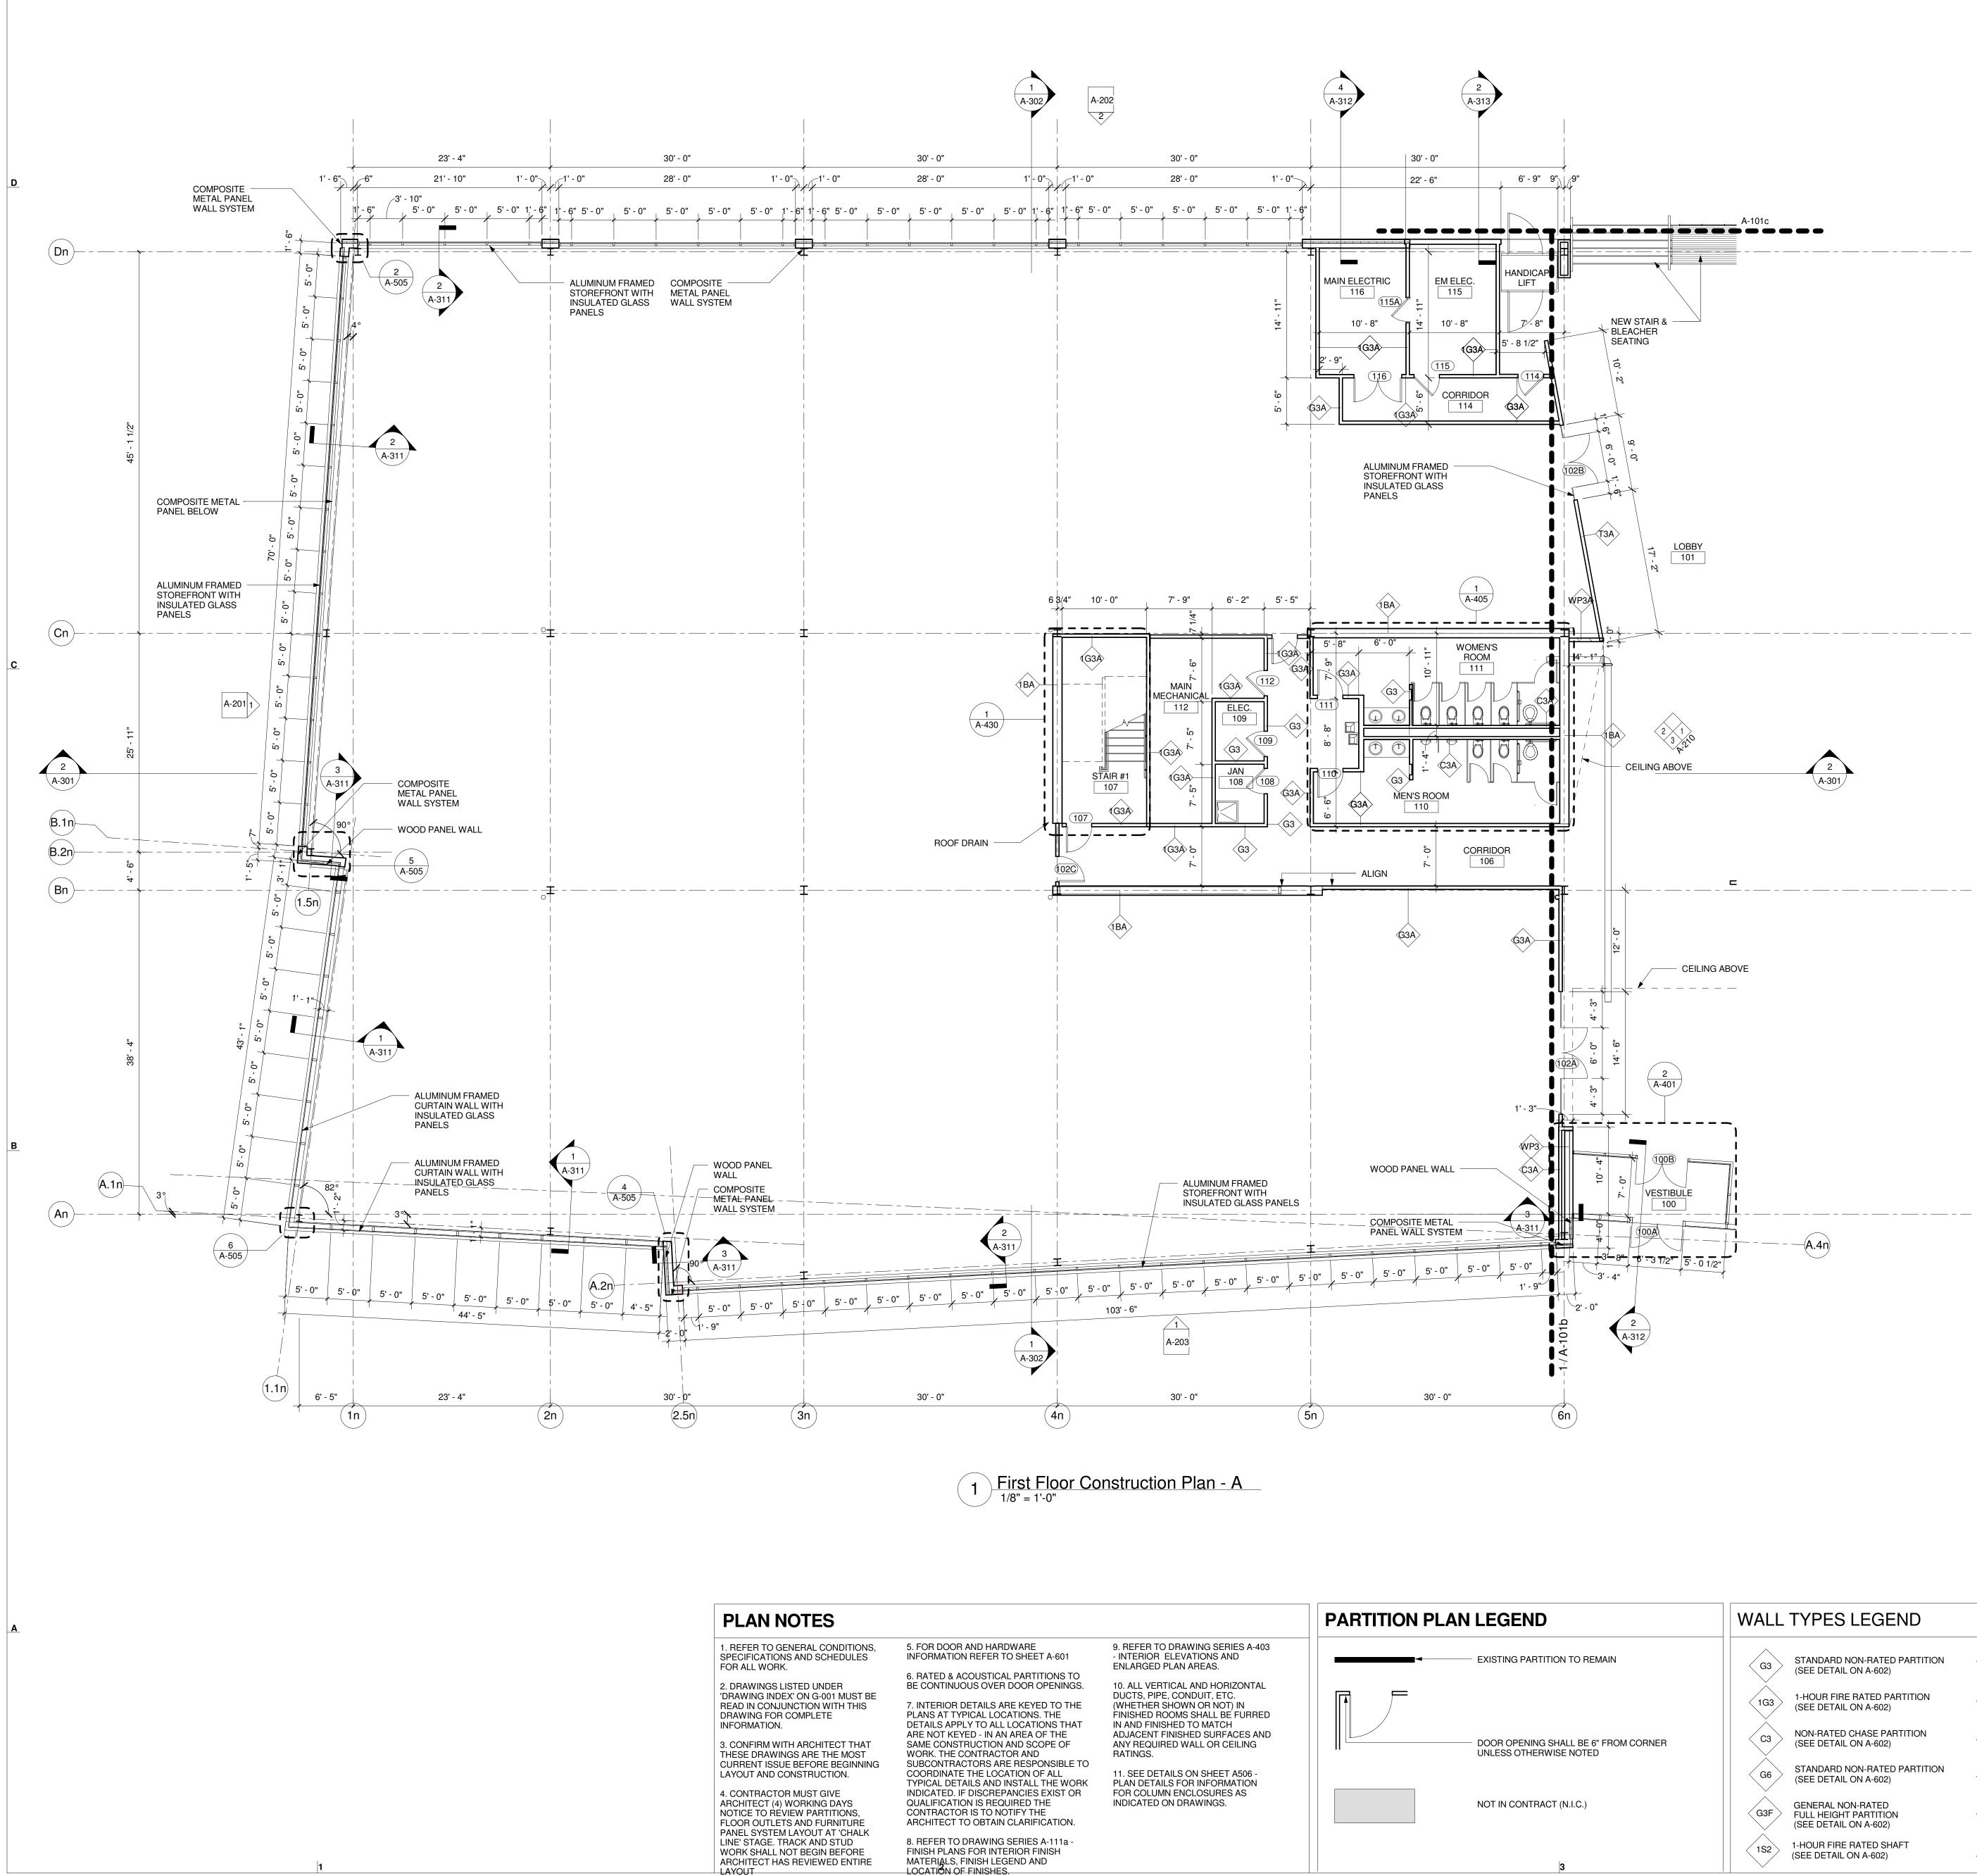

| ARIIION PLAN LEGEND | | | | | | | |
|---------------------|--|--|--|--|--|--|--|
| < | - EXISTING PARTITION TO REM | | | | | | |
| | - DOOR OPENING SHALL BE 6" UNLESS OTHERWISE NOTED | | | | | | |


| | WALL TYPES LEGEND | |
|-----------|--|---------------------------|
| N | G3 STANDARD NON-RATED PARTITION (SEE DETAIL ON A-602) G3A ACOUSTIC NON-RATED PARTITION (SEE DETAIL ON A-602) | C |
| | 1G3 1-HOUR FIRE RATED PARTITION (SEE DETAIL ON A-602) 1-HOUR FIRE RATED ACOUSTIC PARTITION (SEE DETAIL ON A-602) (SEE DETAIL ON A-602) | |
| OM CORNER | C3 NON-RATED CHASE PARTITION (SEE DETAIL ON A-602) C3A ACOUSTIC NON-RATED CHASE WALL (SEE DETAIL ON A-602) | |
| | G6 STANDARD NON-RATED PARTITION (SEE DETAIL ON A-602) G6A ACOUSTIC NON-RATED PARTITION (SEE DETAIL ON A-602) G6A (SEE DETAIL ON A-602) | |
| | G3F GENERAL NON-RATED FULL HEIGHT PARTITION (SEE DETAIL ON A-602) 1-HOUR FIRE RATED BRACE BEAM SHAFT ENCLOSURE PARTITION (SEE DETAIL ON A-602) | |
| | 1S2 1-HOUR FIRE RATED SHAFT (SEE DETAIL ON A-602) 1-HOUR FIRE RATED ACOUSTICAL BRACE BEAM ENCLOSURE PARTITION (SEE DETAIL ON A-602) 4 | 0 4 8 12 16 24 32 48 (ft) |

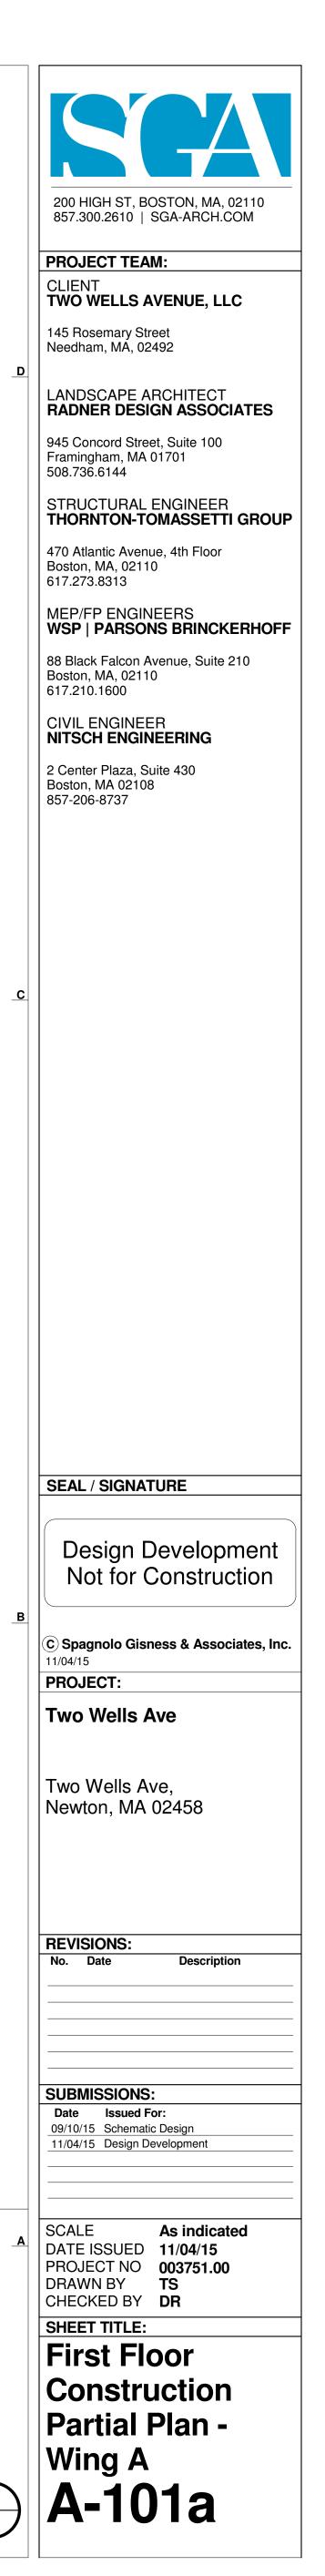


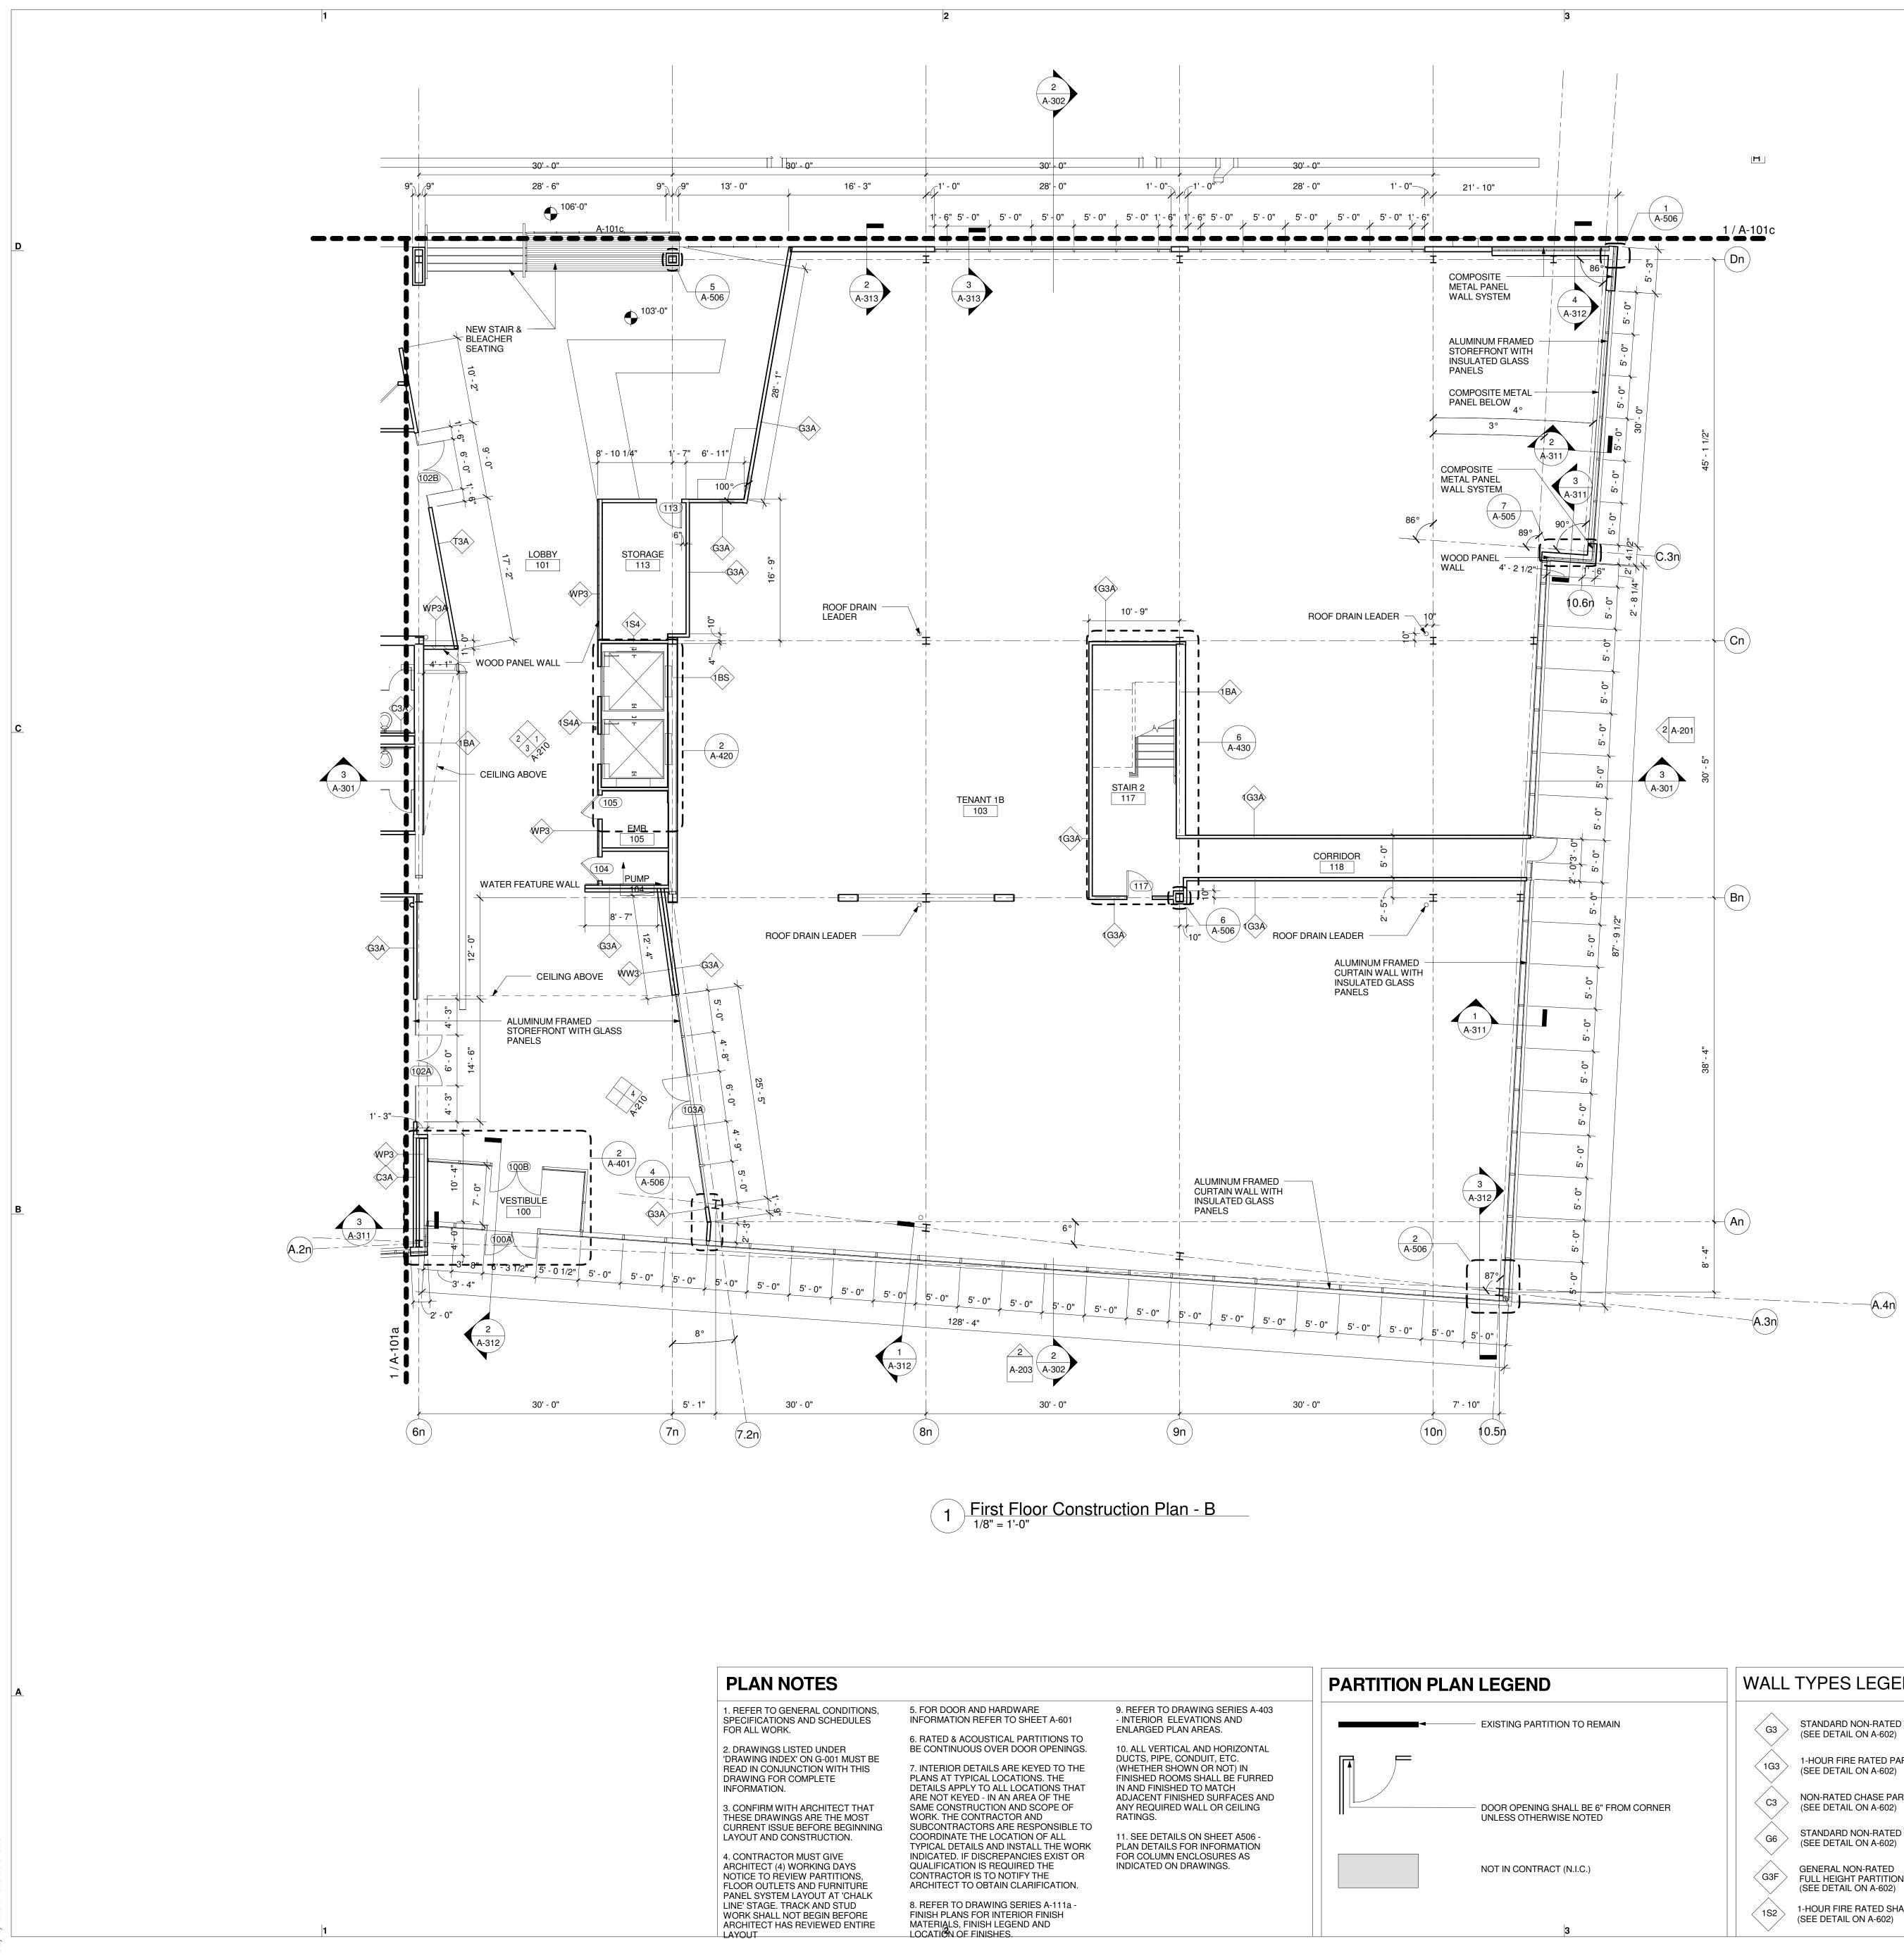



| N NOTES | | PARTITION PLAN LEGEND | | | | | |
|---|--|--|--|----------------------------|--|--|--|
| TO GENERAL CONDITIONS, ATIONS AND SCHEDULES WORK. NGS LISTED UNDER A INDEX' ON G-001 MUST BE CONJUNCTION WITH THIS FOR COMPLETE TION. MWITH ARCHITECT THAT RAWINGS ARE THE MOST ISSUE BEFORE BEGINNING AND CONSTRUCTION. ACTOR MUST GIVE CT (4) WORKING DAYS O REVIEW PARTITIONS, UTLETS AND FURNITURE STEM LAYOUT AT 'CHALK GE. TRACK AND STUD IALL NOT BEGIN BEFORE | 5. FOR DOOR AND HARDWARE INFORMATION REFER TO SHEET A-601 6. RATED & ACOUSTICAL PARTITIONS TO BE CONTINUOUS OVER DOOR OPENINGS. 7. INTERIOR DETAILS ARE KEYED TO THE PLANS AT TYPICAL LOCATIONS. THE DETAILS APPLY TO ALL LOCATIONS THAT ARE NOT KEYED - IN AN AREA OF THE SAME CONSTRUCTION AND SCOPE OF WORK. THE CONTRACTOR AND SUBCONTRACTORS ARE RESPONSIBLE TO COORDINATE THE LOCATION OF ALL TYPICAL DETAILS AND INSTALL THE WORK INDICATED. IF DISCREPANCIES EXIST OR QUALIFICATION IS REQUIRED THE CONTRACTOR IS TO NOTIFY THE ARCHITECT TO OBTAIN CLARIFICATION. 8. REFER TO DRAWING SERIES A-111a - FINISH PLANS FOR INTERIOR FINISH | 9. REFER TO DRAWING SERIES A-403 - INTERIOR ELEVATIONS AND ENLARGED PLAN AREAS. 10. ALL VERTICAL AND HORIZONTAL DUCTS, PIPE, CONDUIT, ETC. (WHETHER SHOWN OR NOT) IN FINISHED ROOMS SHALL BE FURRED IN AND FINISHED TO MATCH ADJACENT FINISHED SURFACES AND ANY REQUIRED WALL OR CEILING RATINGS. 11. SEE DETAILS ON SHEET A506 - PLAN DETAILS FOR INFORMATION FOR COLUMN ENCLOSURES AS INDICATED ON DRAWINGS. | | EXISTING PARTITION TO REMA | | | |
| CT HAS REVIEWED ENTIRE | MATERIALS, FINISH LEGEND AND LOCATION OF FINISHES. | | | 3 | | | |


| WALL TYPES LEGEND | | | | | | | | | | |
|---|------|---|----|-----|------|----|----|---|---------|---|
| G3 STANDARD NON-RATED PARTITION (SEE DETAIL ON A-602) | G3A | ACOUSTIC NON-RATED PARTITION (SEE DETAIL ON A-602) | | | | | С | | | |
| 1G3 1-HOUR FIRE RATED PARTITION (SEE DETAIL ON A-602) | 1G3A | 1-HOUR FIRE RATED ACOUSTIC PARTITION (SEE DETAIL ON A-602) | | | | | | | | |
| C3 NON-RATED CHASE PARTITION (SEE DETAIL ON A-602) | C3A | ACOUSTIC NON-RATED CHASE WALL (SEE DETAIL ON A-602) | | | A | | | В | ſ | |
| G6 STANDARD NON-RATED PARTITION (SEE DETAIL ON A-602) | G6A | ACOUSTIC NON-RATED PARTITION (SEE DETAIL ON A-602) | |] | | | | | | |
| G3F GENERAL NON-RATED FULL HEIGHT PARTITION (SEE DETAIL ON A-602) | 1BSA | 1-HOUR FIRE RATED BRACE BEAM SHAFT ENCLOSURE PARTITION (SEE DETAIL ON A-602) | | | | | | | . 1 | ſ |
| 1S2 1-HOUR FIRE RATED SHAFT (SEE DETAIL ON A-602) | 1BA | 1-HOUR FIRE RATED ACOUSTICAL BRACE BEAM ENCLOSURE PARTITION (SEE DETAIL ON A-602) 4 | 04 | 8 1 | 2 16 | 24 | 32 | 2 | 48 (ft) | |

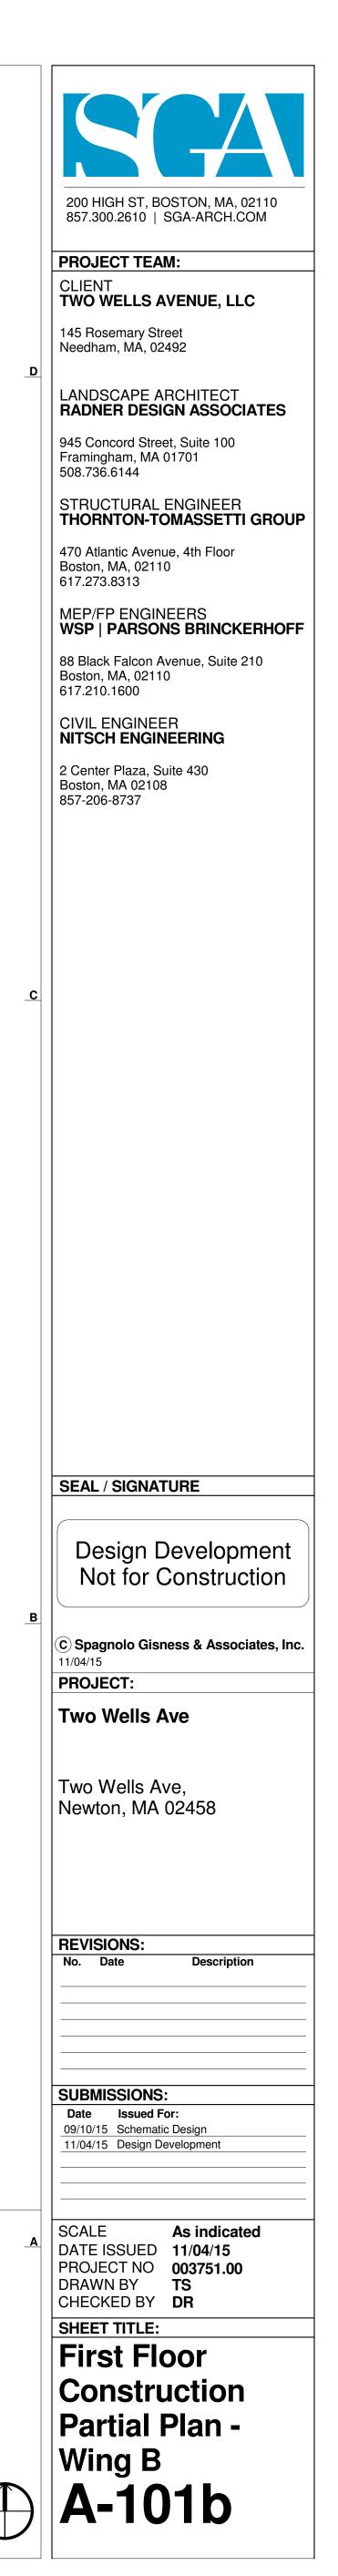


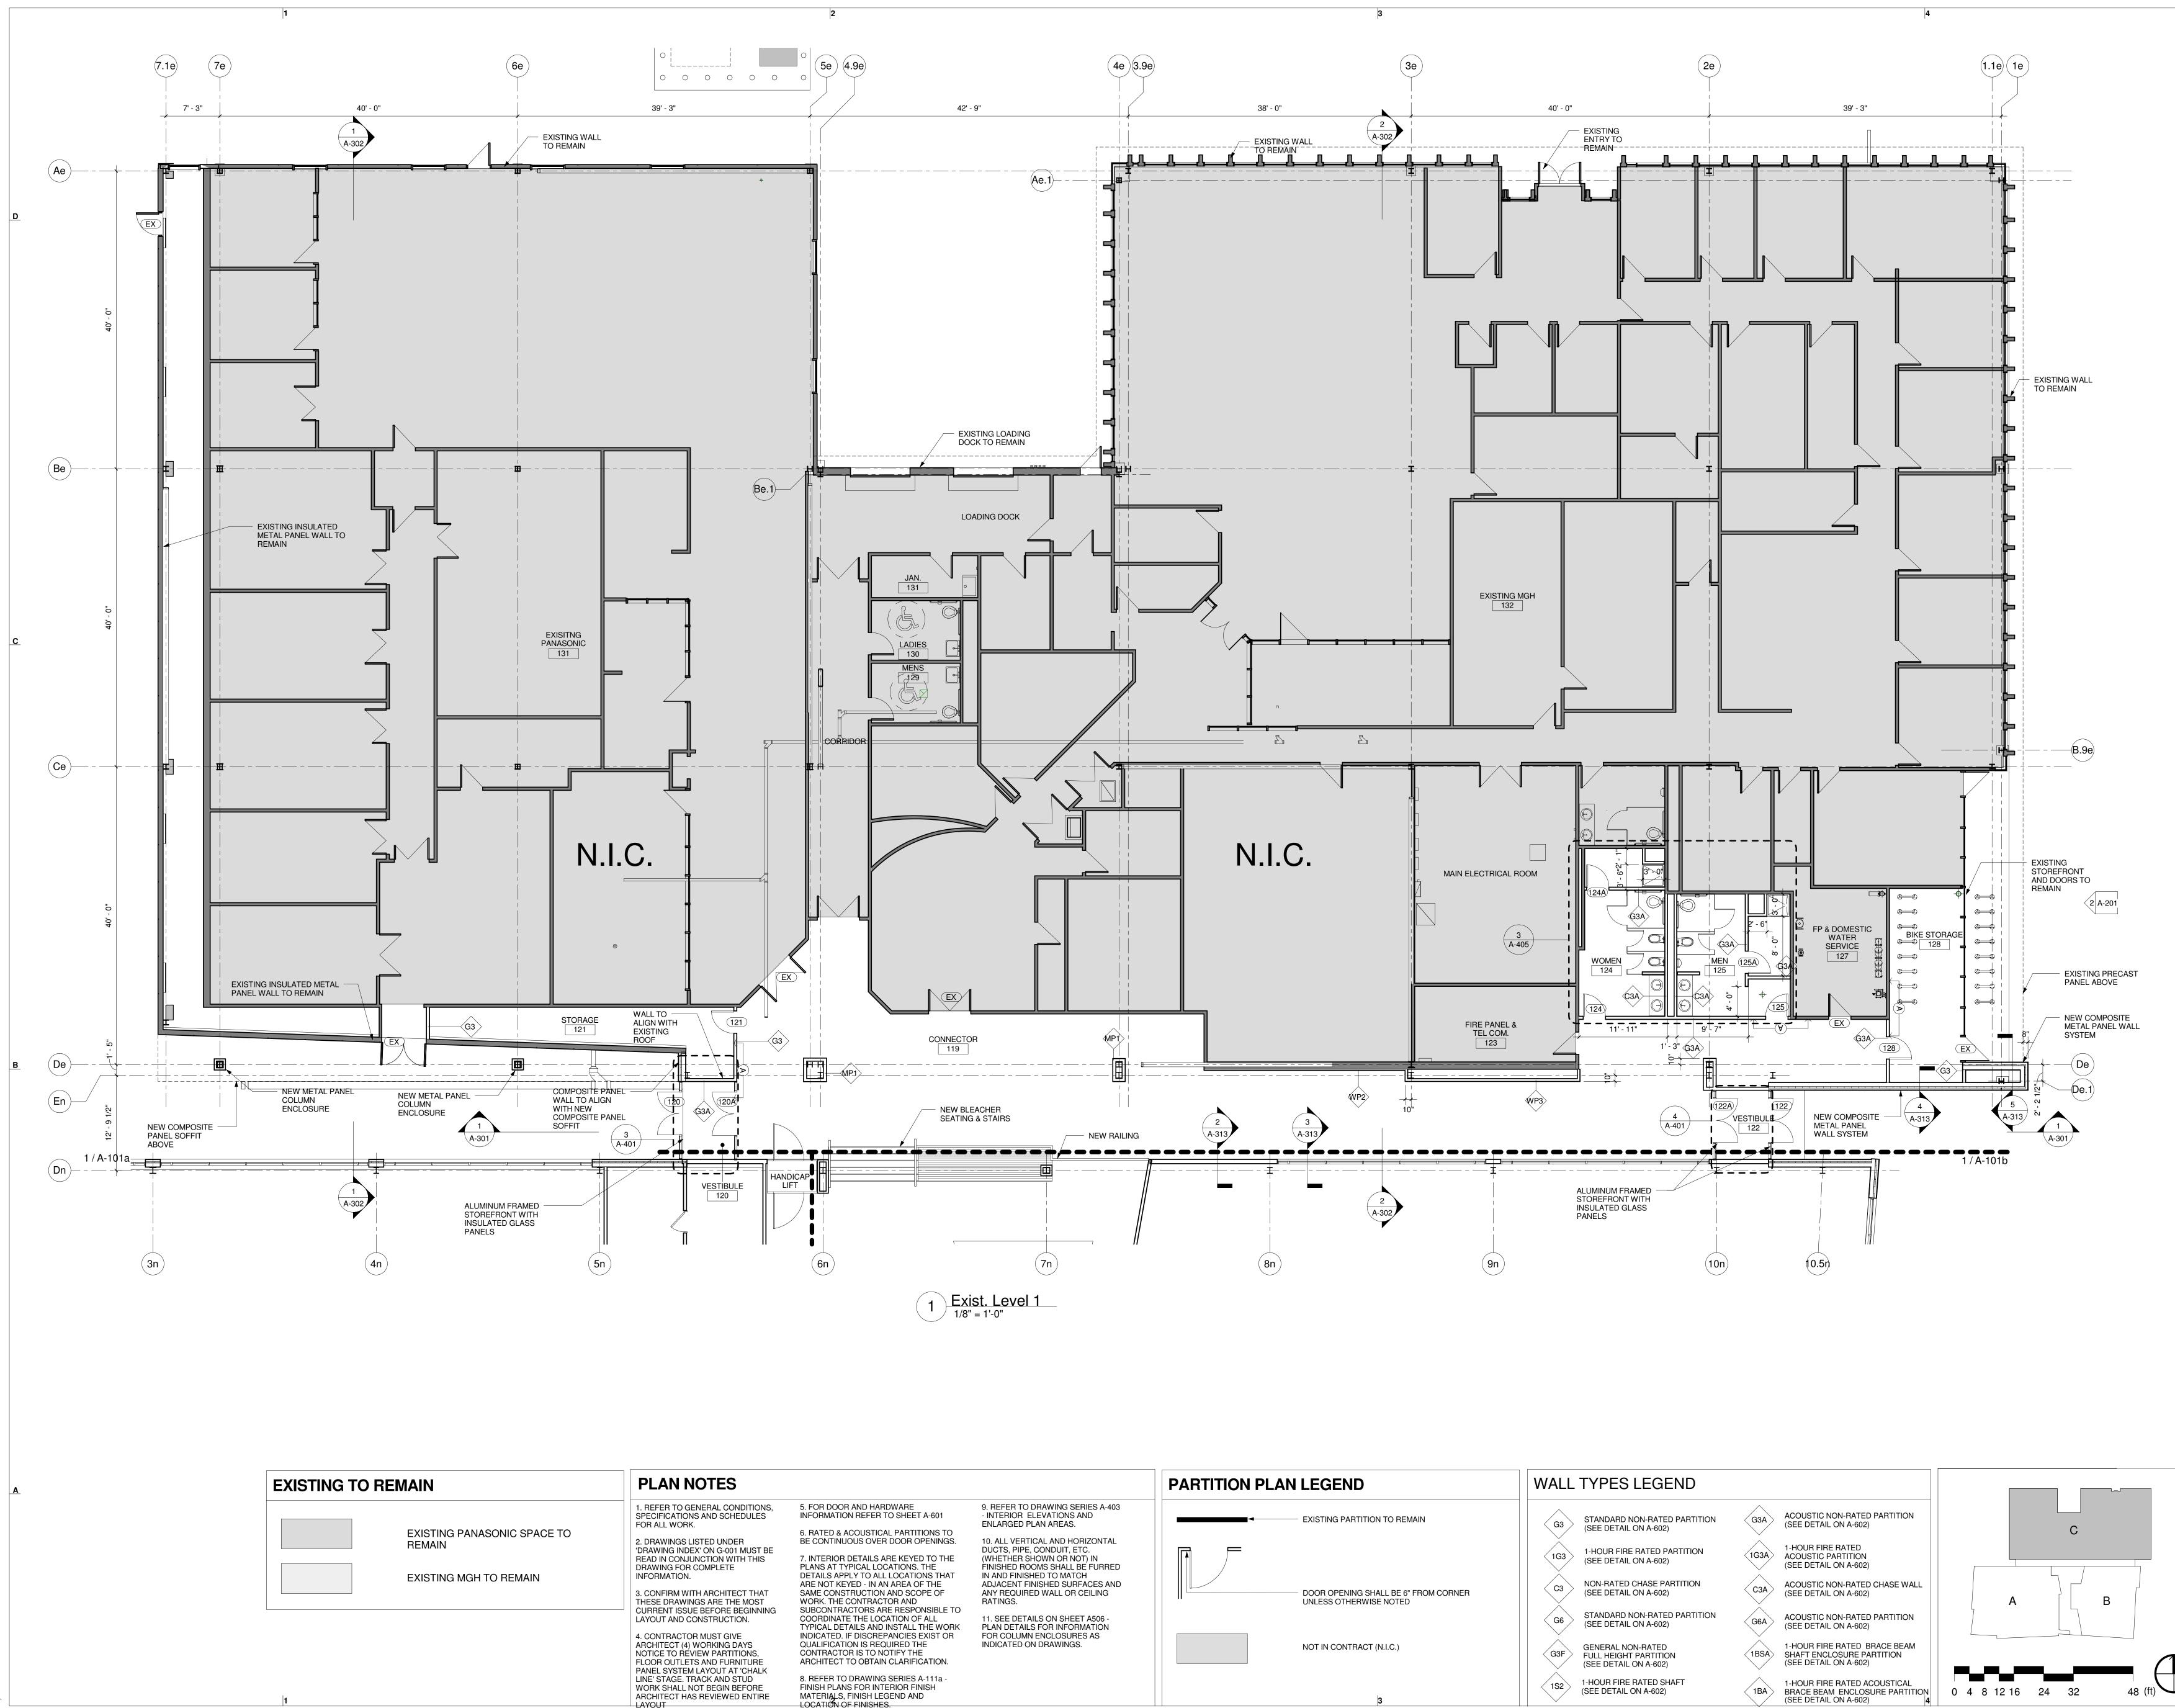

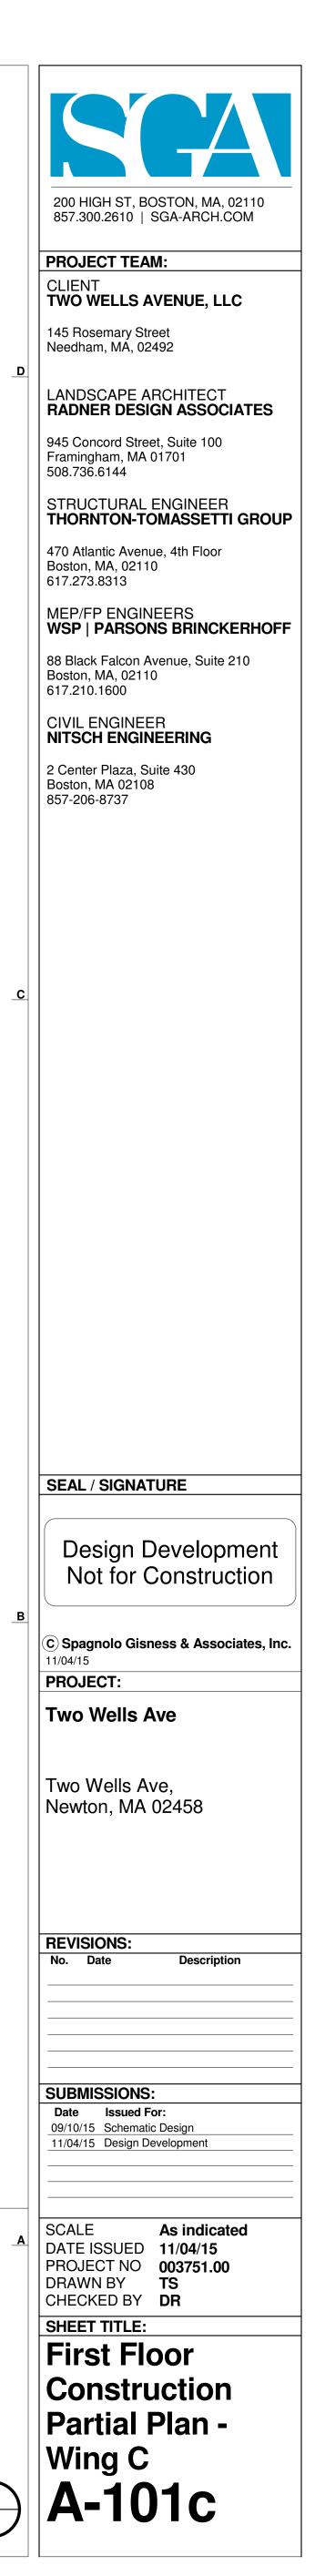

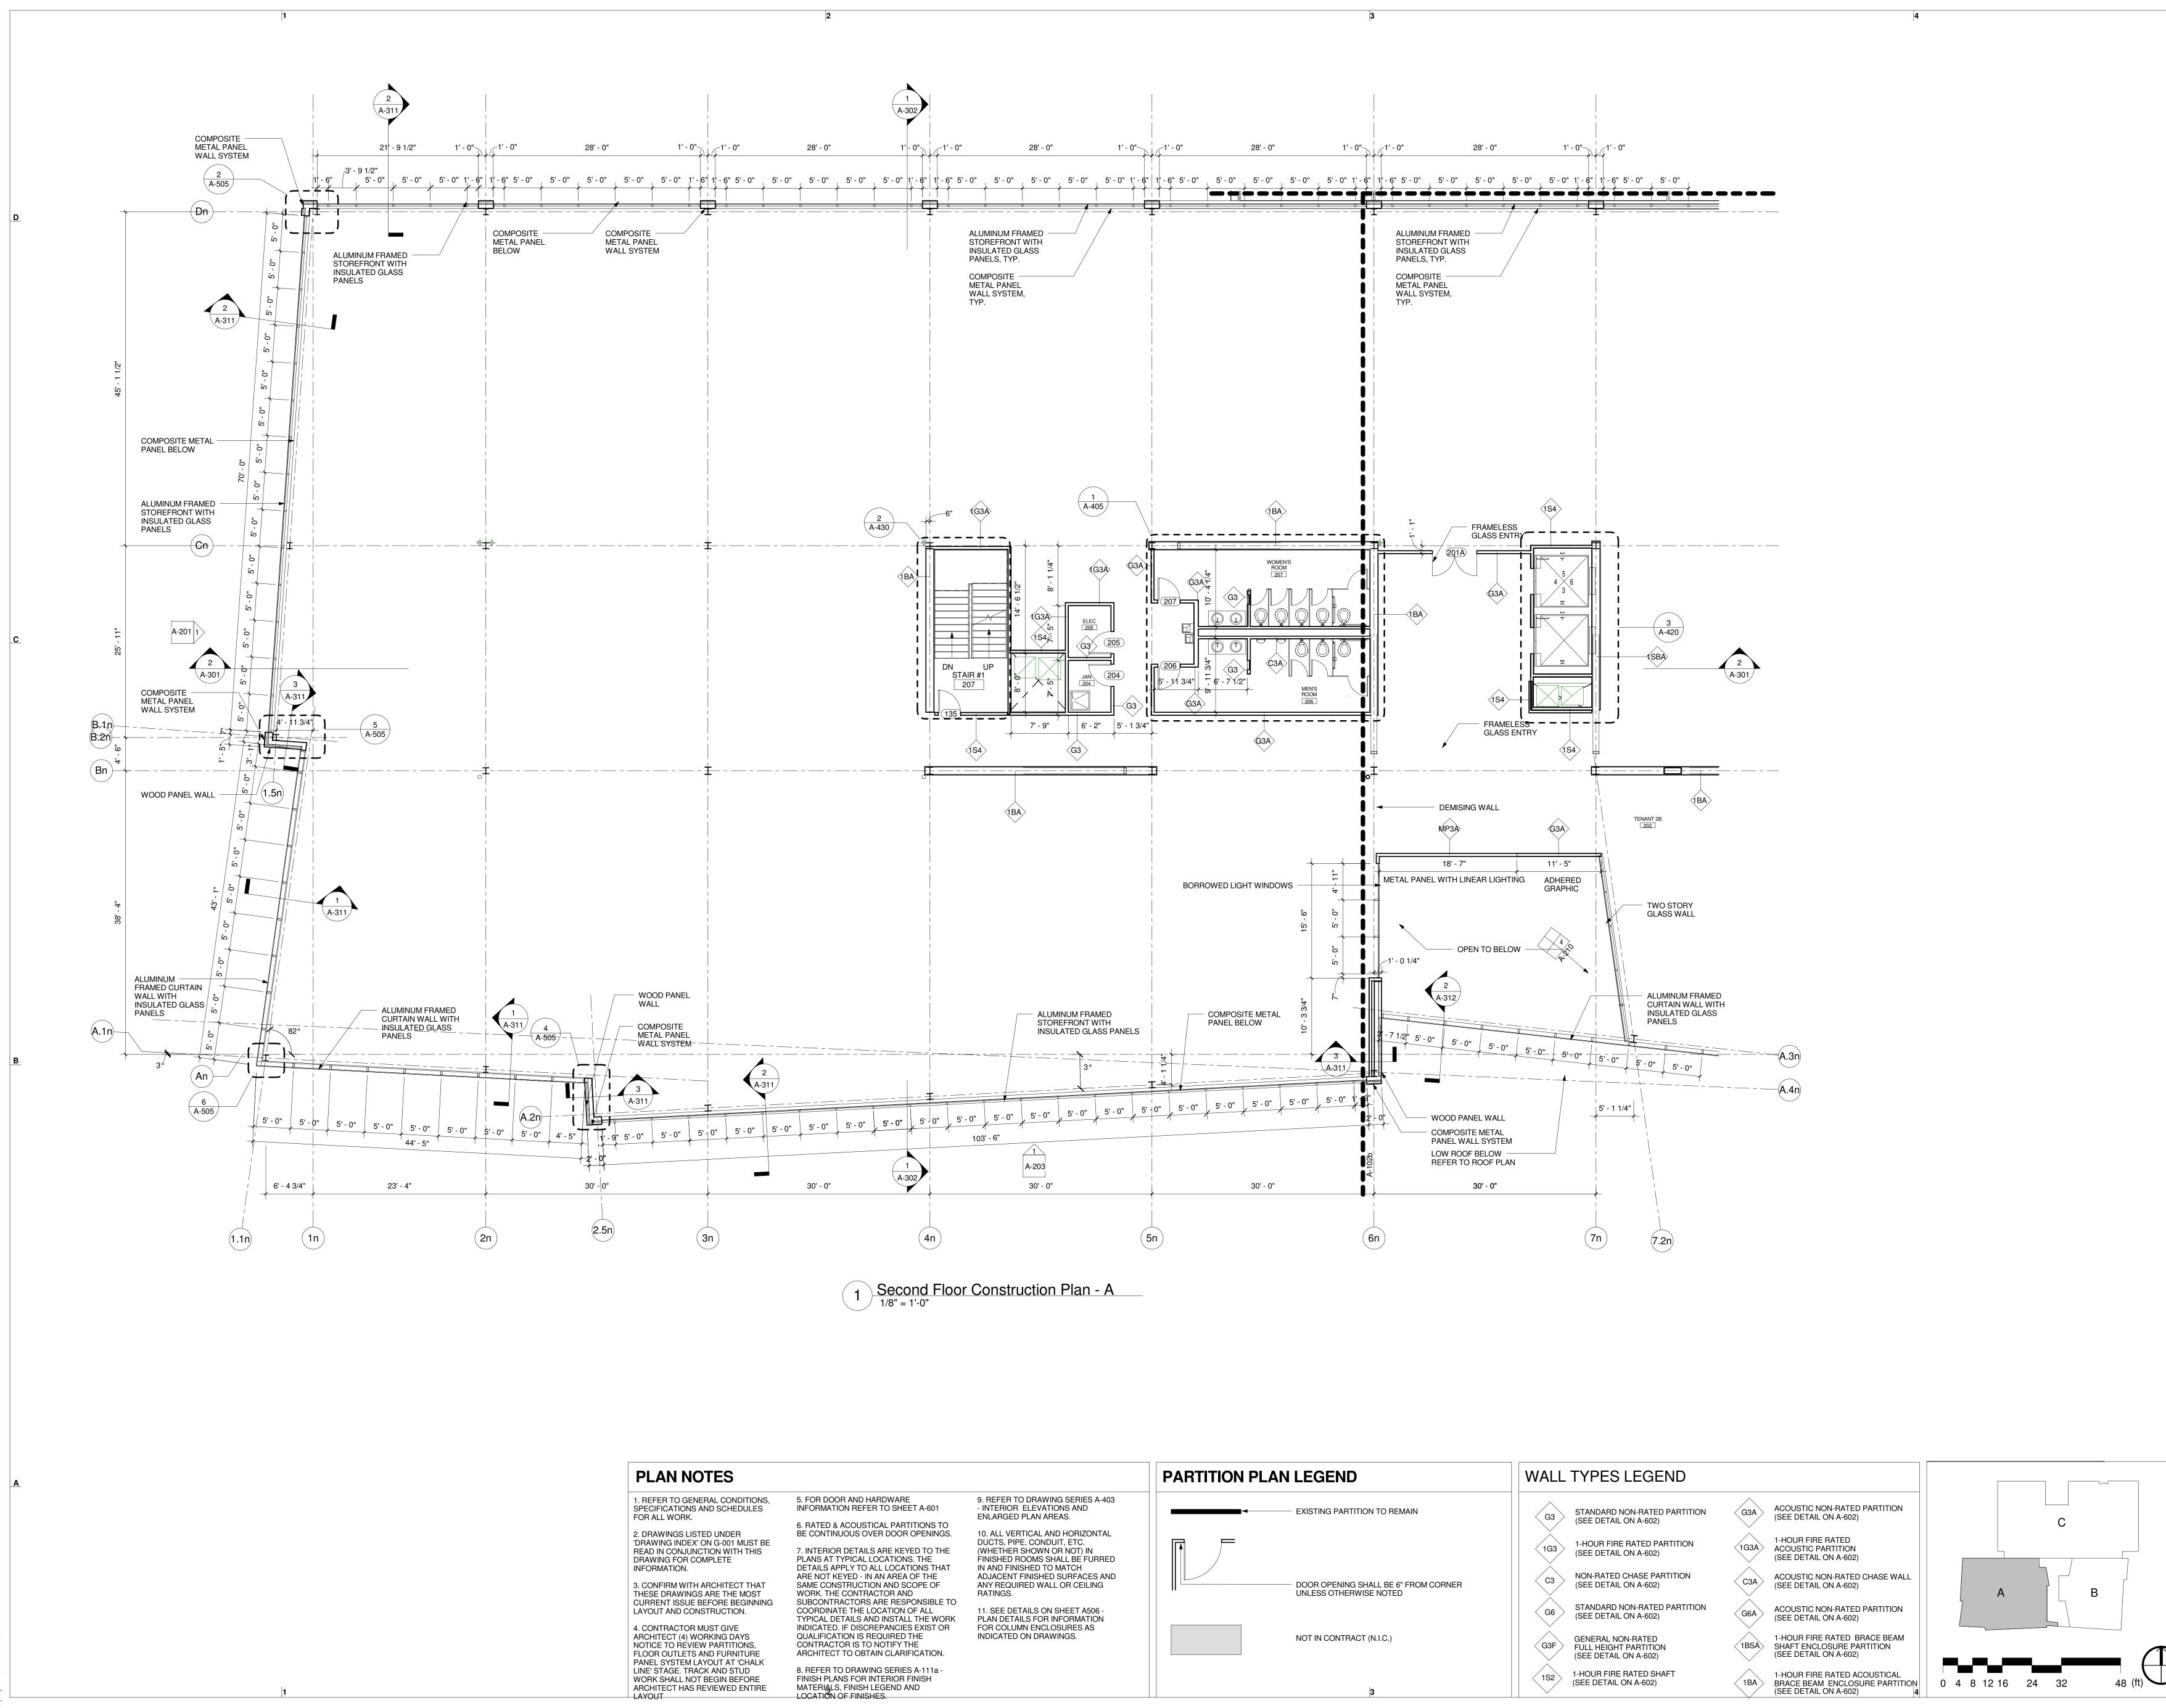

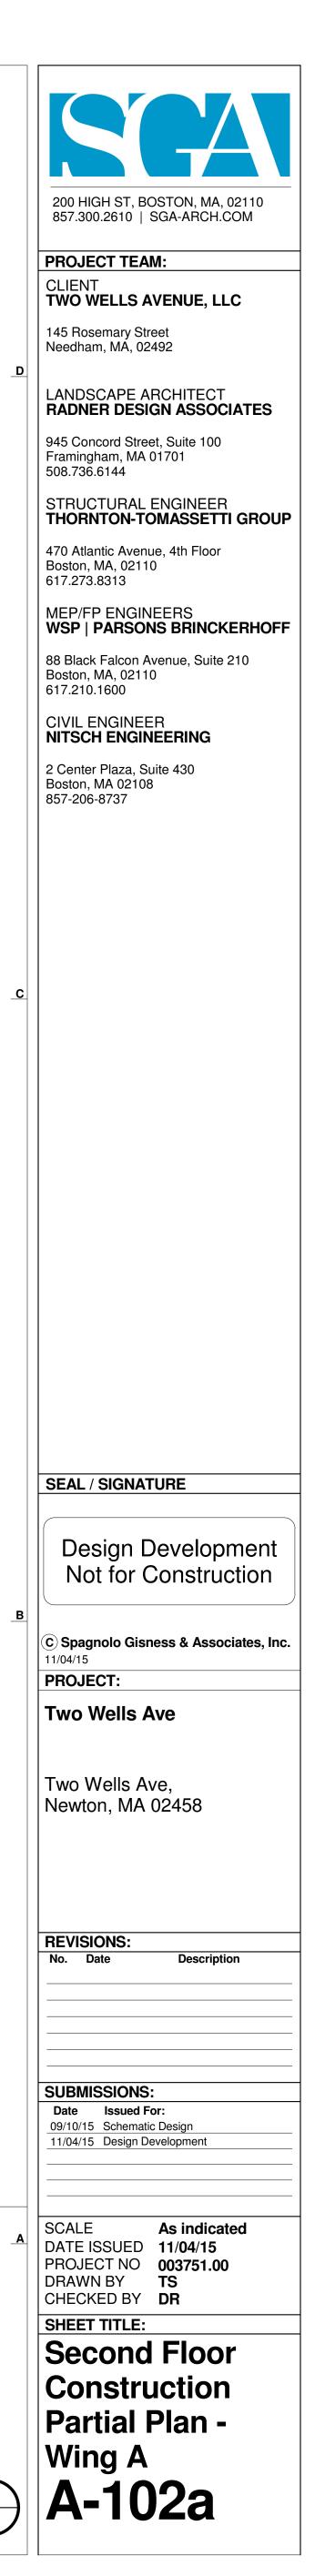

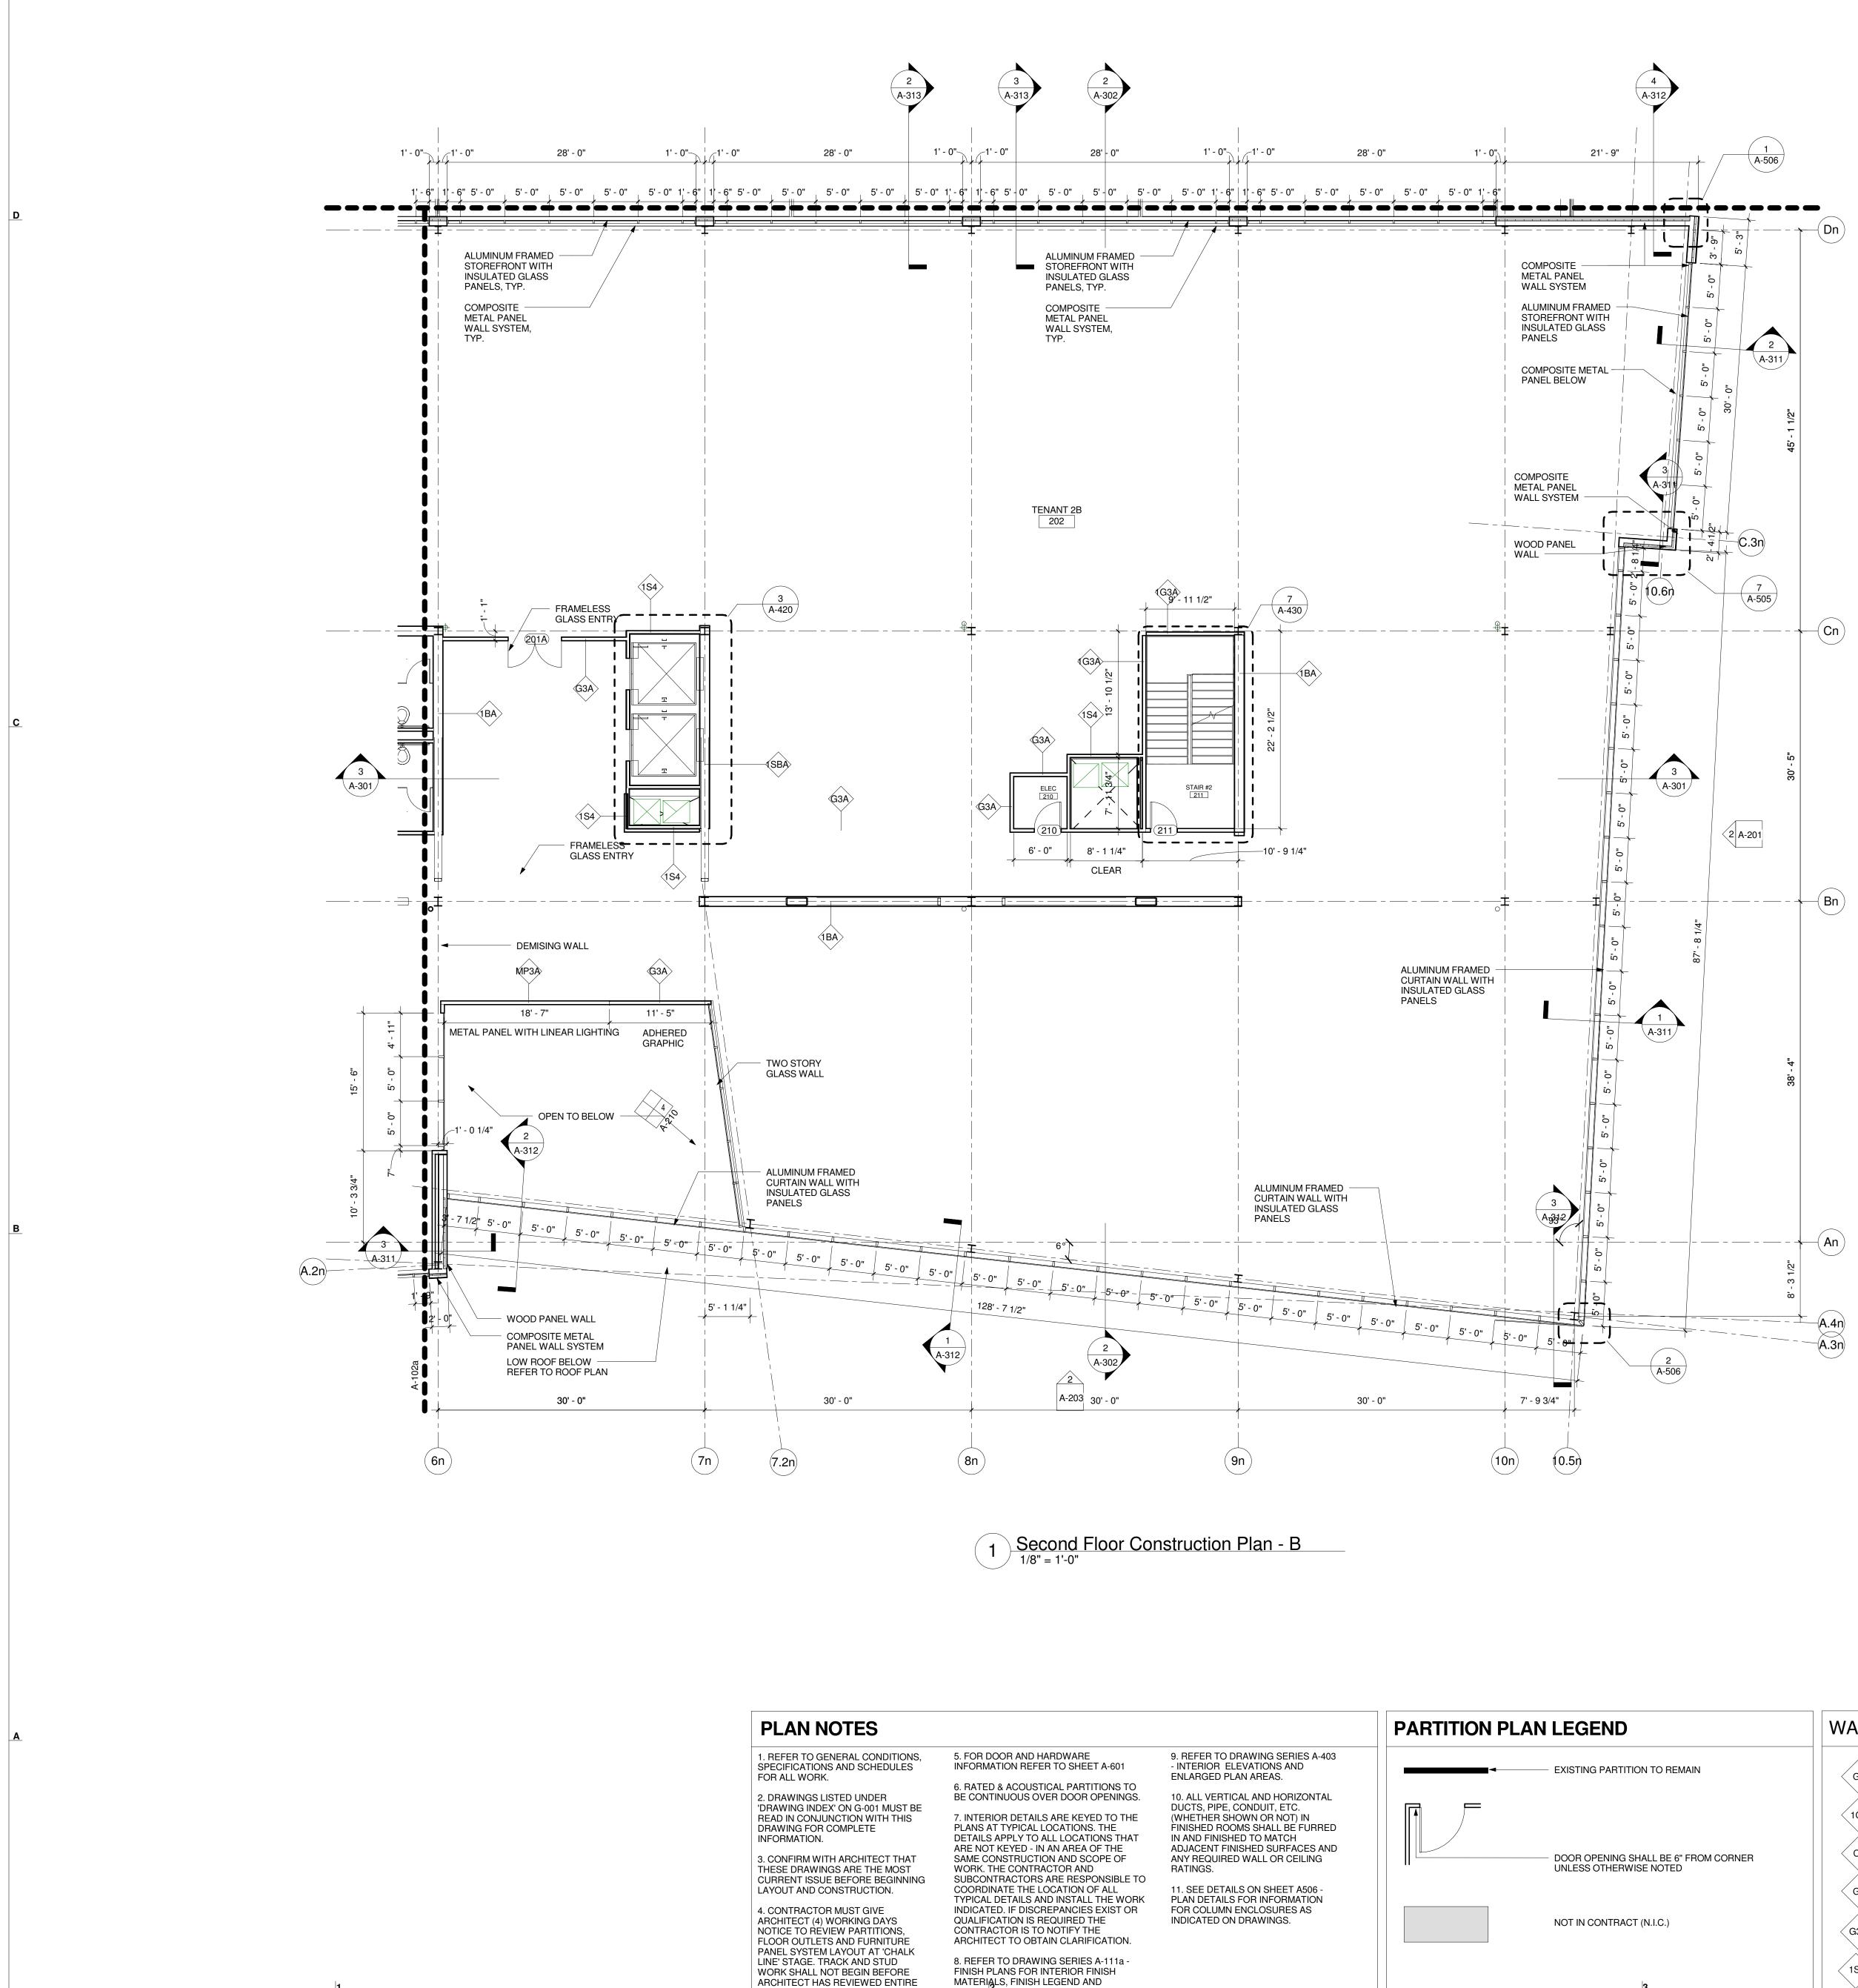


LAYOUT

WORK SHALL NOT BEGIN BEFORE ARCHITECT HAS REVIEWED ENTIRE

LOCATION OF FINISHES.

| | WALL TYPES LEGEND | | |
|-----|---|---|---------------------------|
| | G3 STANDARD NON-RATED PARTITION (SEE DETAIL ON A-602) | G3A ACOUSTIC NON-RATED PARTITION (SEE DETAIL ON A-602) | C |
| | 1G3 1-HOUR FIRE RATED PARTITION (SEE DETAIL ON A-602) | 1G3A 1-HOUR FIRE RATED ACOUSTIC PARTITION (SEE DETAIL ON A-602) | |
| NER | C3 NON-RATED CHASE PARTITION (SEE DETAIL ON A-602) | C3A ACOUSTIC NON-RATED CHASE WALL (SEE DETAIL ON A-602) | |
| | G6 STANDARD NON-RATED PARTITION (SEE DETAIL ON A-602) | G6A ACOUSTIC NON-RATED PARTITION (SEE DETAIL ON A-602) | |
| | G3F GENERAL NON-RATED FULL HEIGHT PARTITION (SEE DETAIL ON A-602) | 1-HOUR FIRE RATED BRACE BEAM SHAFT ENCLOSURE PARTITION (SEE DETAIL ON A-602) | |
| | 1S2 1-HOUR FIRE RATED SHAFT (SEE DETAIL ON A-602) | 1-HOUR FIRE RATED ACOUSTICAL BRACE BEAM ENCLOSURE PARTITION (SEE DETAIL ON A-602) 4 | 0 4 8 12 16 24 32 48 (ft) |

| D | 200 HIGH ST, BOSTON, MA, 02110 857.300.2610 SGA-ARCH.COM PROJECT TEAM: CLIENT TWO WELLS AVENUE, LLC 145 Rosemary Street Needham, MA, 02492 LANDSCAPE ARCHITECT RADNER DESIGN ASSOCIATES 945 Concord Street, Suite 100 Framingham, MA 01701 508.736.6144 STRUCTURAL ENGINEER THORNTON-TOMASSETTI GROUP 470 Atlantic Avenue, 4th Floor Boston, MA, 02110 617.273.8313 MEP/FP ENGINEERS WSP PARSONS BRINCKERHOFF 88 Black Falcon Avenue, Suite 210 Boston, MA, 02110 617.210.1600 CIVIL ENGINEER NITSCH ENGINEERING |
|--------------|---|
| C | 2 Center Plaza, Suite 430 Boston, MA 02108 857-206-8737 |
| В | SEAL / SIGNATURE Design Development Not for Construction © Spagnolo Gisness & Associates, Inc. 11/04/15 PROJECT: Two Wells Ave, Newton, MA 02458 REVISIONS: No. Date |
| _ A | No. Date Description SUBMISSIONS: |
| \mathbf{i} | A-102b |

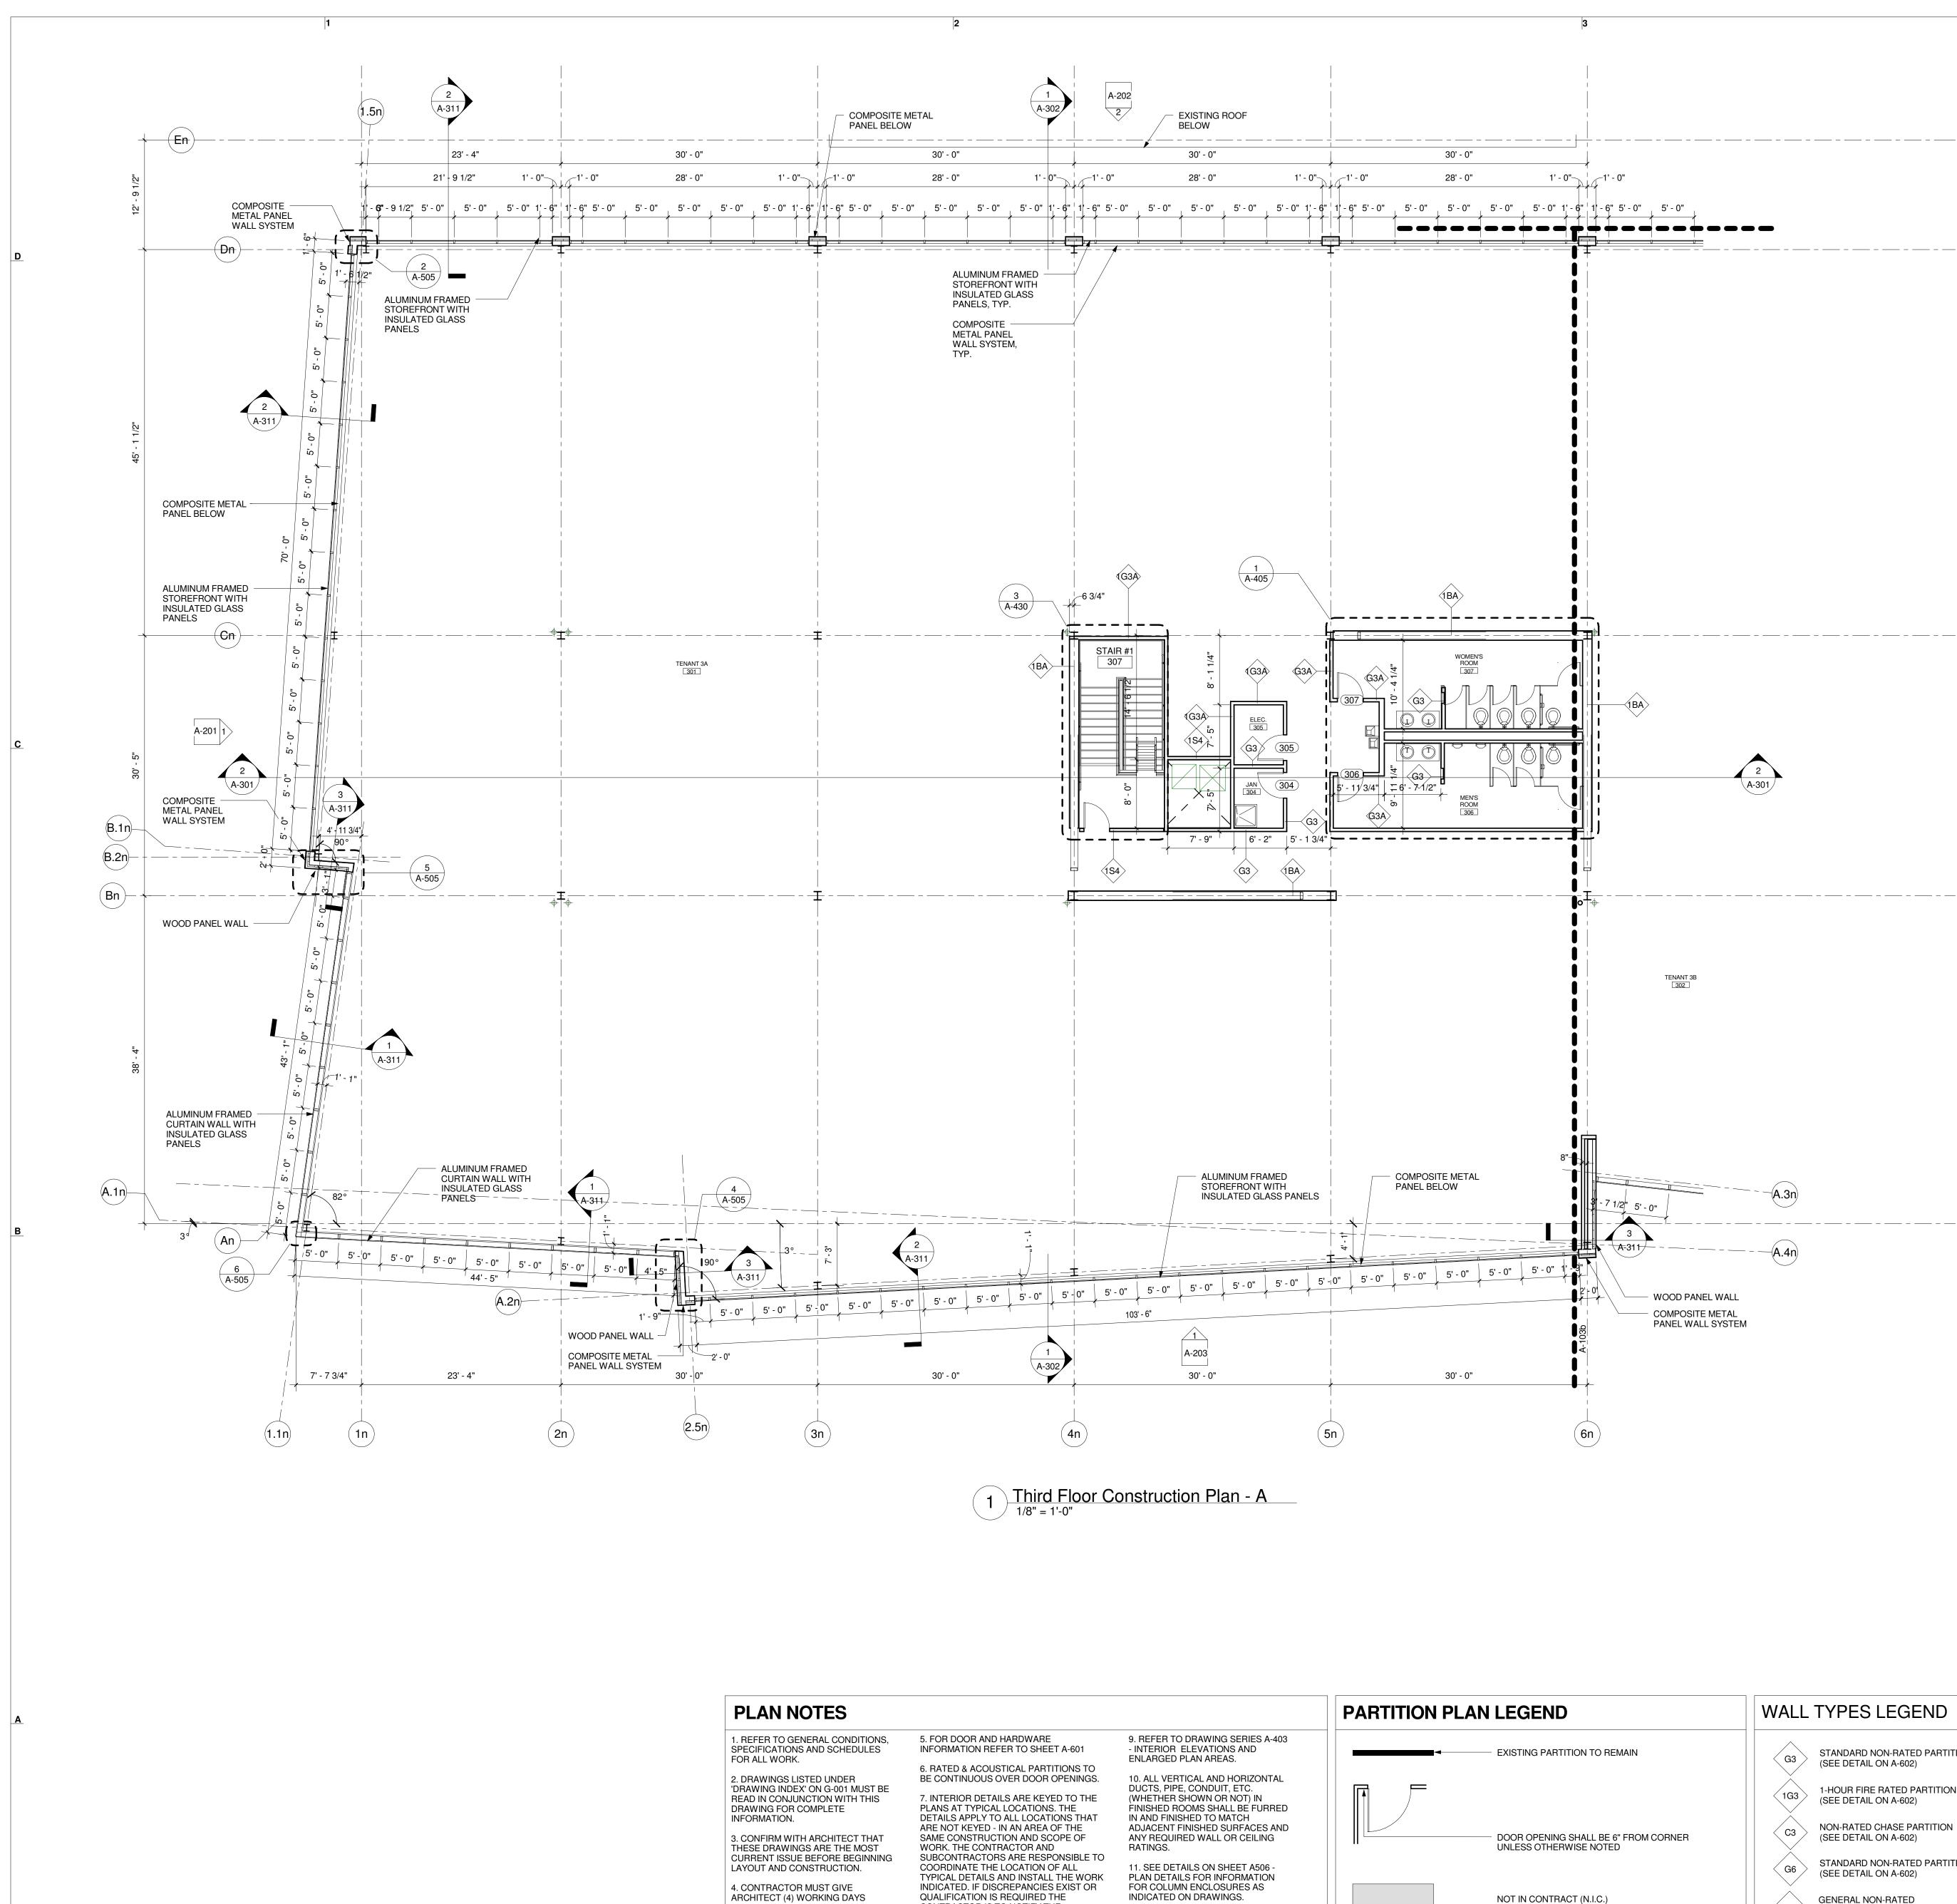

ARCHITECT HAS REVIEWED ENTIRE

NOTICE TO REVIEW PARTITIONS, FLOOR OUTLETS AND FURNITURE PANEL SYSTEM LAYOUT AT 'CHALK LINE' STAGE. TRACK AND STUD WORK SHALL NOT BEGIN BEFORE

CONTRACTOR IS TO NOTIFY THE ARCHITECT TO OBTAIN CLARIFICATION.

8. REFER TO DRAWING SERIES A-111a -

FINISH PLANS FOR INTERIOR FINISH

MATERIALS, FINISH LEGEND AND

LOCATIÓN ÓF FINISHES.

 $\begin{pmatrix} 2 \end{pmatrix}$


∖**A-3**01,

−(A.3r — - — - — - — (A.4n)


- WOOD PANEL WALL - COMPOSITE METAL PANEL WALL SYSTEM

TENANT 3B


WALL TYPES LEGEND ACOUSTIC NON-RATED PARTITION STANDARD NON-RATED PARTITION 〈 G3A ` < G3 🔾 (SEE DETAIL ON A-602) (SEE DETAIL ON A-602) 1-HOUR FIRE RATED 1-HOUR FIRE RATED PARTITION (1G3A) ACOUSTIC PARTITION < 1G3 🔾 (SEE DETAIL ON A-602) (SEE DETAIL ON A-602) NON-RATED CHASE PARTITION ACOUSTIC NON-RATED CHASE WALL C3 < C3A > (SEE DETAIL ON A-602) (SEE DETAIL ON A-602) STANDARD NON-RATED PARTITION ACOUSTIC NON-RATED PARTITION G6 G6A (SEE DETAIL ON A-602) (SEE DETAIL ON A-602) 1-HOUR FIRE RATED BRACE BEAM GENERAL NON-RATED 1BSA SHAFT ENCLOSURE PARTITION (SEE DETAIL ON A-602) \langle G3F \rangle FULL HEIGHT PARTITION (SEE DETAIL ON A-602) 1-HOUR FIRE RATED SHAFT 1-HOUR FIRE RATED ACOUSTICAL 1S2 1BA BRACE BEAM ENCLOSURE PARTITION 0 4 8 12 16 24 32 (SEE DETAIL ON A-602) (SEE DETAIL ON A-602)

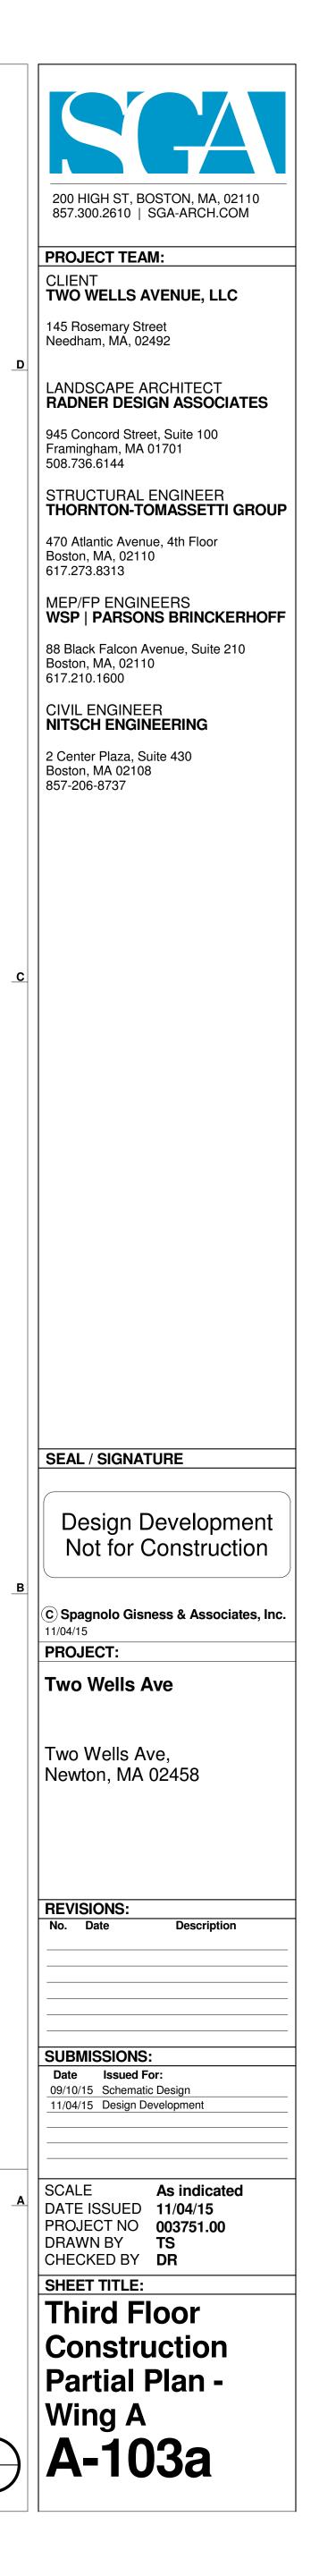


48 (ft)

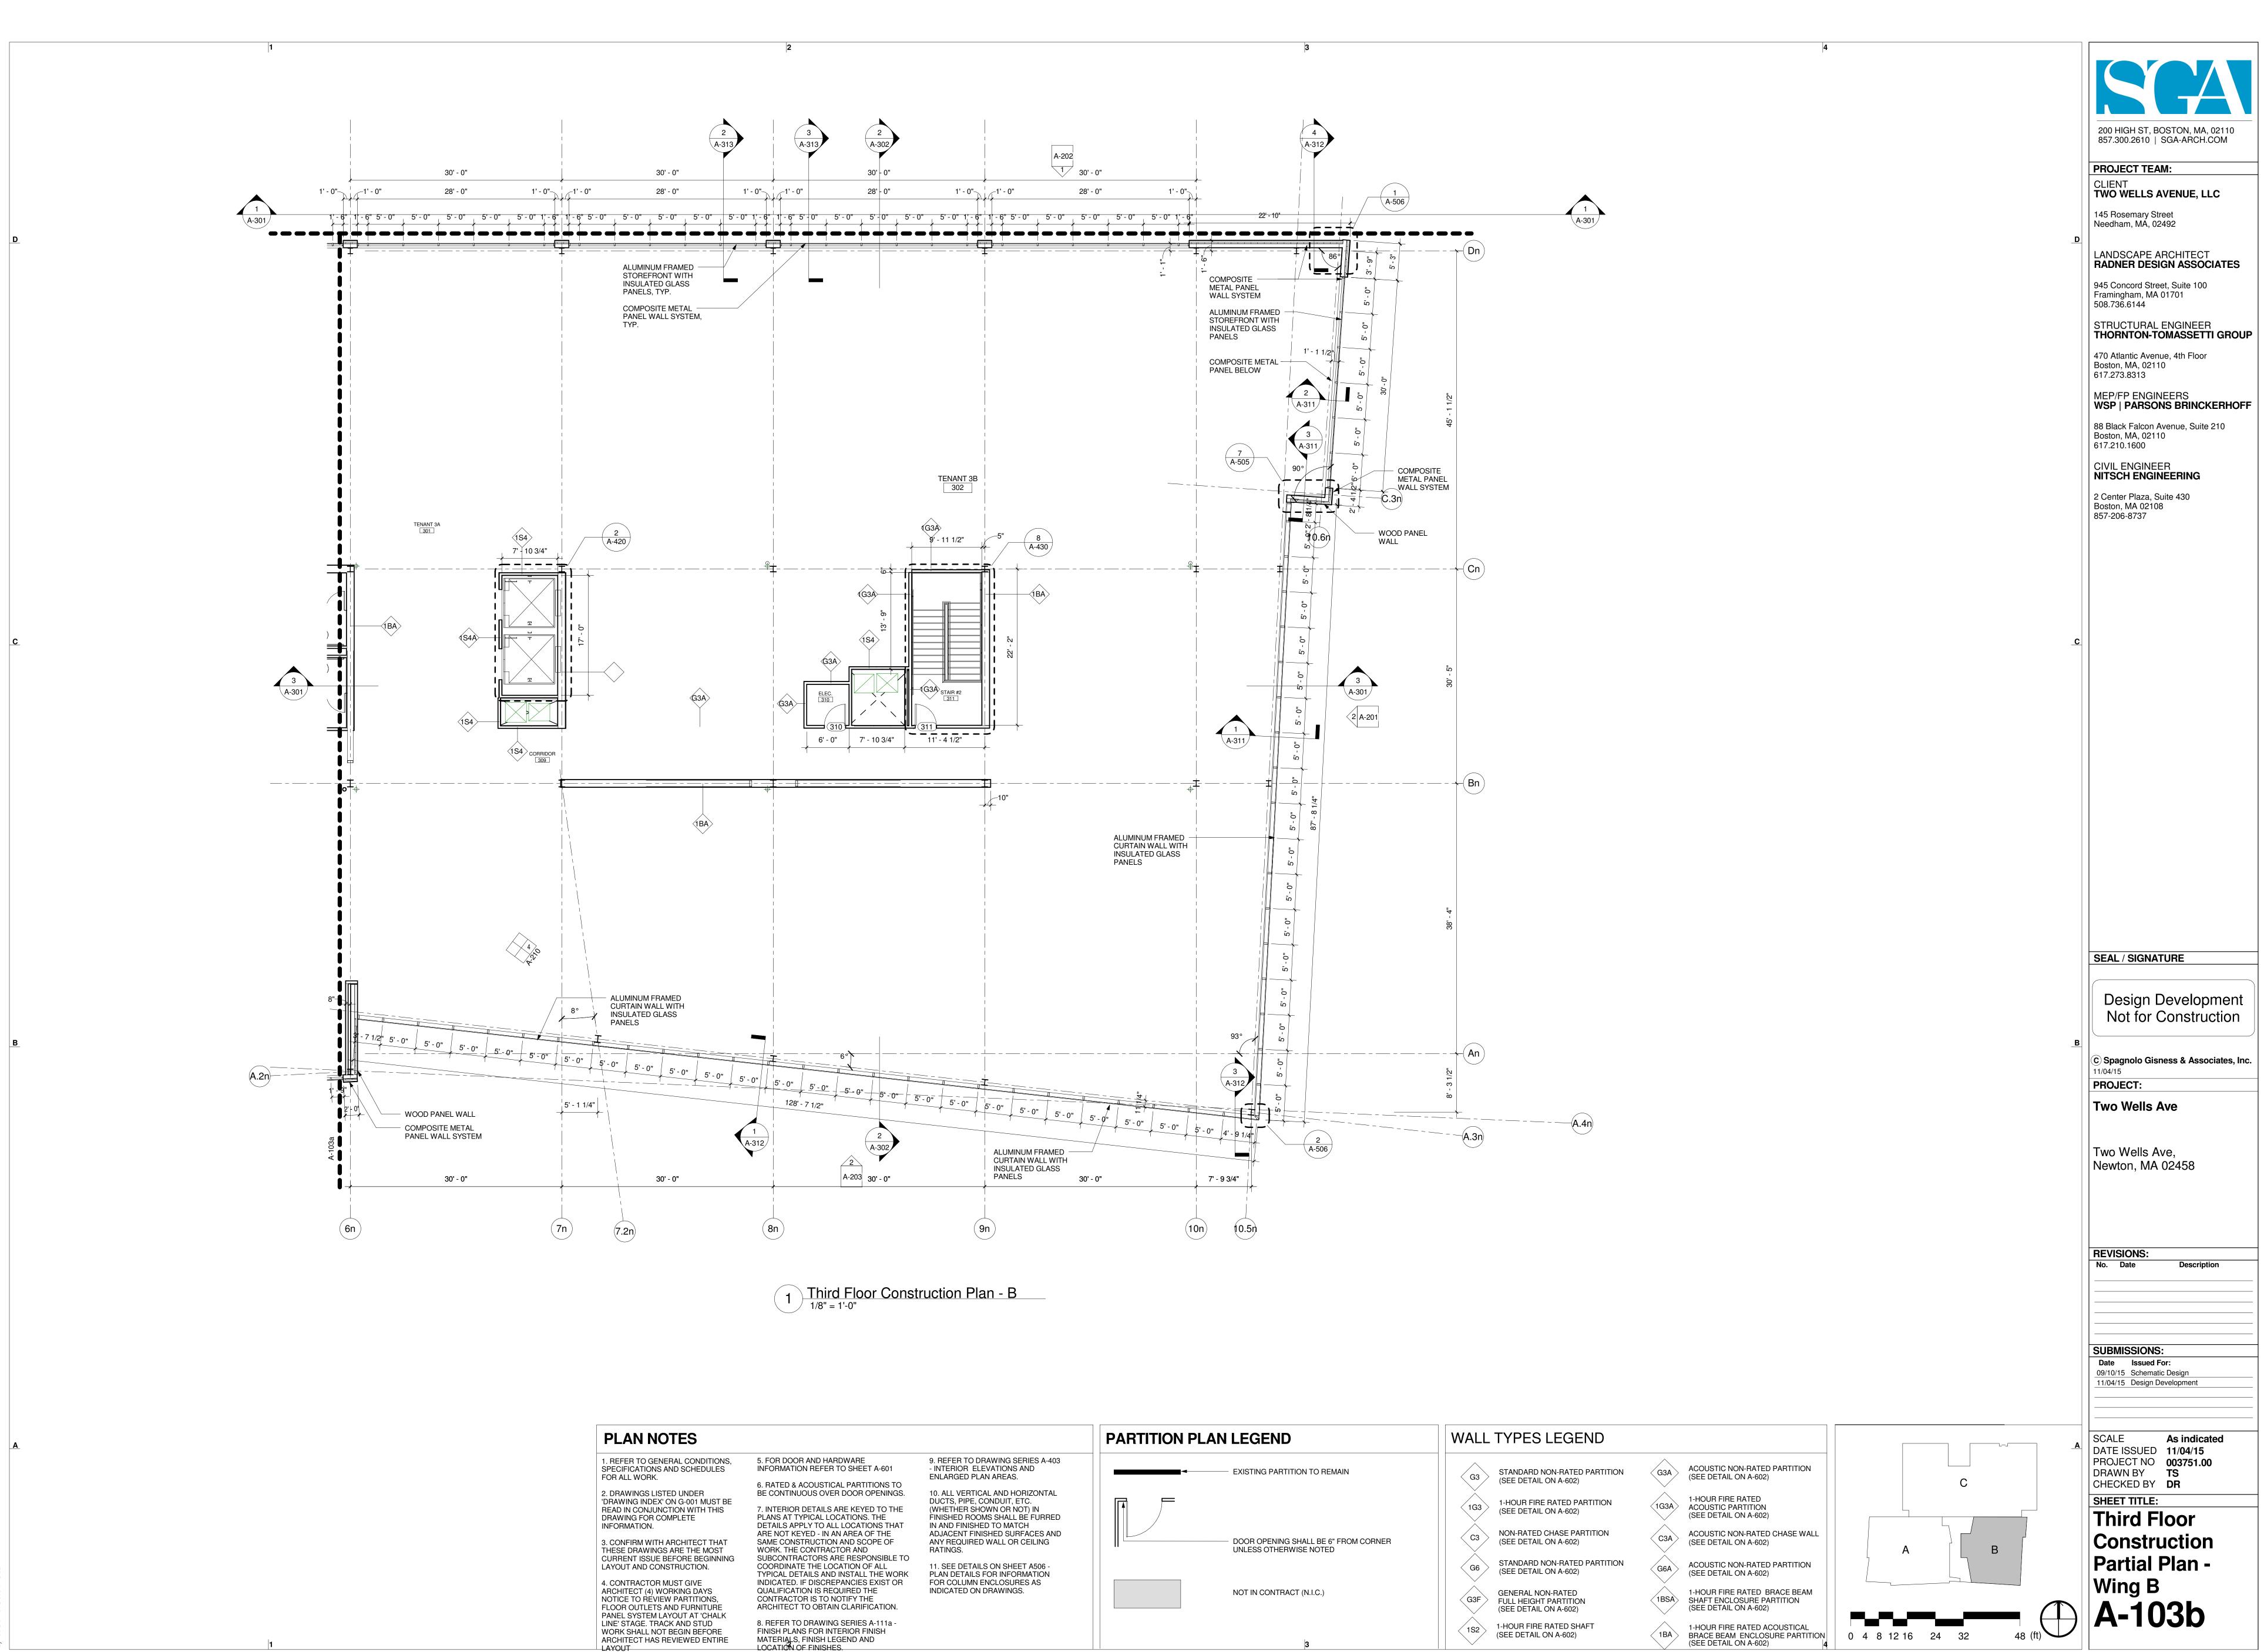

| NOTES | PARTITI | PARTITION PLAN LEGEND | | | | | | |
|--|--|---|---|--|--|--|--|--|
| GENERAL CONDITIONS, INS AND SCHEDULES IK.5. FOR DOOR AND HAR INFORMATION REFERINS AND SCHEDULES IK.INFORMATION REFERILSTED UNDER DEX' ON G-001 MUST BE JUNCTION WITH THIS R COMPLETE I.6. RATED & ACOUSTICA BE CONTINUOUS OVERINTERIOR DETAILS A PLANS AT TYPICAL LOC DETAILS APPLY TO ALL ARE NOT KEYED - IN AN SAME CONSTRUCTION INGS ARE THE MOST UE BEFORE BEGINNING CONSTRUCTION.7. INTERIOR DETAILS A PLANS AT TYPICAL LOC DETAILS APPLY TO ALL ARE NOT KEYED - IN AN SAME CONSTRUCTION WORK. THE CONTRACT SUBCONTRACTORS AF COORDINATE THE LOC TYPICAL DETAILS AND OR MUST GIVE OR MUST GIV | TO SHEET A-601- INTERIOR ELEVAT ENLARGED PLAN AF AL PARTITIONS TO A DOOR OPENINGS.AL PARTITIONS TO A DOOR OPENINGS.10. ALL VERTICAL AI DUCTS, PIPE, COND RE KEYED TO THE CATIONS. THE AREA OF THE AND SCOPE OF OR AND10. ALL VERTICAL AI DUCTS, PIPE, COND FINISHED ROOMS SI INSTALL THE VAREA OF THE AND SCOPE OF OR AND10. ALL VERTICAL AI DUCTS, PIPE, COND FINISHED ROOMS SI AND SCOPE OF ANY REQUIRED WAI RATINGS.AREA OF THE AND SCOPE OF OR AND CR AND RE RESPONSIBLE TO ATION OF ALL INSTALL THE WORK PANCIES EXIST OR UIRED THE I CLARIFICATION.11. SEE DETAILS ON FOR COLUMN ENCLY INDICATED ON DRAY DICATED ON DRAY DICATED ON DRAYSERIES A-111a - ERIOR FINISH GEND AND- | IONS AND REAS. ND HORIZONTAL UIT, ETC. OR NOT) IN HALL BE FURRED MATCH D SURFACES AND LL OR CEILING | EXISTING PARTITION TO REMAIN DOOR OPENING SHALL BE 6" FF UNLESS OTHERWISE NOTED NOT IN CONTRACT (N.I.C.) | | | | | |

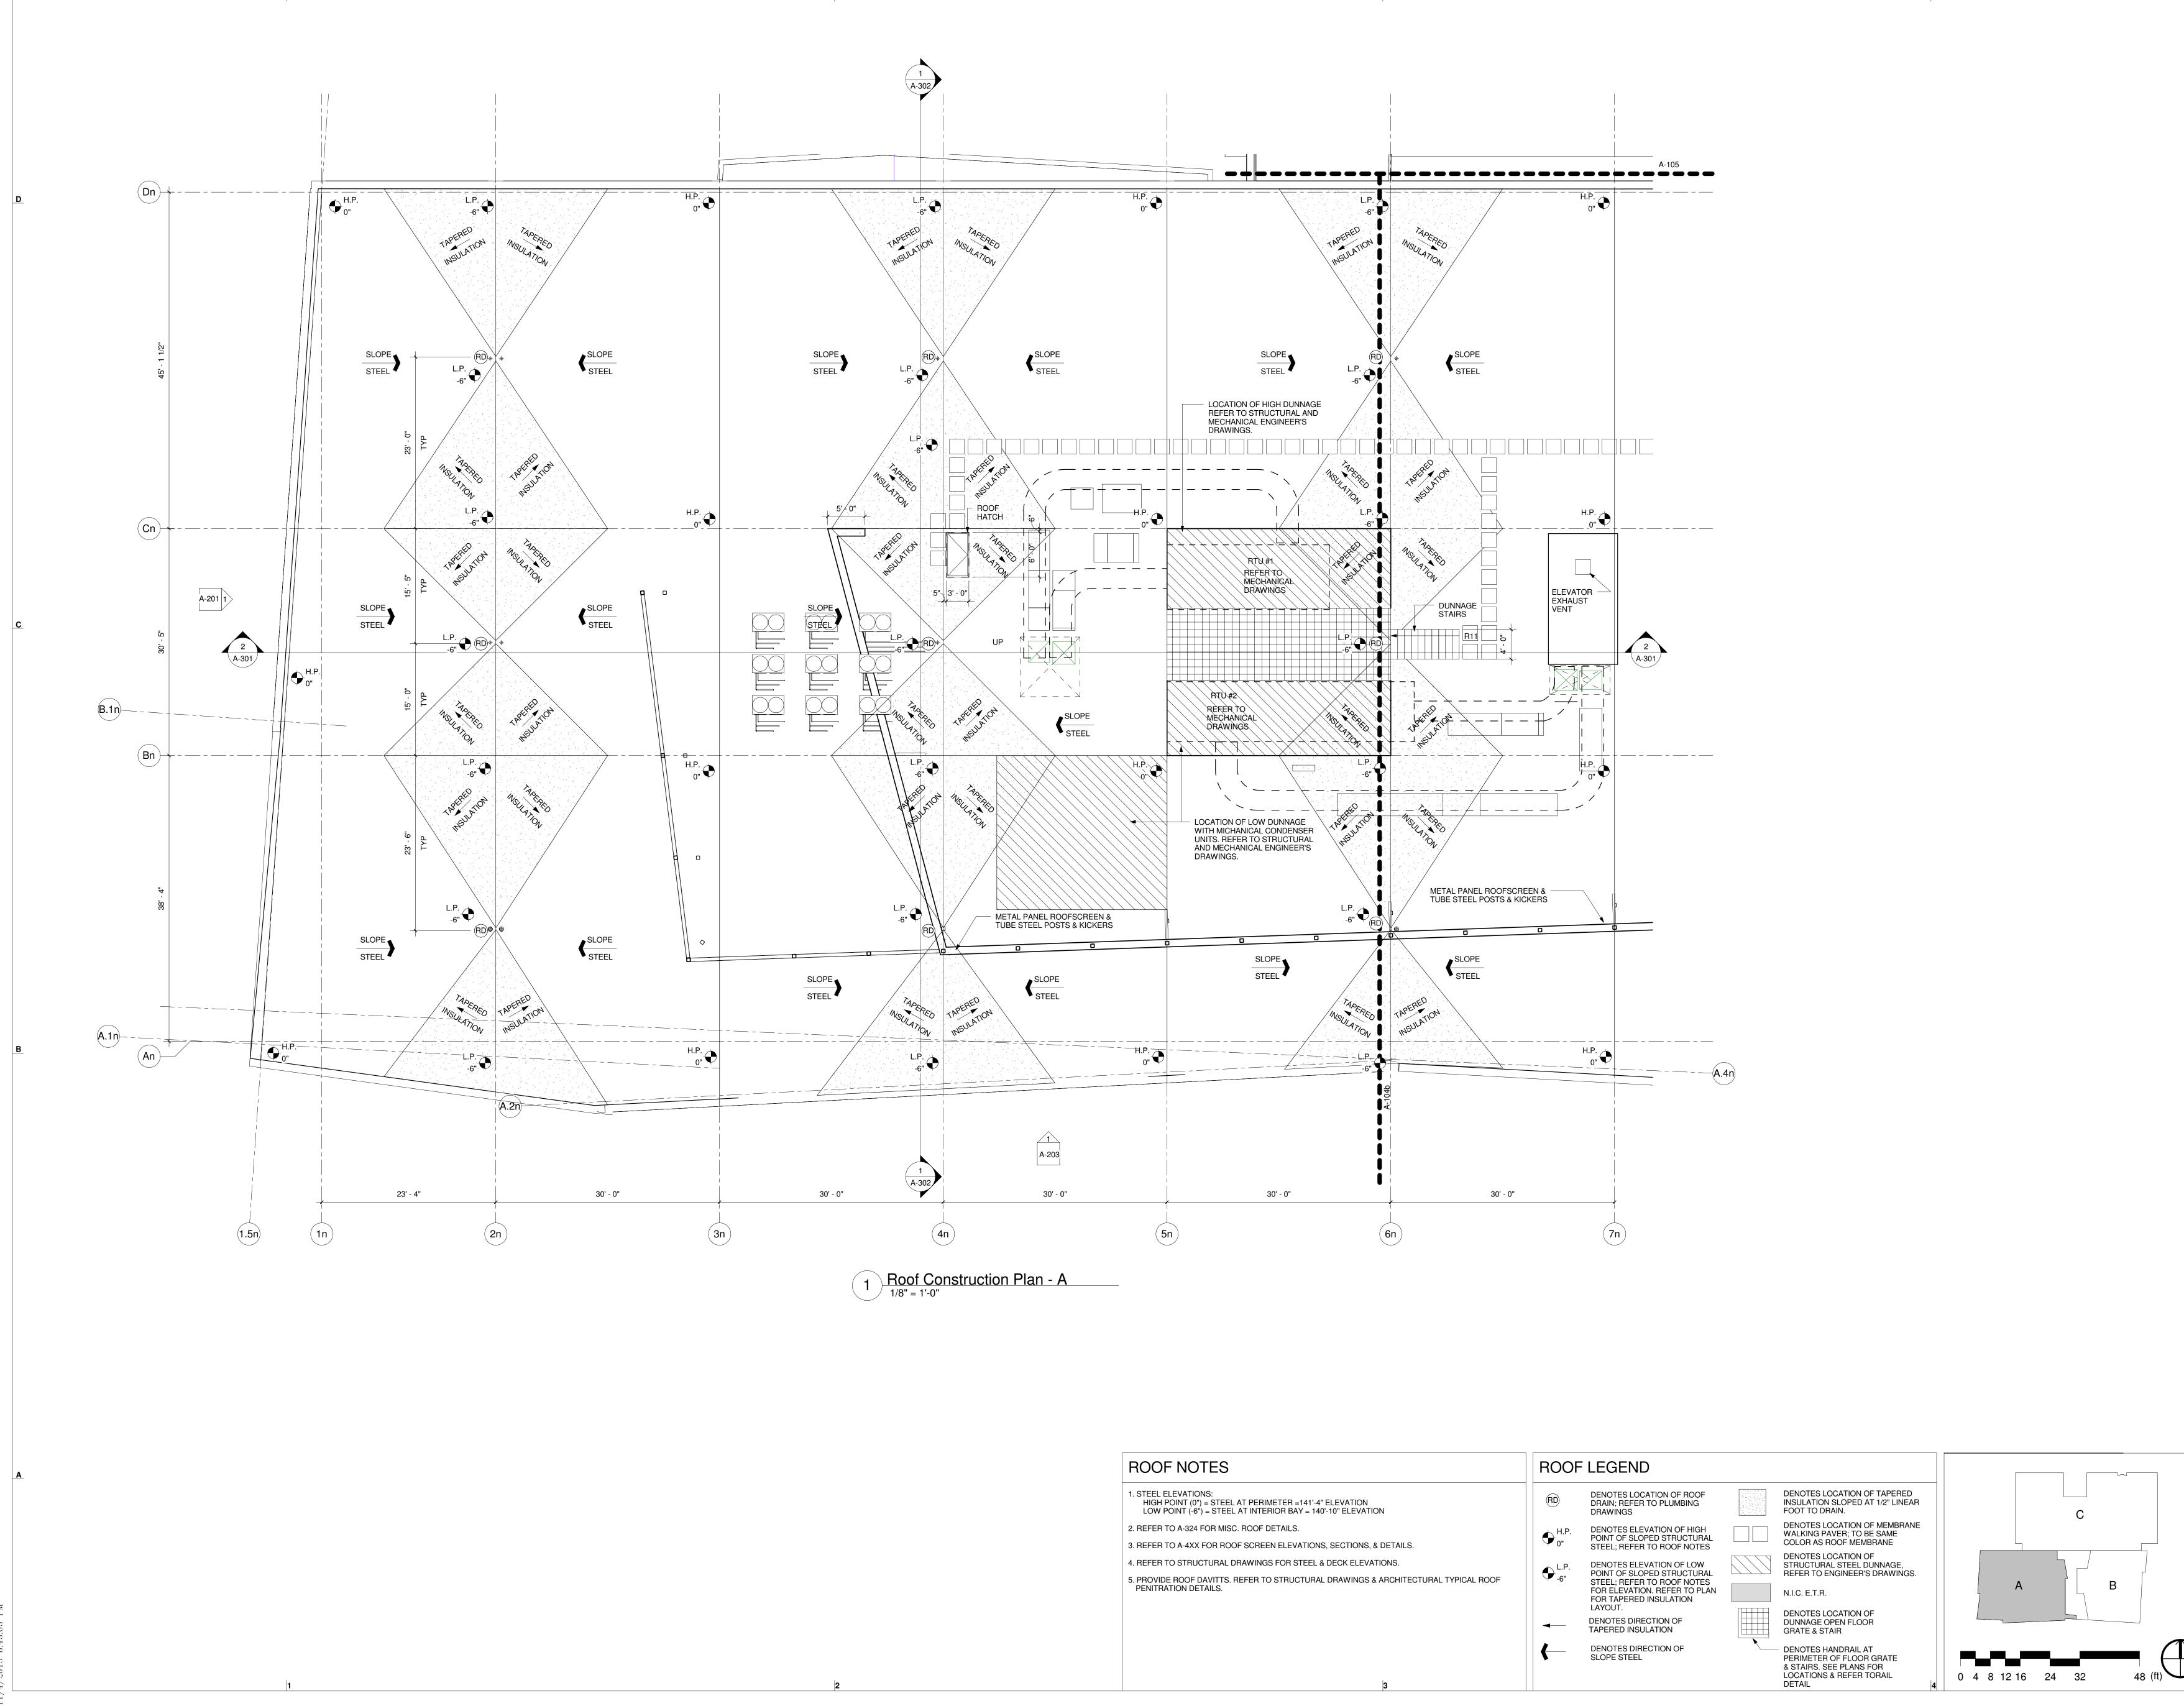


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| 2 Center Plaza, Suite 430 Boston, MA 02108 857-206-8737 |
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| REVISIONS: No. Date Description |
| SCALE As indicated DATE ISSUED 11/04/15 003751.00 DRAWN BY CHECKED BY DR SHEET TITLE: Roof Construction Partial Plan - Wing A Wing A A-104a |
| |

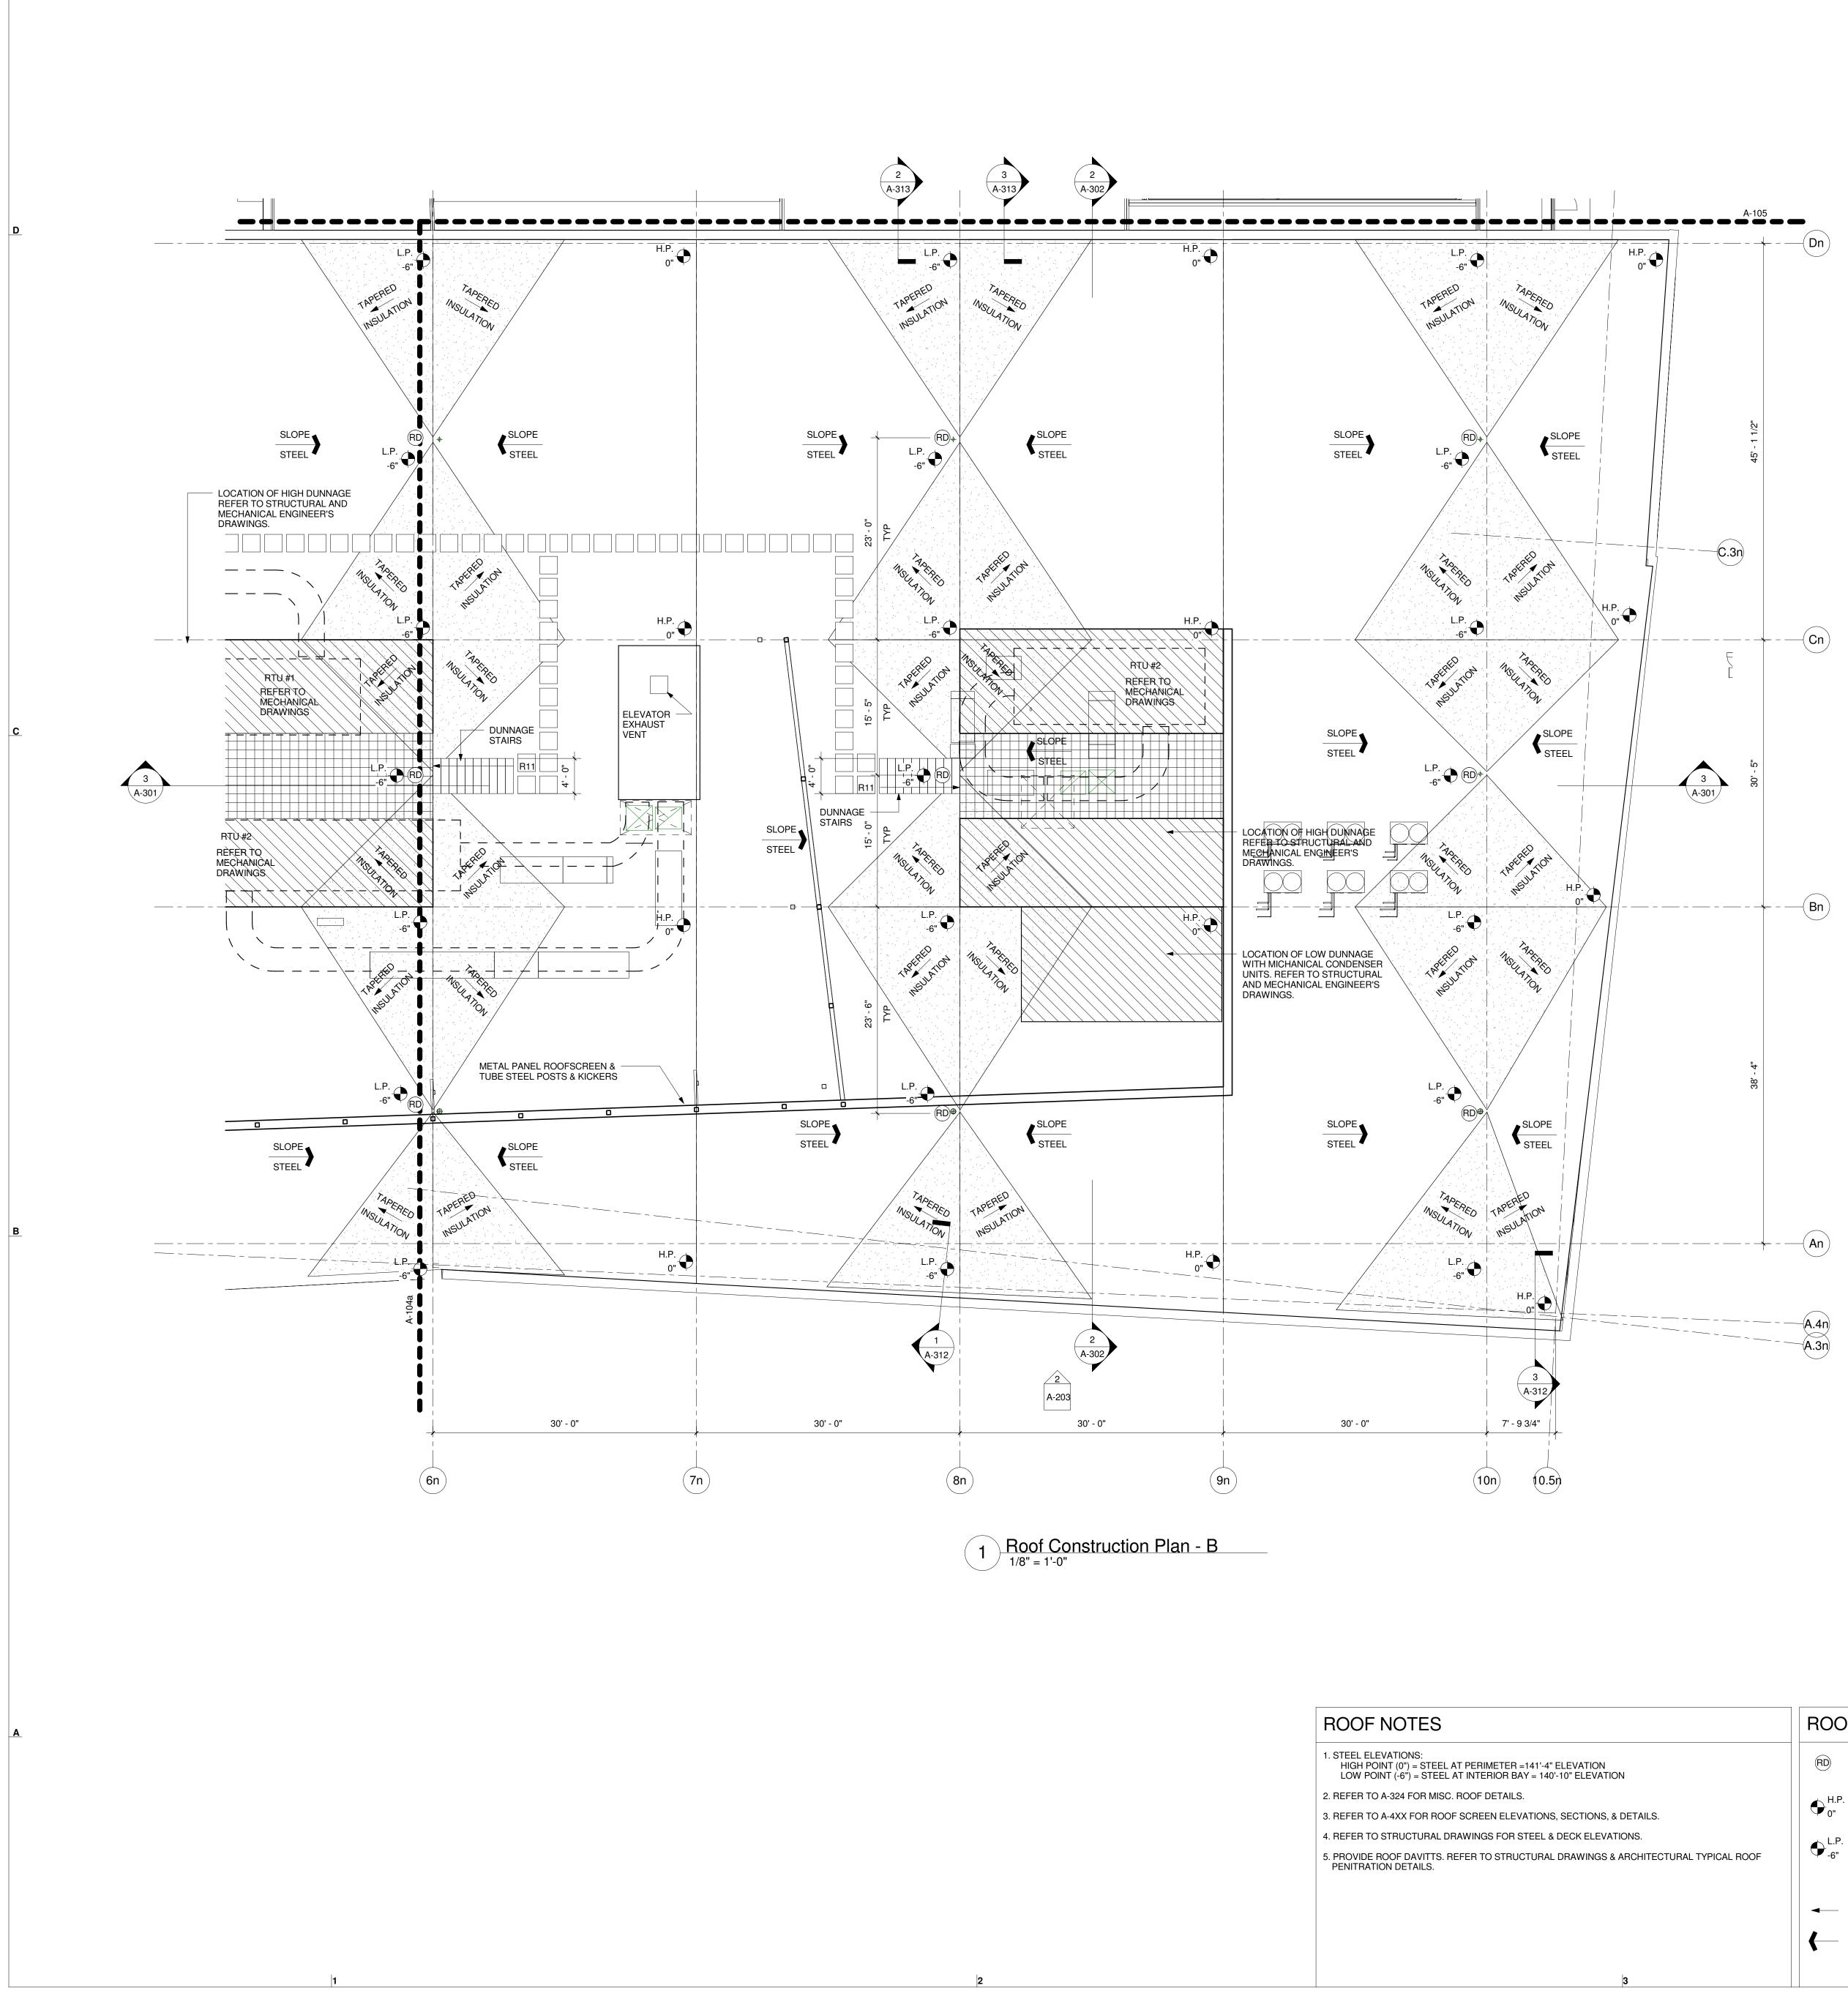

| | ROOF | ELEGEND | | | | | | | | |
|------------|---|---|--|---|----|-------|----|----|---|--------|
| | RD | DENOTES LOCATION OF ROOF DRAIN; REFER TO PLUMBING DRAWINGS | DENOTES LOCATION OF TAPERED INSULATION SLOPED AT 1/2" LINEAR FOOT TO DRAIN. | | | | | C | | |
| | Ф ^{Н.Р.} 0" | DENOTES ELEVATION OF HIGH POINT OF SLOPED STRUCTURAL STEEL; REFER TO ROOF NOTES | DENOTES LOCATION OF MEMBRANE WALKING PAVER; TO BE SAME COLOR AS ROOF MEMBRANE | | | | | 0 | | |
| PICAL ROOF | • L.P. -6" | DENOTES ELEVATION OF LOW POINT OF SLOPED STRUCTURAL STEEL; REFER TO ROOF NOTES | DENOTES LOCATION OF STRUCTURAL STEEL DUNNAGE, REFER TO ENGINEER'S DRAWINGS. | | | _ | | | _ | |
| | | FOR ELEVATION. REFER TO PLAN FOR TAPERED INSULATION | N.I.C. E.T.R. | | | В | | | | |
| | - | LAYOUT. DENOTES DIRECTION OF TAPERED INSULATION | DENOTES LOCATION OF DUNNAGE OPEN FLOOR GRATE & STAIR | | | | | | | |
| | </td <td>DENOTES DIRECTION OF SLOPE STEEL</td> <td>- DENOTES HANDRAIL AT PERIMETER OF FLOOR GRATE & STAIRS. SEE PLANS FOR LOCATIONS & REFER TORAIL DETAIL 4</td> <td>0</td> <td>48</td> <td>12 16</td> <td>24</td> <td>32</td> <td>4</td> <td>8 (ft)</td> | DENOTES DIRECTION OF SLOPE STEEL | - DENOTES HANDRAIL AT PERIMETER OF FLOOR GRATE & STAIRS. SEE PLANS FOR LOCATIONS & REFER TORAIL DETAIL 4 | 0 | 48 | 12 16 | 24 | 32 | 4 | 8 (ft) |

| D | 200 HIGH ST, BOSTON, MA, 02110 857.300.2610 SGA-ARCH.COM PROJECT TEAM: CLIENT TWO WELLS AVENUE, LLC 145 Rosemary Street Needham, MA, 02492 LANDSCAPE ARCHITECT RADNER DESIGN ASSOCIATES 945 Concord Street, Suite 100 Framingham, MA 01701 508.736.6144 STRUCTURAL ENGINEER THORNTON-TOMASSETTI GROUP 470 Atlantic Avenue, 4th Floor Boston, MA, 02110 617.273.8313 MEP/FP ENGINEERS WSP PARSONS BRINCKERHOFF 88 Black Falcon Avenue, Suite 210 Boston, MA, 02110 617.210.1600 CIVIL ENGINEER NITSCH ENGINEERING 2 Contor Plaza, Suite 420 |
|---|--|
| C | 2 Center Plaza, Suite 430 Boston, MA 02108 857-206-8737 |
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| | REVISIONS: No. Date Description |
| | SCALE As indicated DATE ISSUED 11/04/15 PROJECT NO DRAWN BY CHECKED BY DR SHEET TITLE: Roof Construction Partial Plan - Wing B A-104b |

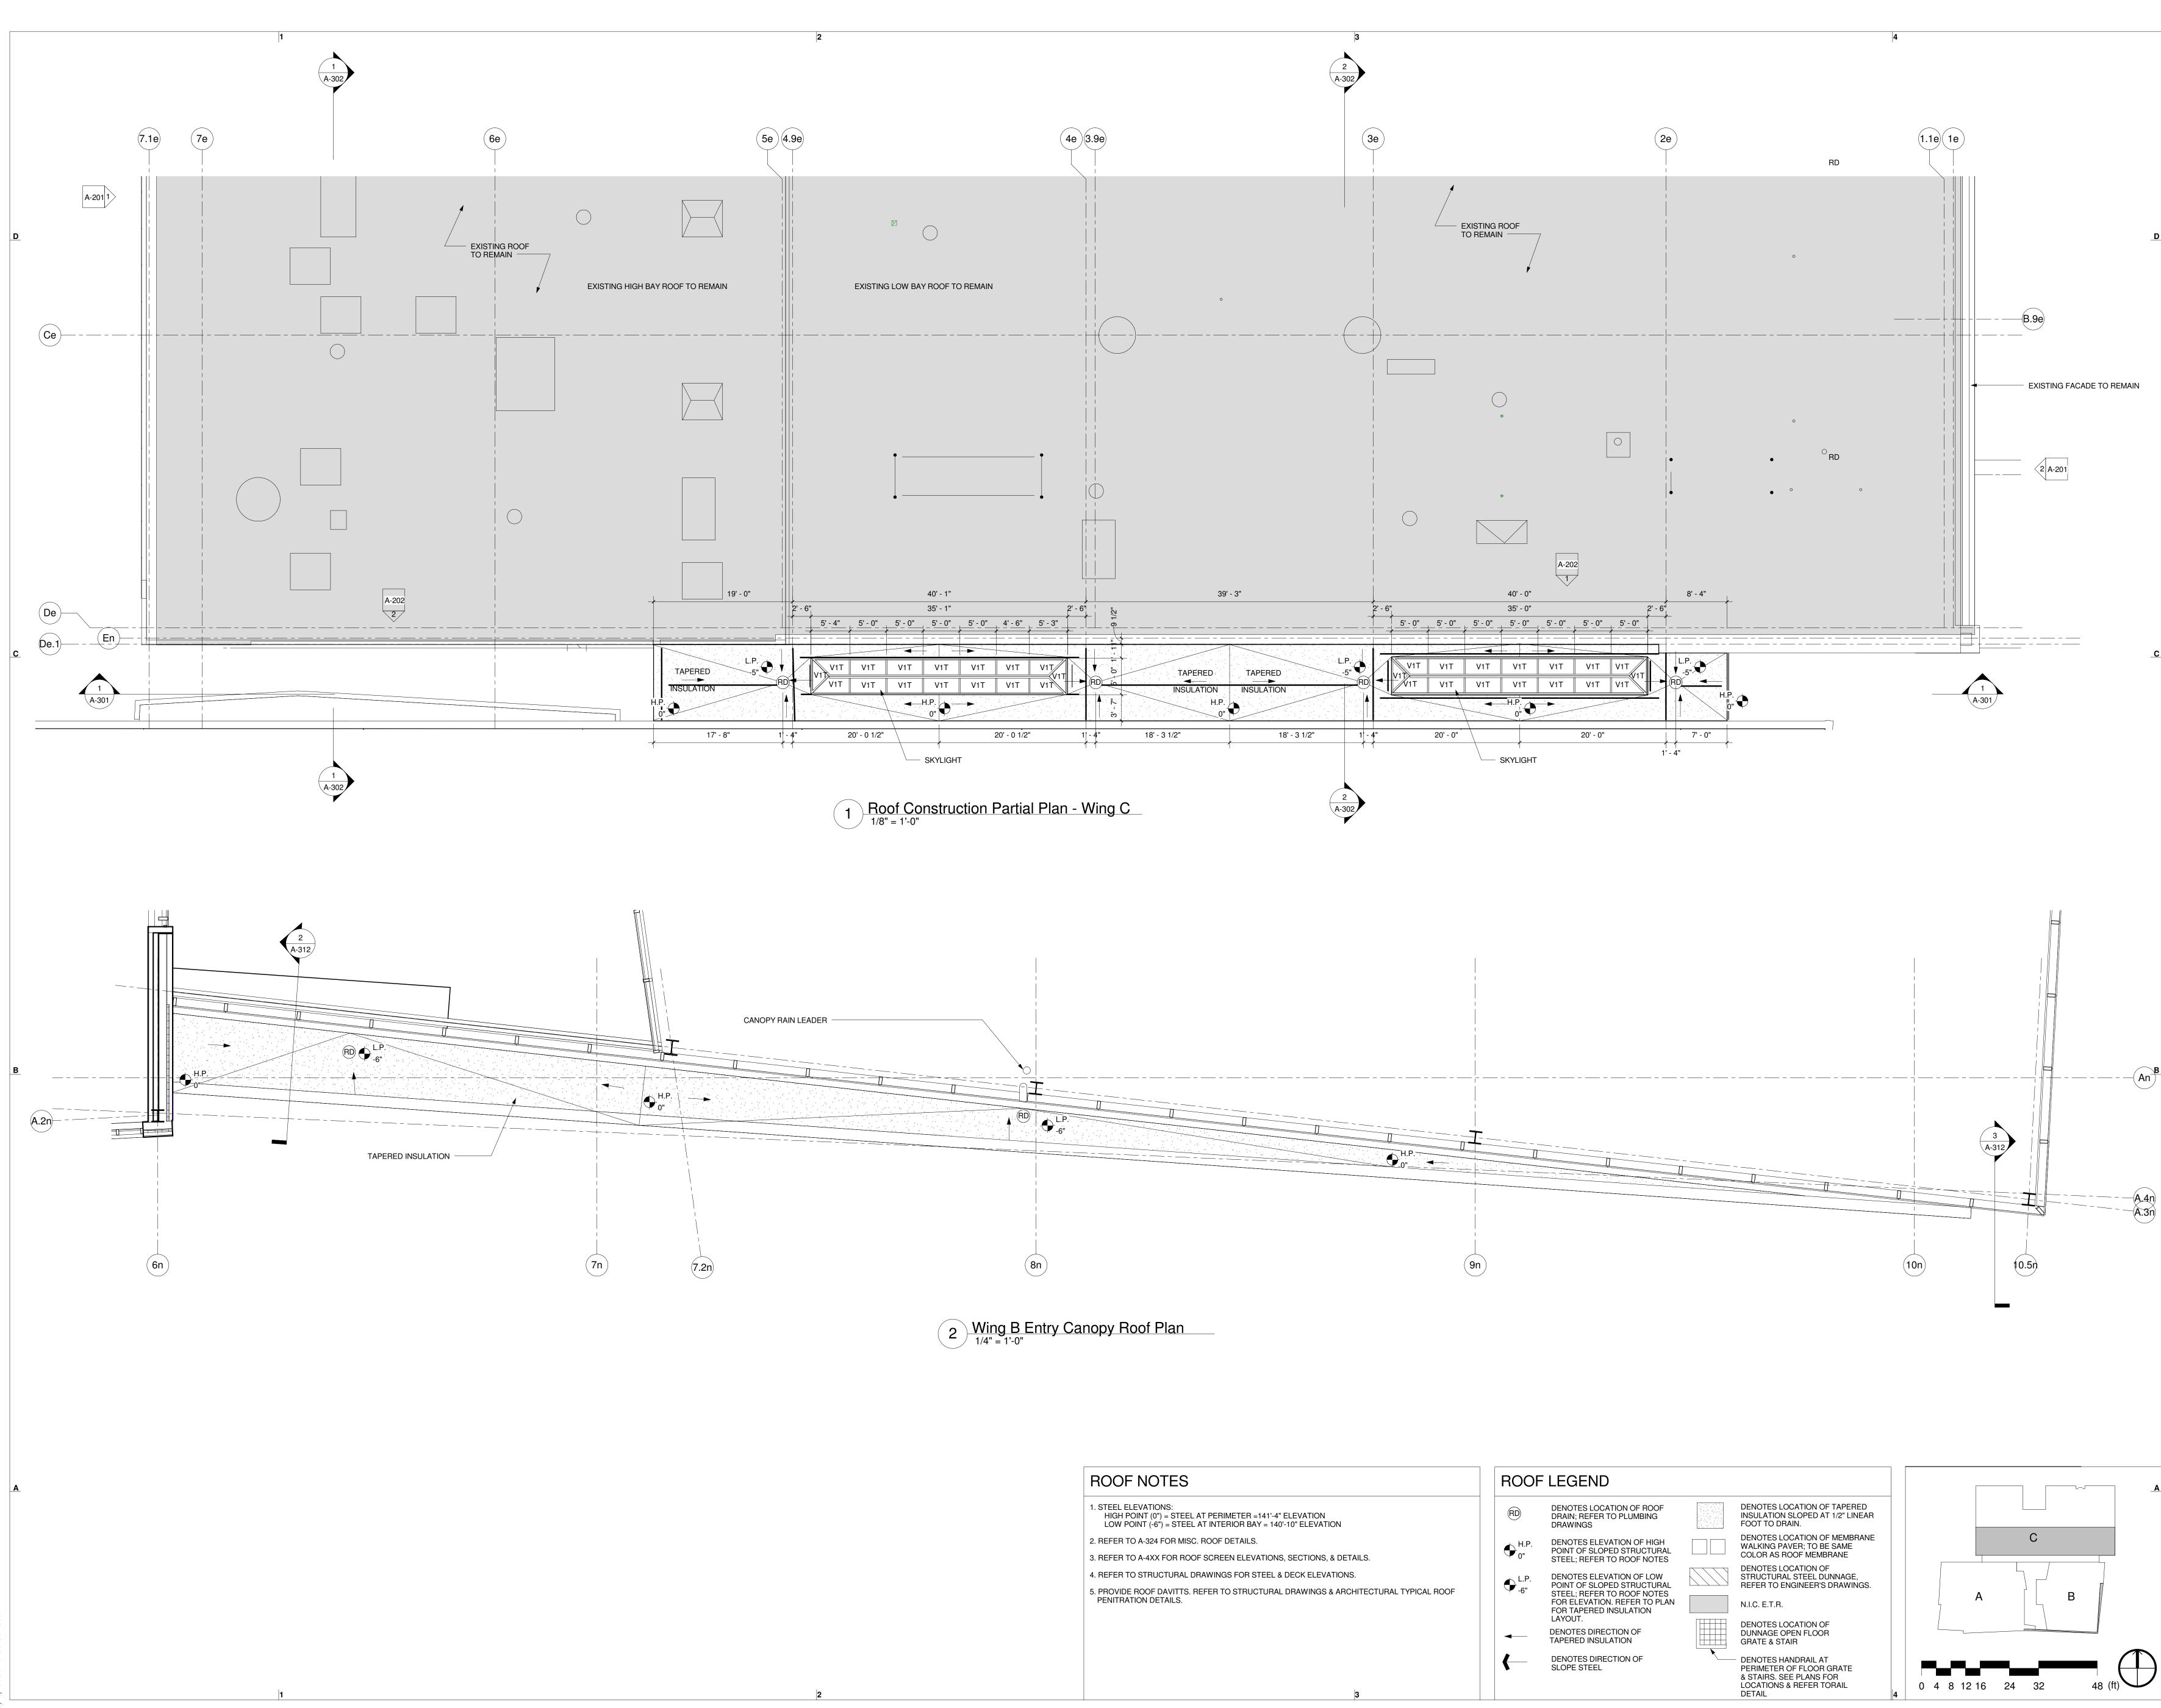



200 HIGH ST, BOSTON, MA, 02110 857.300.2610 | SGA-ARCH.COM PROJECT TEAM: CLIENT TWO WELLS AVENUE, LLC 145 Rosemary Street Needham, MA, 02492 LANDSCAPE ARCHITECT RADNER DESIGN ASSOCIATES 945 Concord Street, Suite 100 Framingham, MA 01701 508.736.6144 STRUCTURAL ENGINEER THORNTON-TOMASSETTI GROUP 470 Atlantic Avenue, 4th Floor Boston, MA, 02110 617.273.8313 MEP/FP ENGINEERS WSP | PARSONS BRINCKERHOFF 88 Black Falcon Avenue, Suite 210 Boston, MA, 02110 617.210.1600 CIVIL ENGINEER NITSCH ENGINEERING 2 Center Plaza, Suite 430 Boston, MA 02108 857-206-8737 SEAL / SIGNATURE Design Development Not for Construction C Spagnolo Gisness & Associates, Inc. 11/04/15 PROJECT: Two Wells Ave Two Wells Ave, Newton, MA 02458 **REVISIONS:** No. Date Description SUBMISSIONS: DateIssued For:09/10/15Schematic Design11/04/15Design Development SCALE As indicated DATE ISSUED 11/04/15 PROJECT NO 003751.00 DRAWN BY TS CHECKED BY **DR** SHEET TITLE: Roof Construction Plan - Wing C A-105

SUBSEQUENTLY CAULKED WITH GENERAL PURPOSE SEALANT. 2. WOOD NAILER MUST EXTEND BEYOND METAL FLANGE IN ALL DIRECTIONS. 3. HOT DIPPED GALVANIZED NAILS 1-1/4" LONG WITH 3/8" DIA. HEAD (MIN.). NAILING OFF THE MEMBRANE IS NOT REQUIRED IF MEMBRANE EXTENDS OVER THE

TOP OF THE CURB. 4. 3" (MIN.) FORMFLASH OR 6" EPDM LAP SPLICE.


EPDM WASHERS MUST BE USED AND

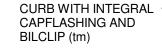

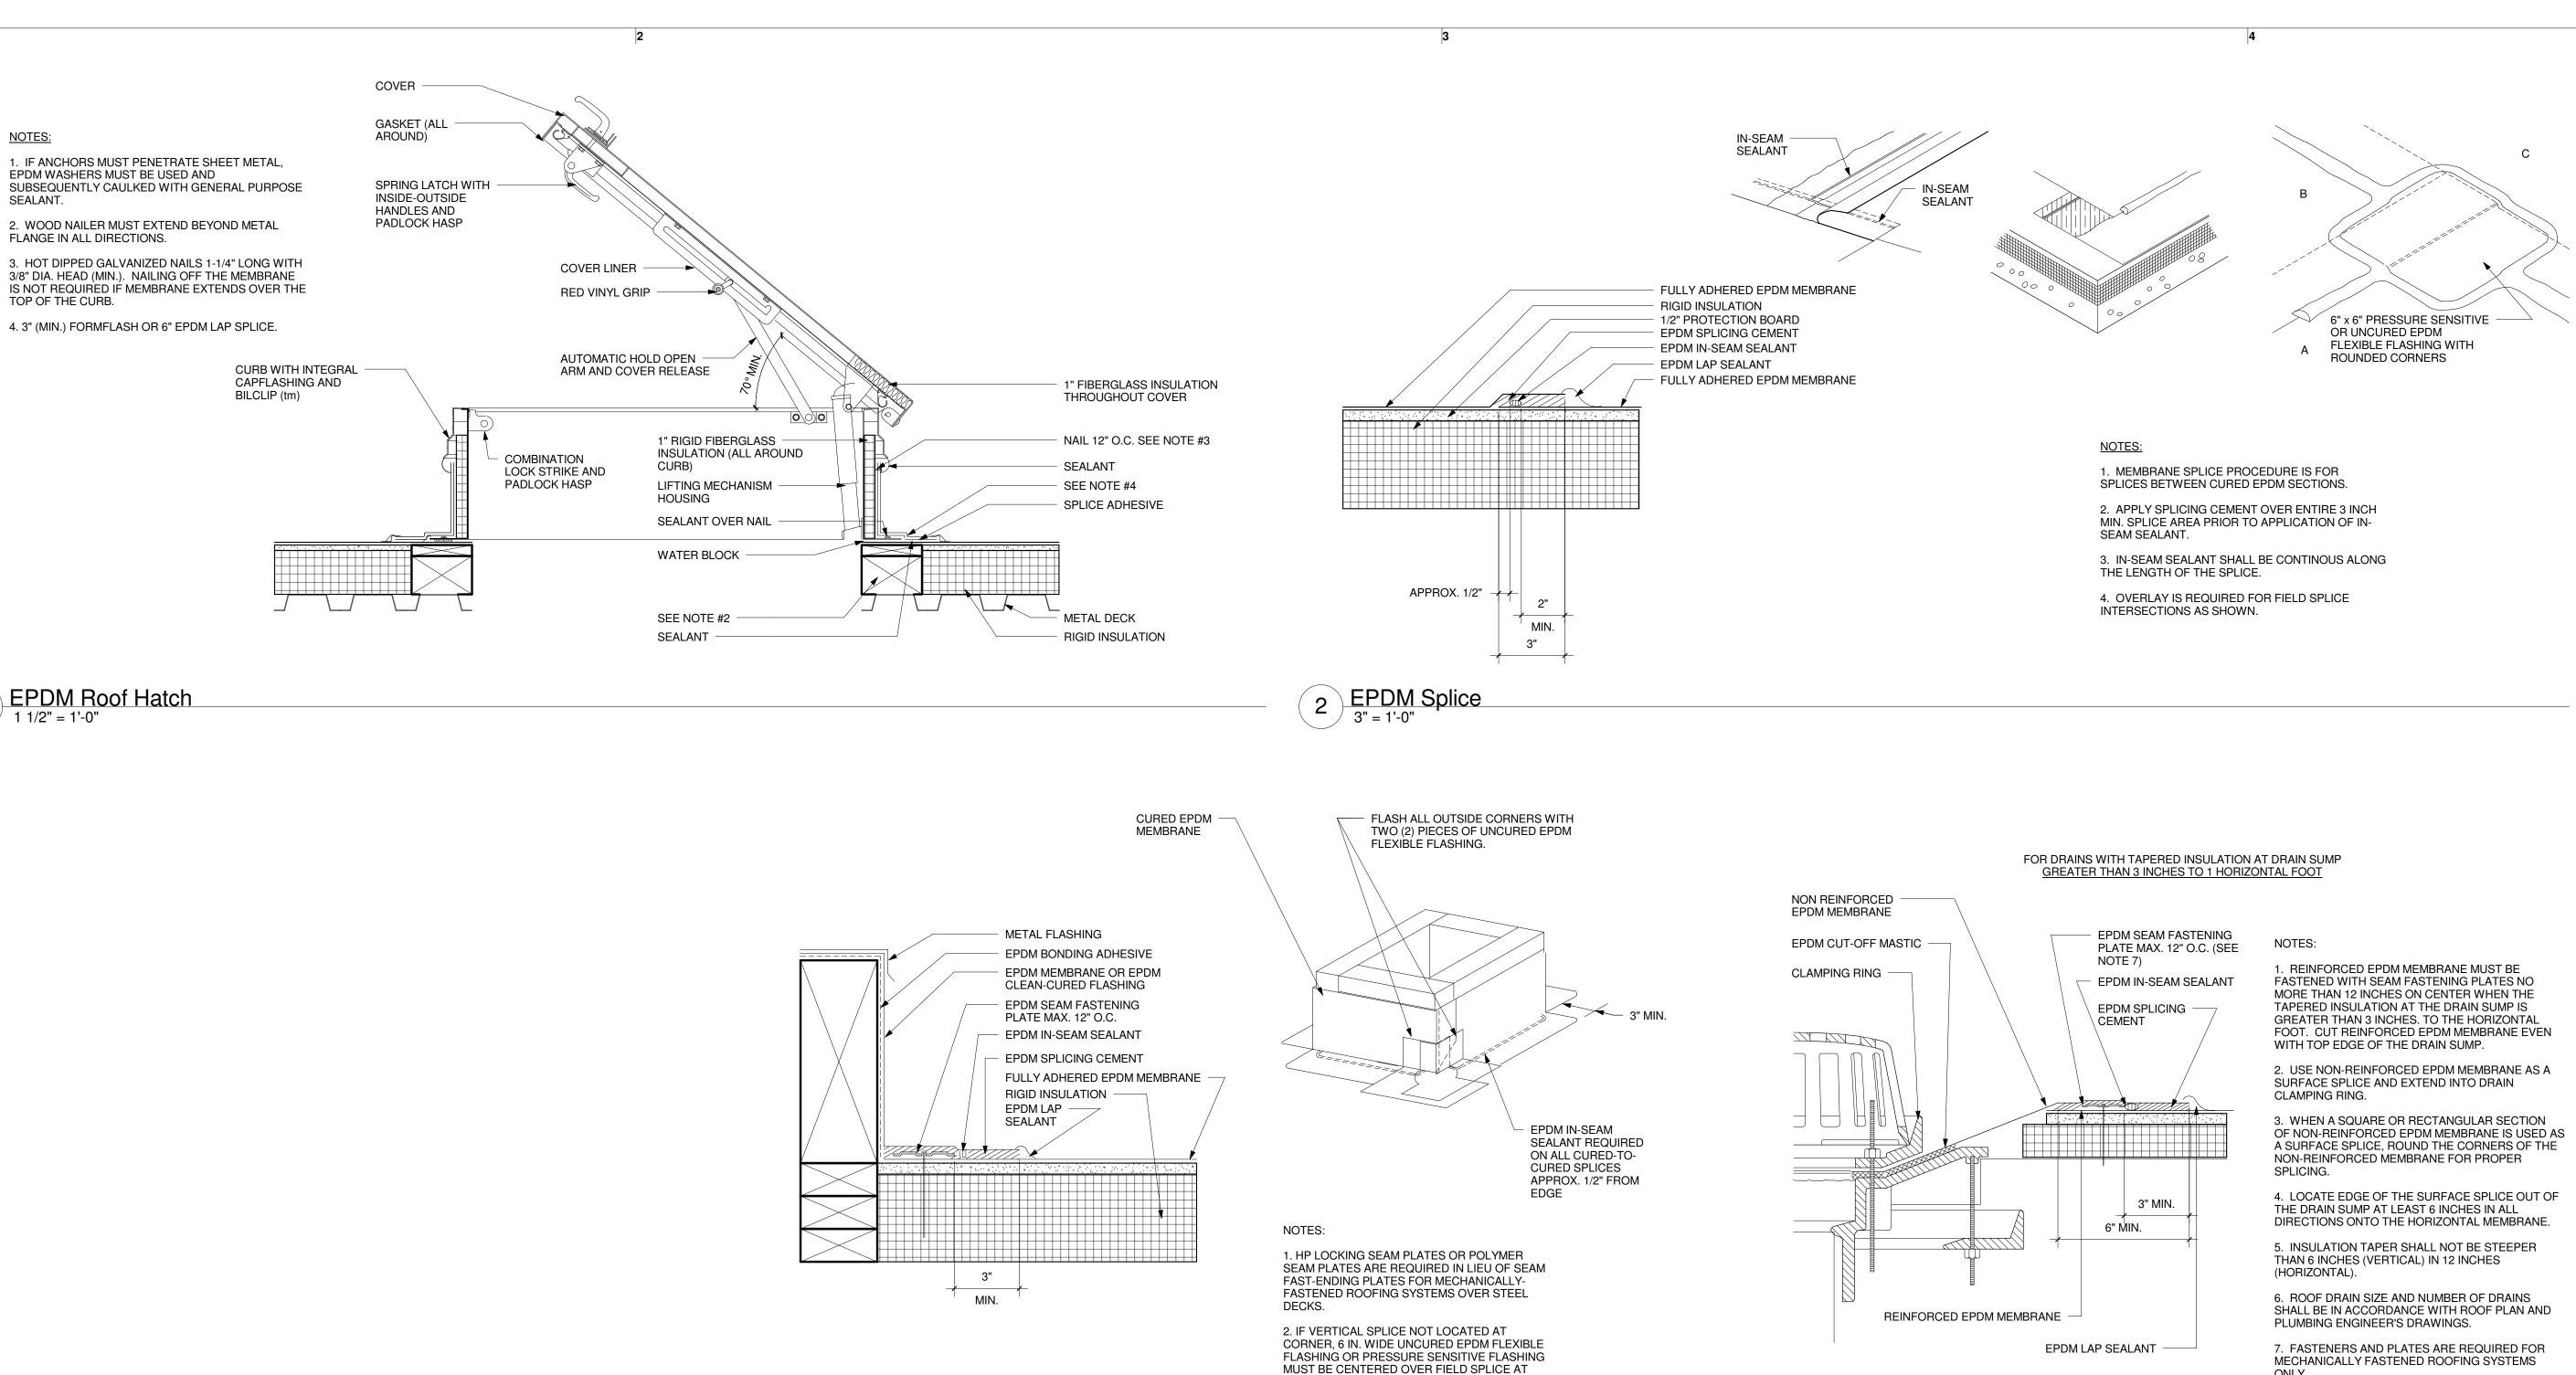




NOTES:

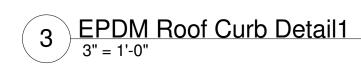


ANGLE CHANGE.


ONLY.


4 EPDM Roof Drain Detail 3" = 1'-0"

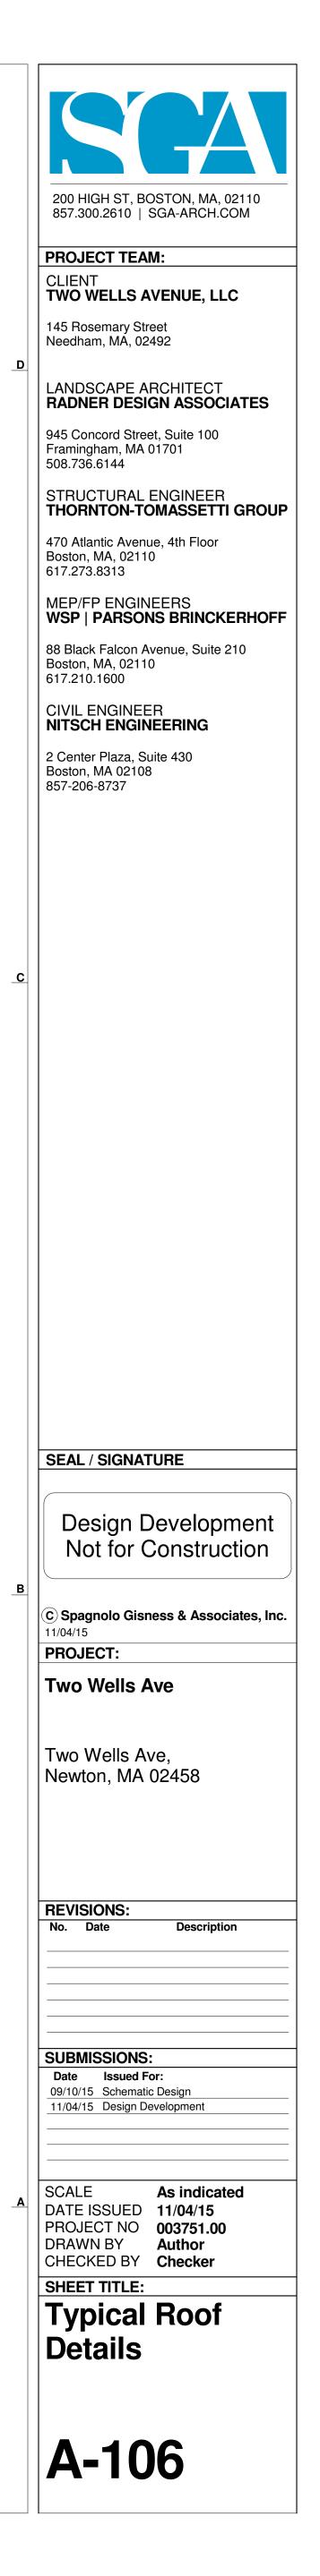

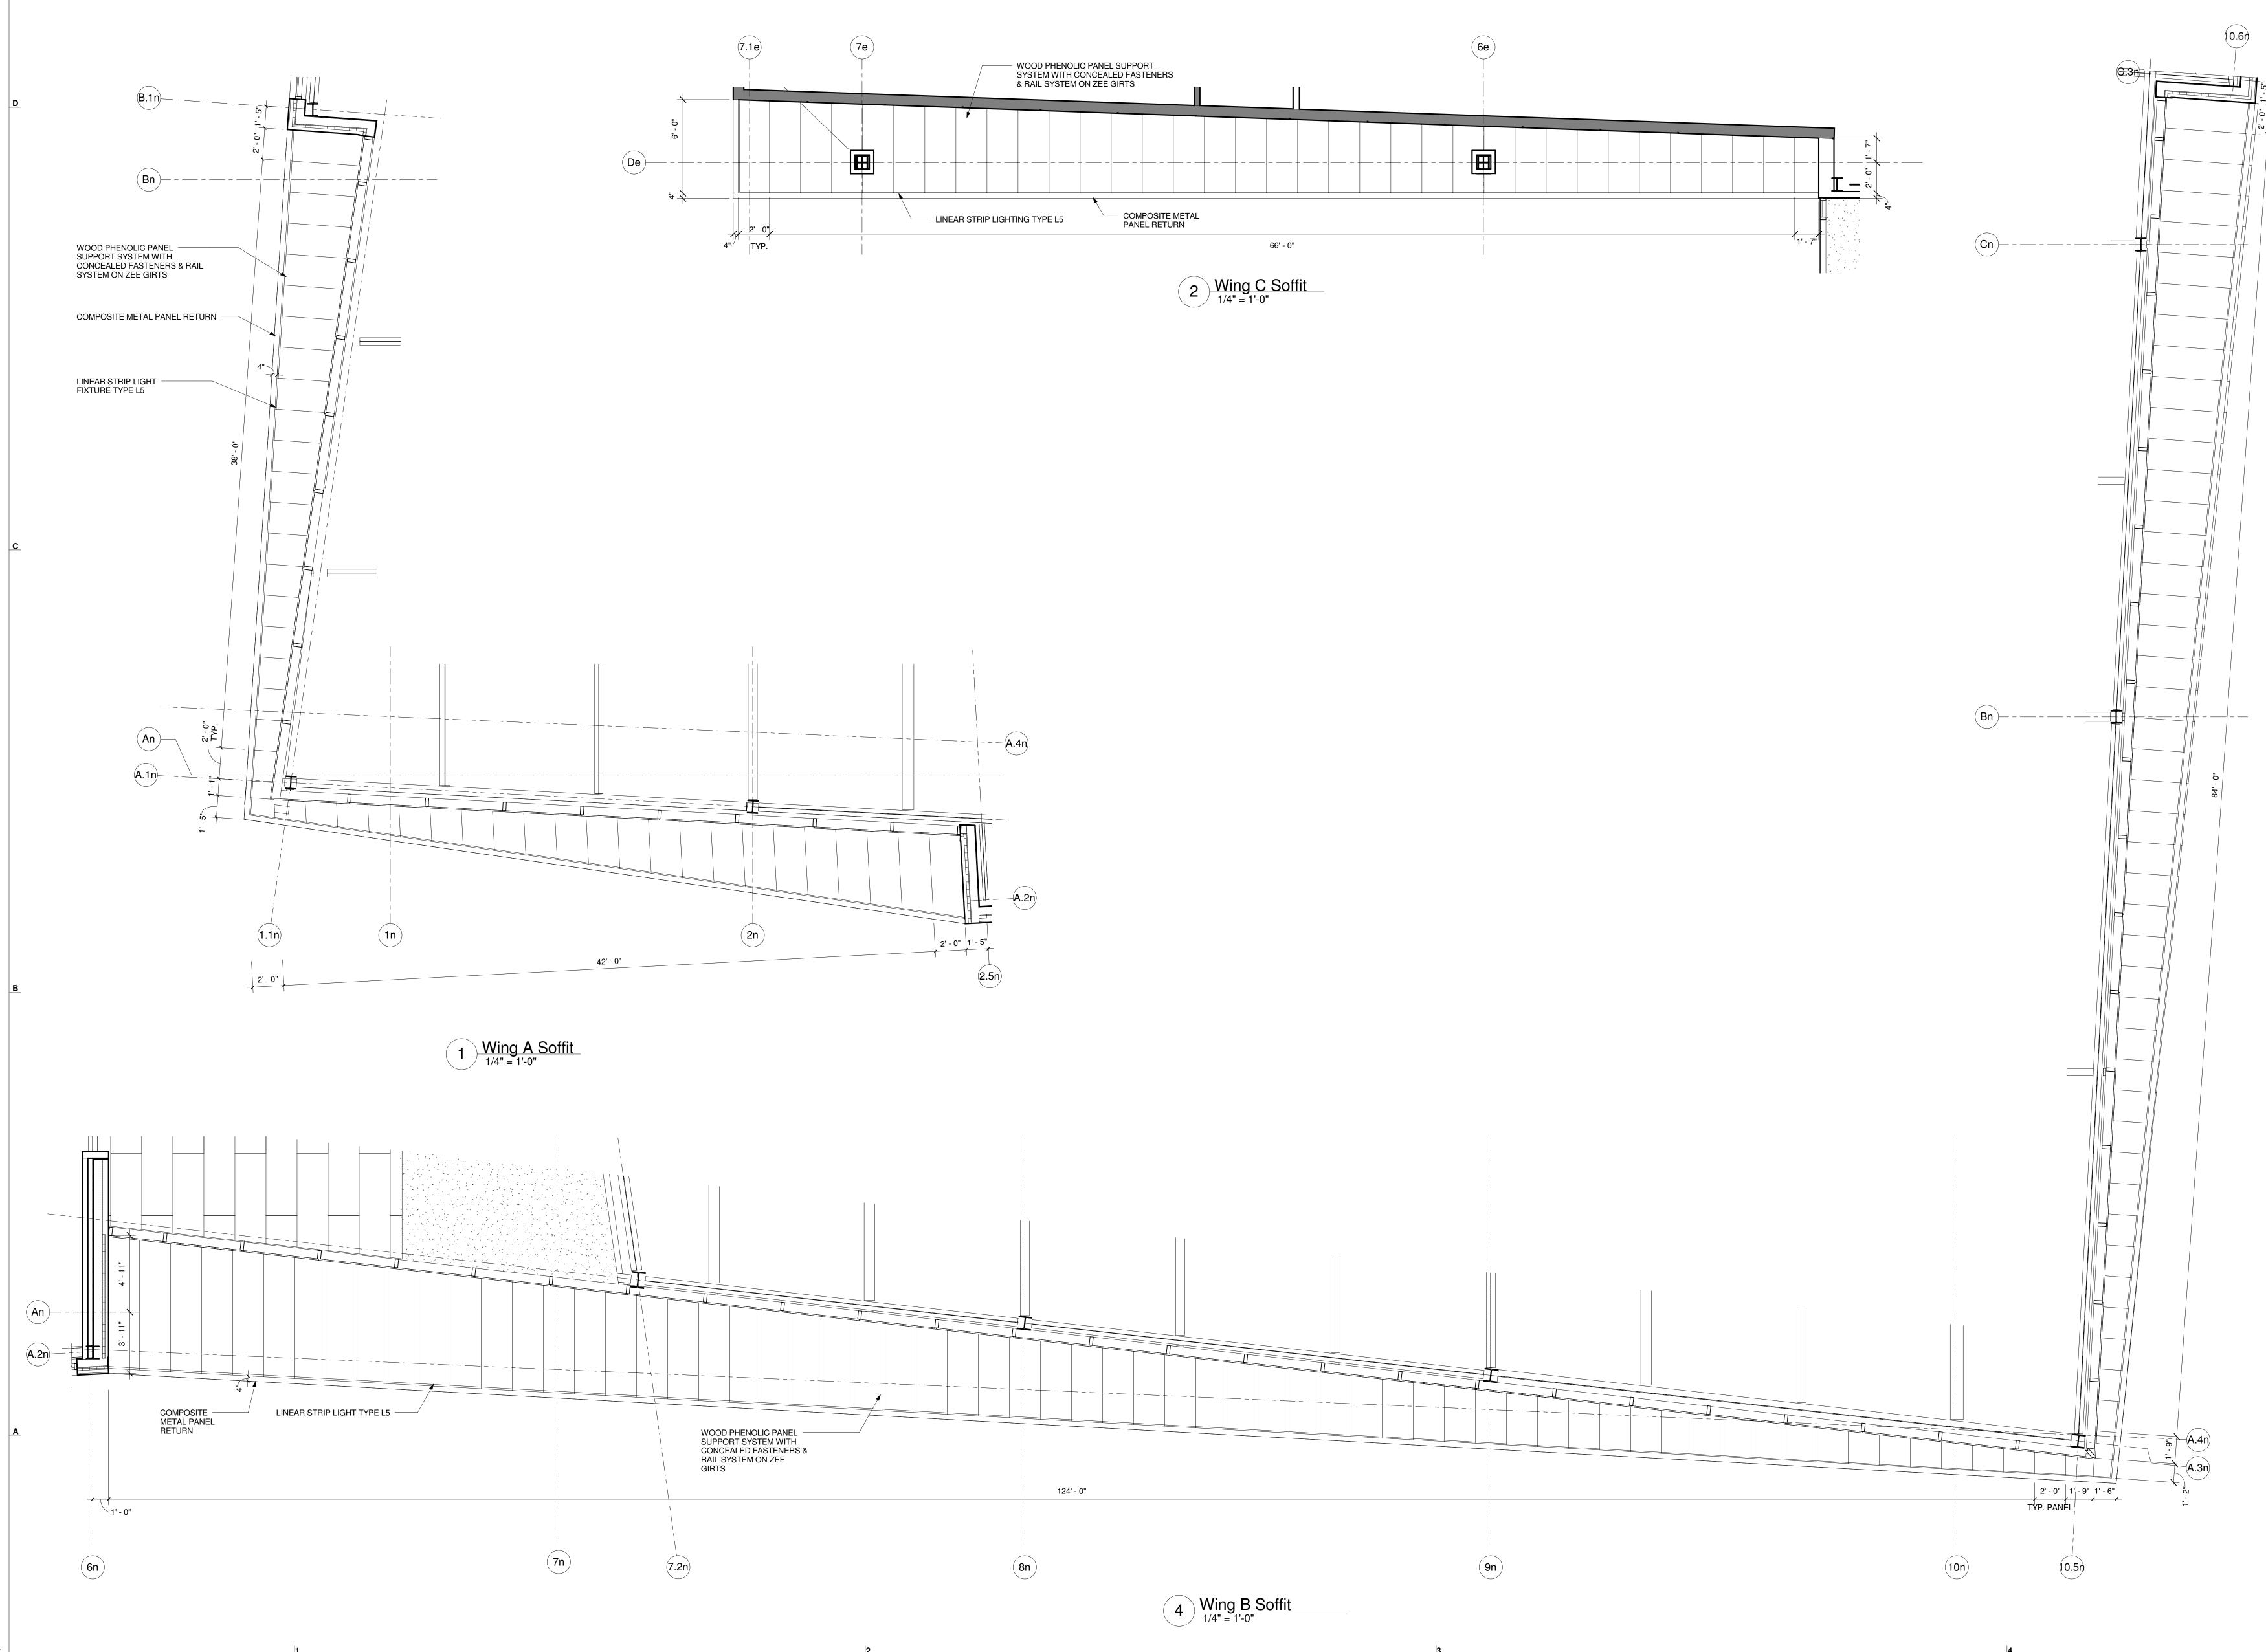

11/4/2015 8

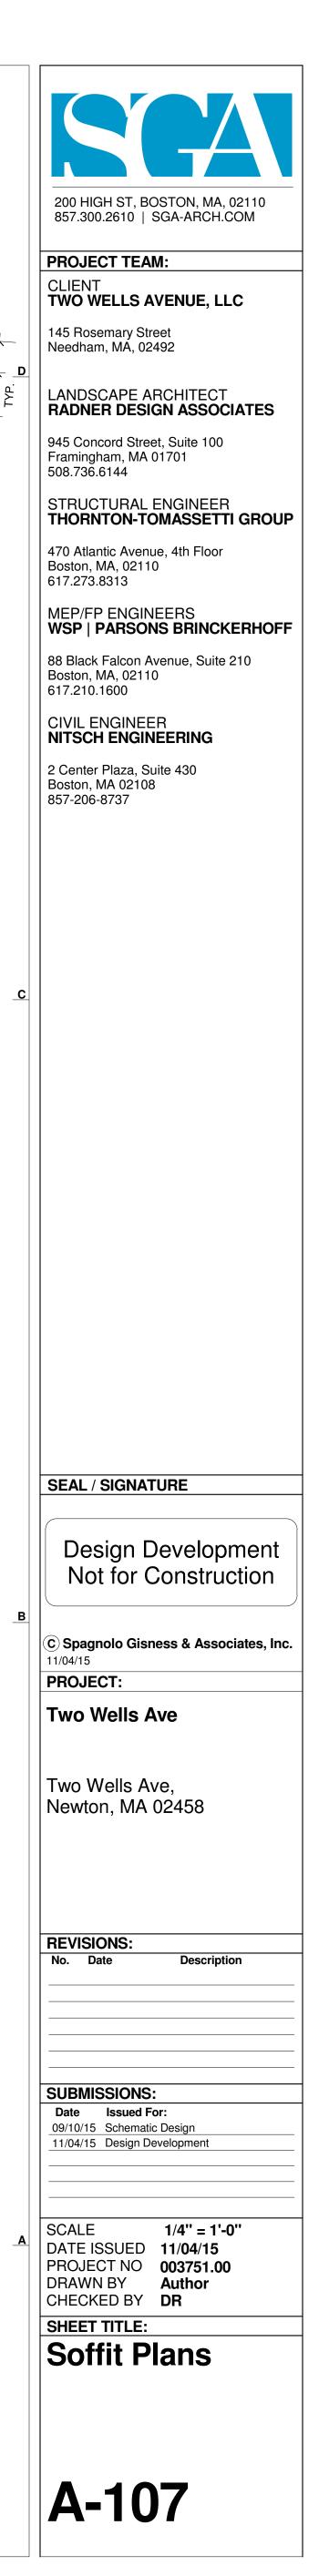

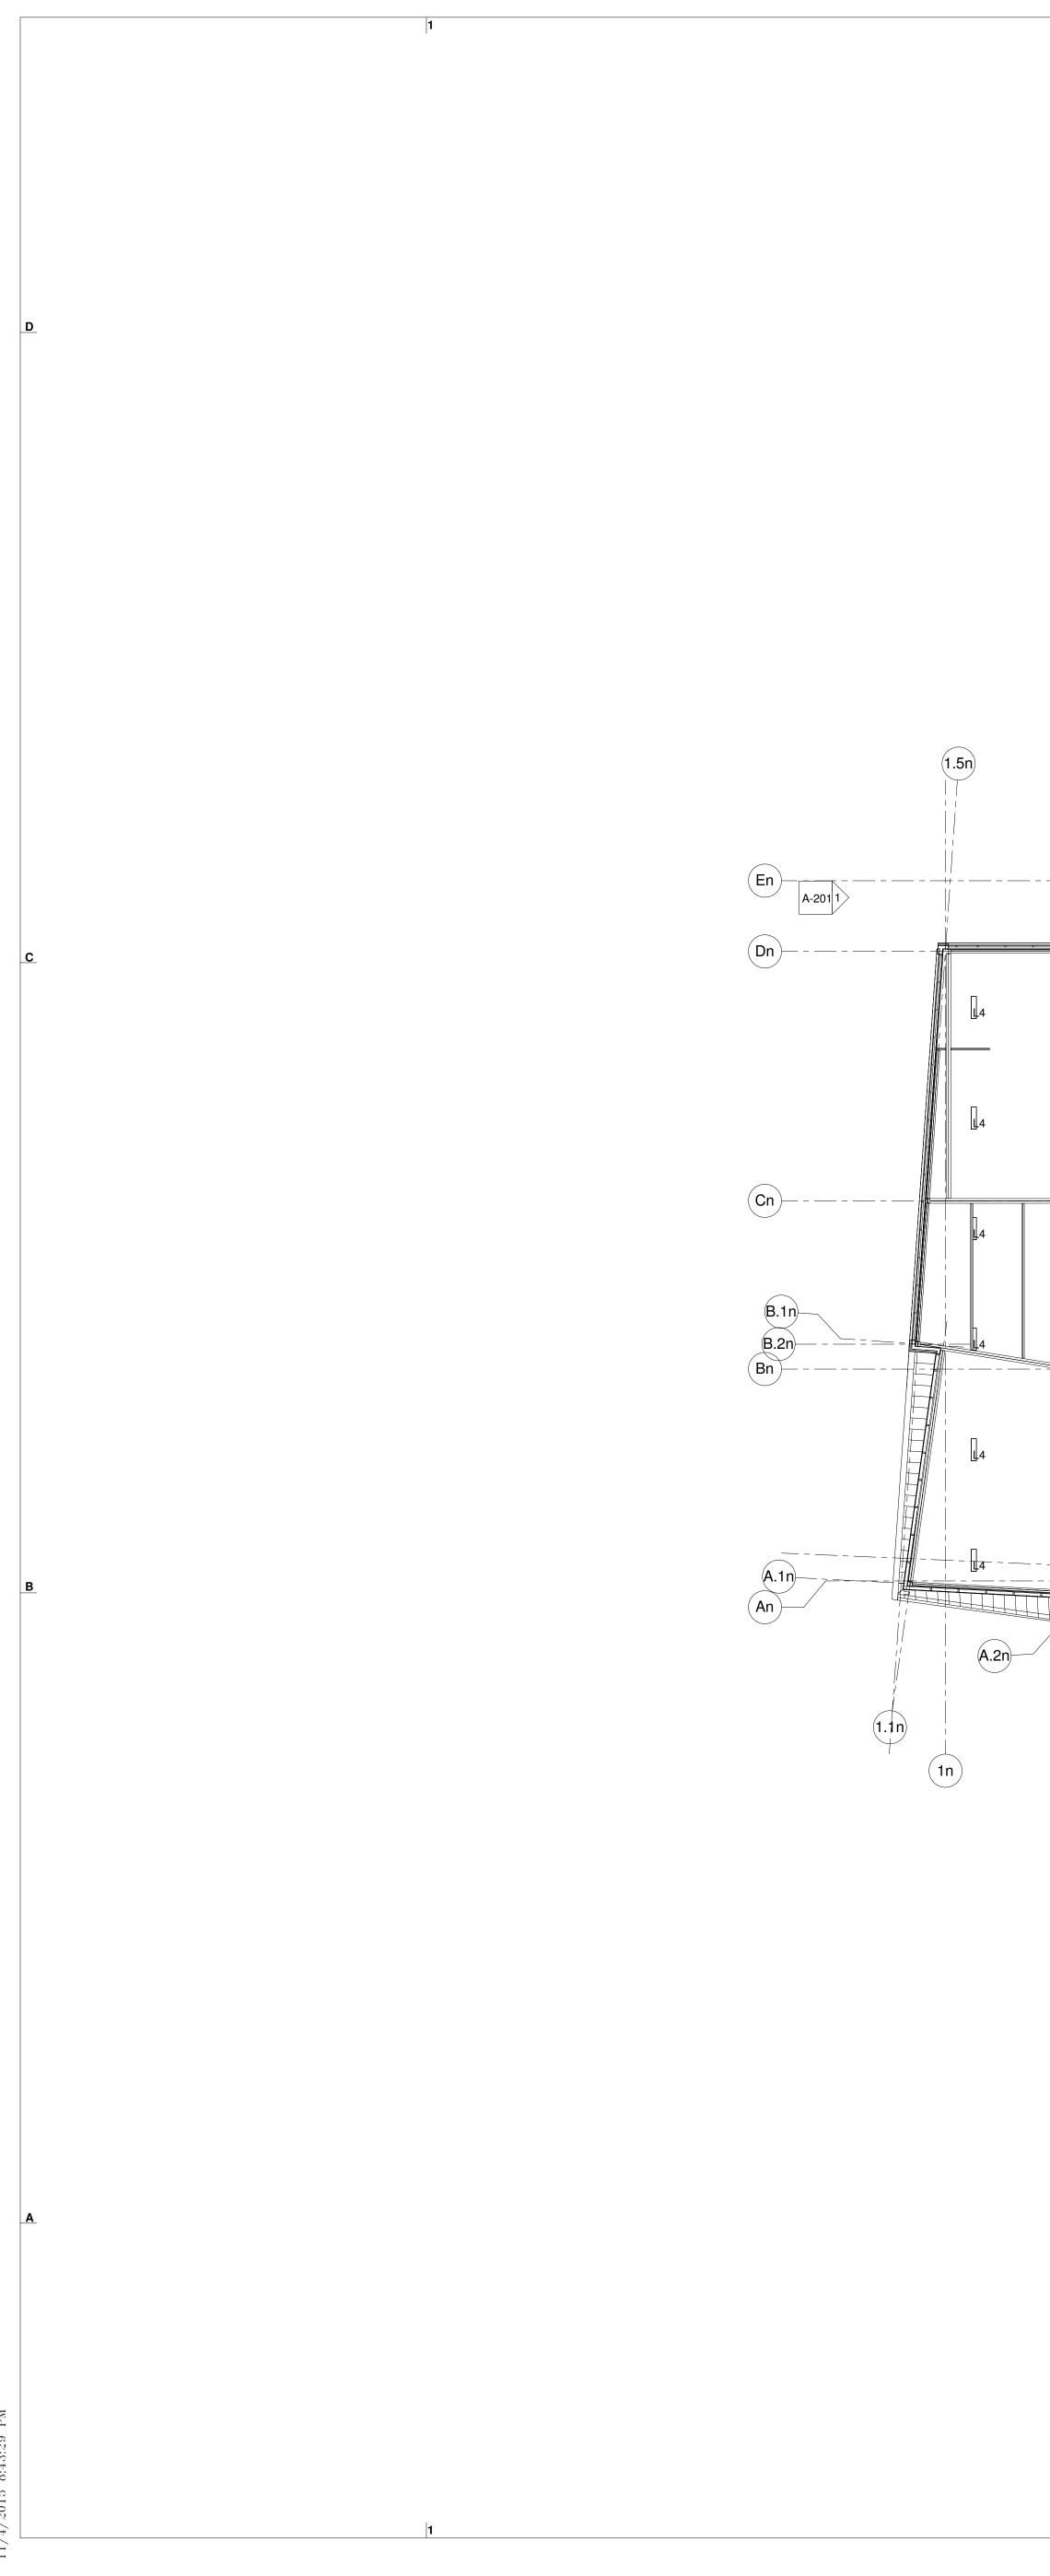



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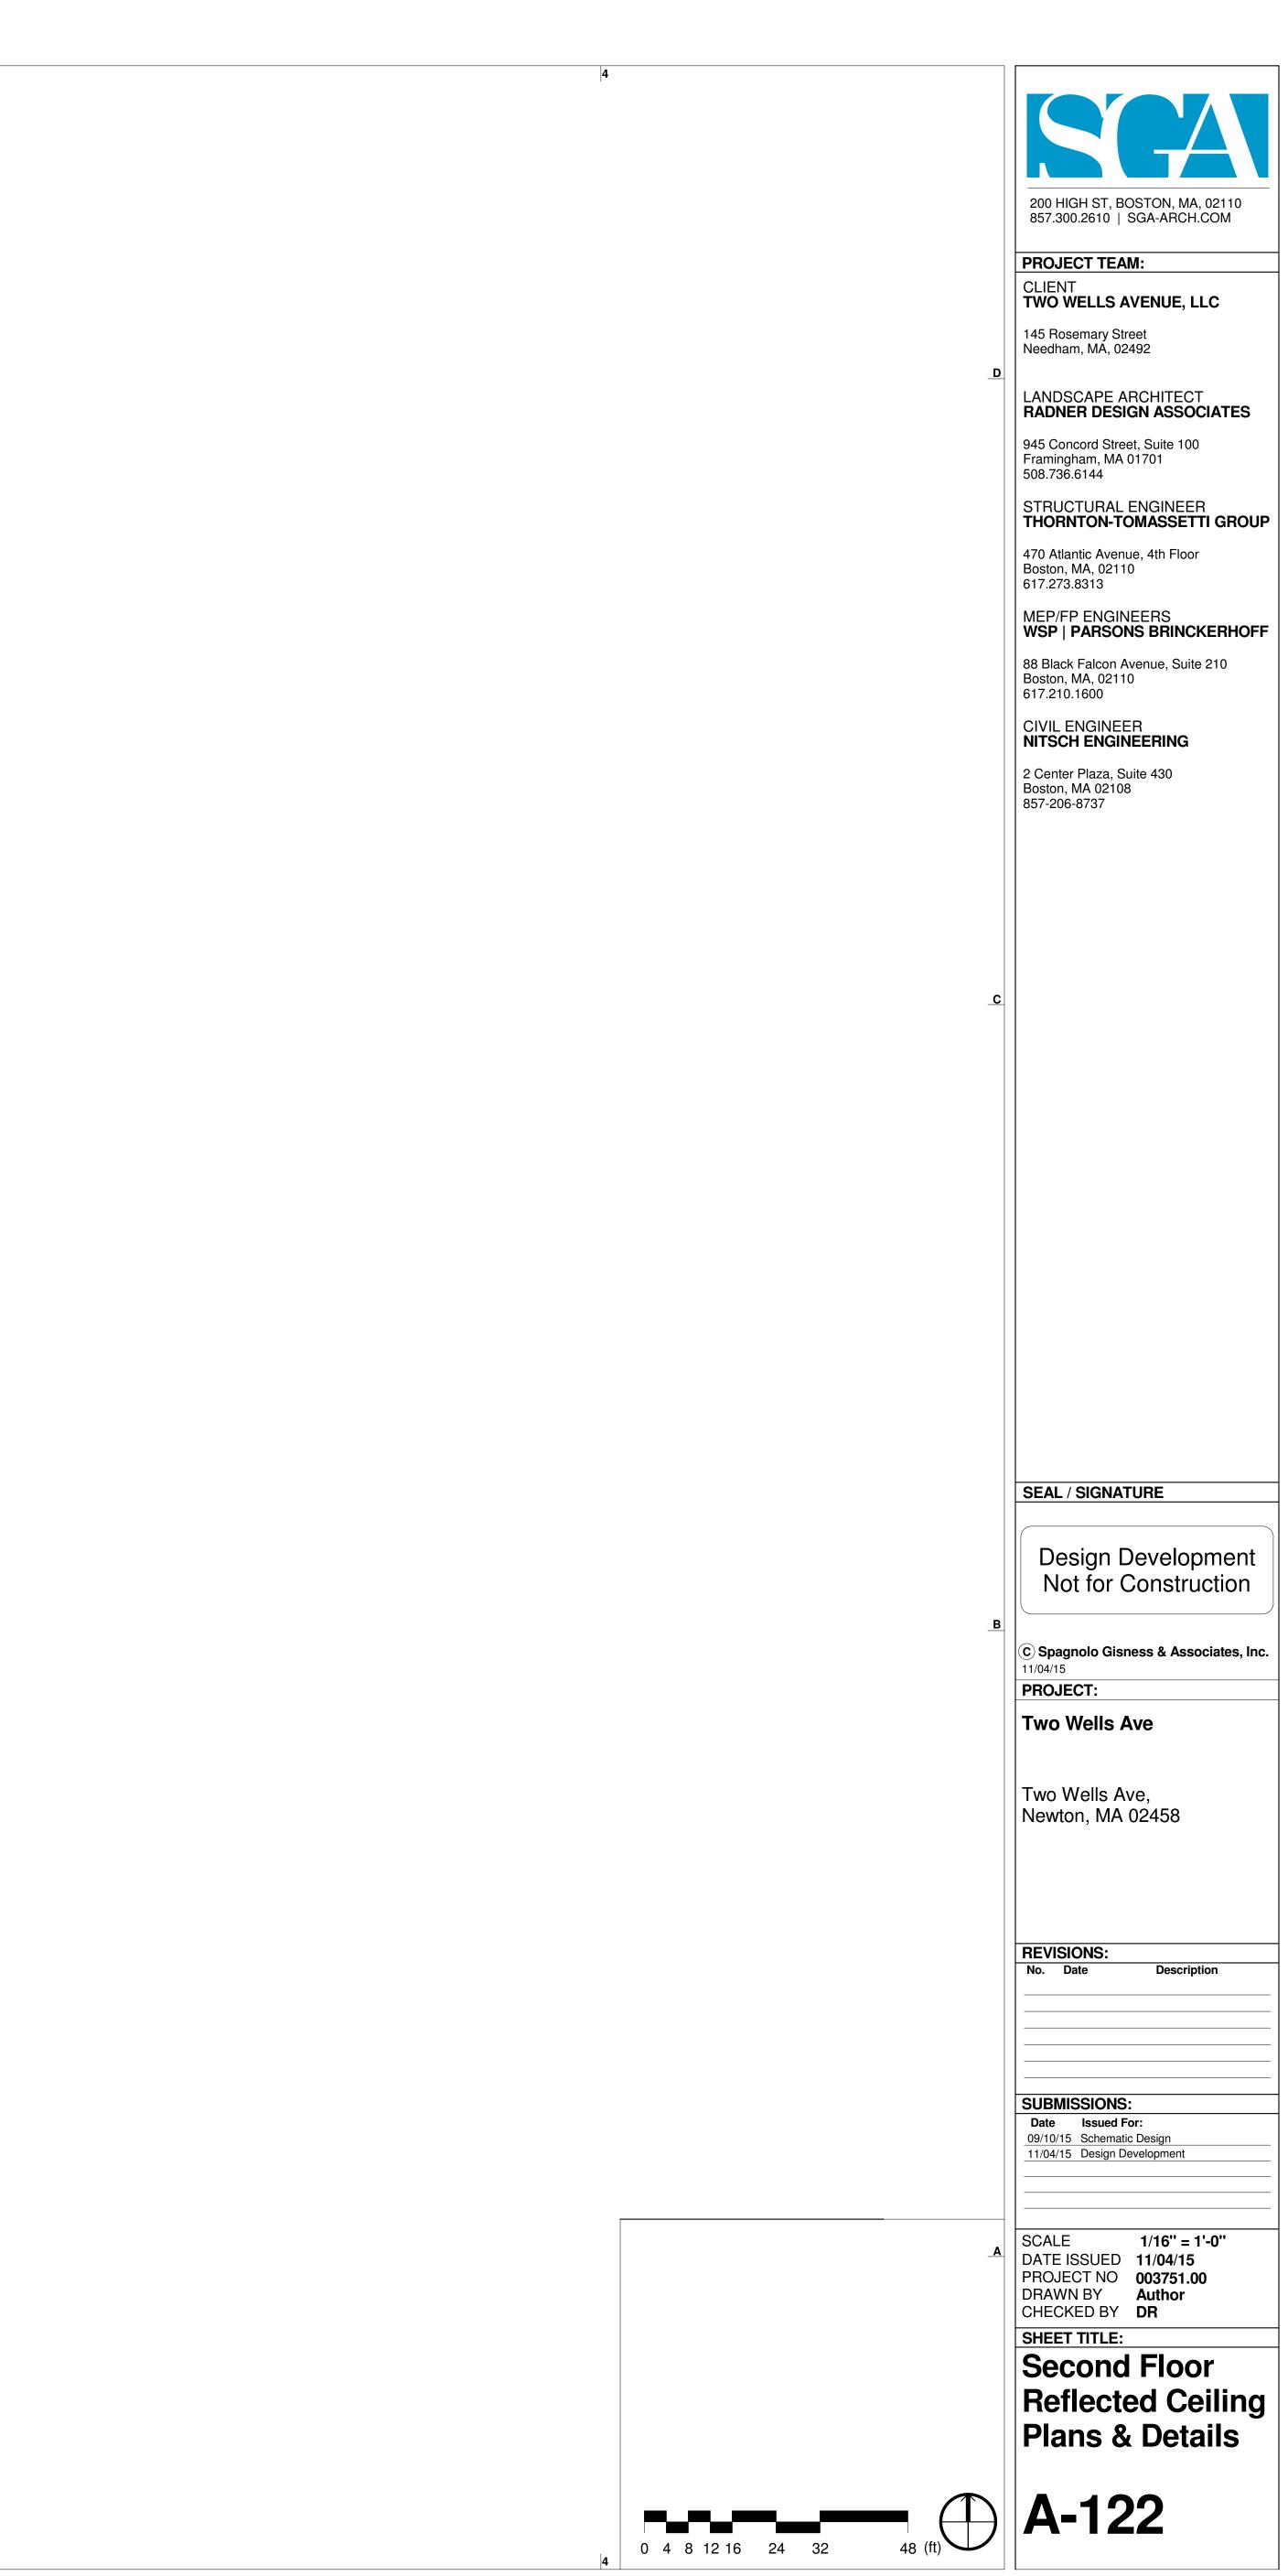
| <u> </u> | | <u> </u> | | <u> </u> | | | c 1b 1c 12 12 1 1c 12 13 2 13 1 1c 12 13 2 13 1 2 1 2 1 2 1 2 1 2 1 2 1 2 1 2 | 12 12 12 12 12 12 1312 12 12 12 12 12 | | <u>, L2 , L</u> |
|---------------------------|--------|----------|----|----------|--|---|--|---|----------|-----------------|
| 4 | 4 | 4 | | 4 | 4 | 4 | | | | |
| | | 4 | | | 12 12 12 12 12 12 12 12 12 12 | L2 L2 L2 L2 L2 L2 L2 L2 L2 L2 L2 L2 L2 L2 L2 L | | | | |
| | 4 | 4 | | 4 | 4 | | $ b - _{1c} _{1b} - _{1c} _{1c} _{1b} - _{1c} _{1c} _{1b} - _{1c} _{1c} $ | 2 ↓ 2 ↓ | 4 | |
| | | 4 | | | 4 | | $\begin{array}{c c c c c c c c c c c c c c c c c c c $ | | | |
| 2n | (2.5n) | n) | 4n | A-203 | | 6n | (| 7.2n | 8n | 2 A-20 |





A SCALE 1/16 DATE ISSUED 11/04 PROJECT NO 0037: DRAWN BY Author CHECKED BY DR SHEET TITLE: First Floor Reflected C Plans & Dei A A-121




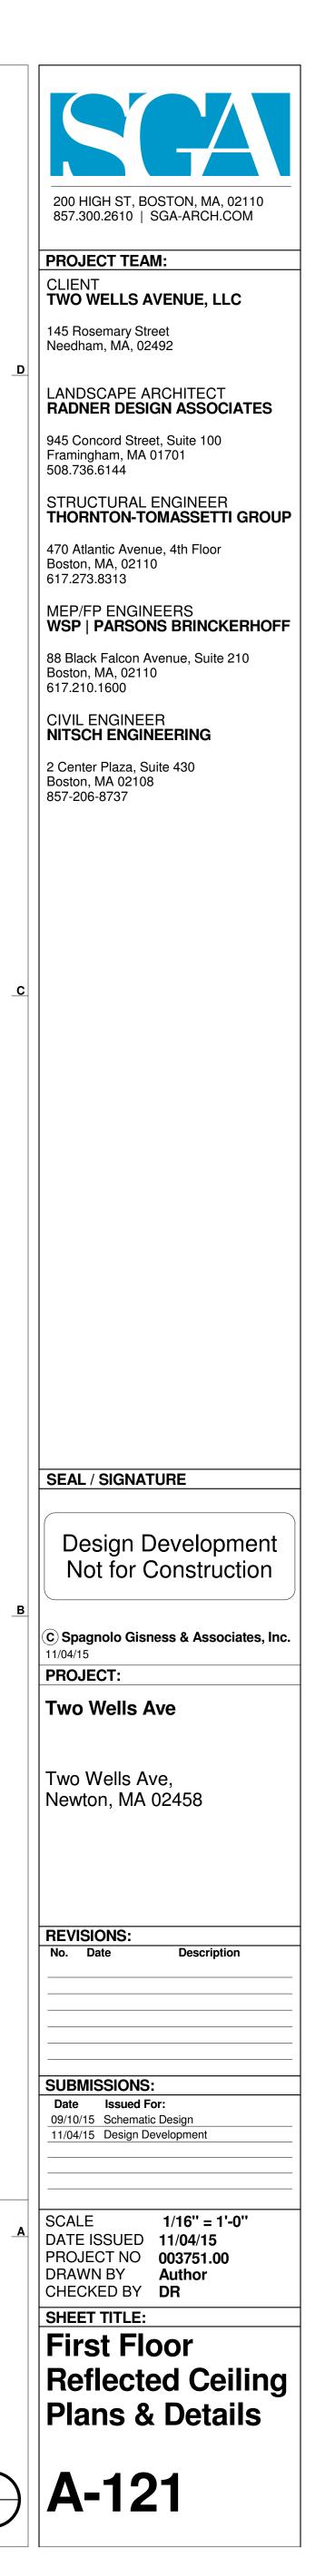

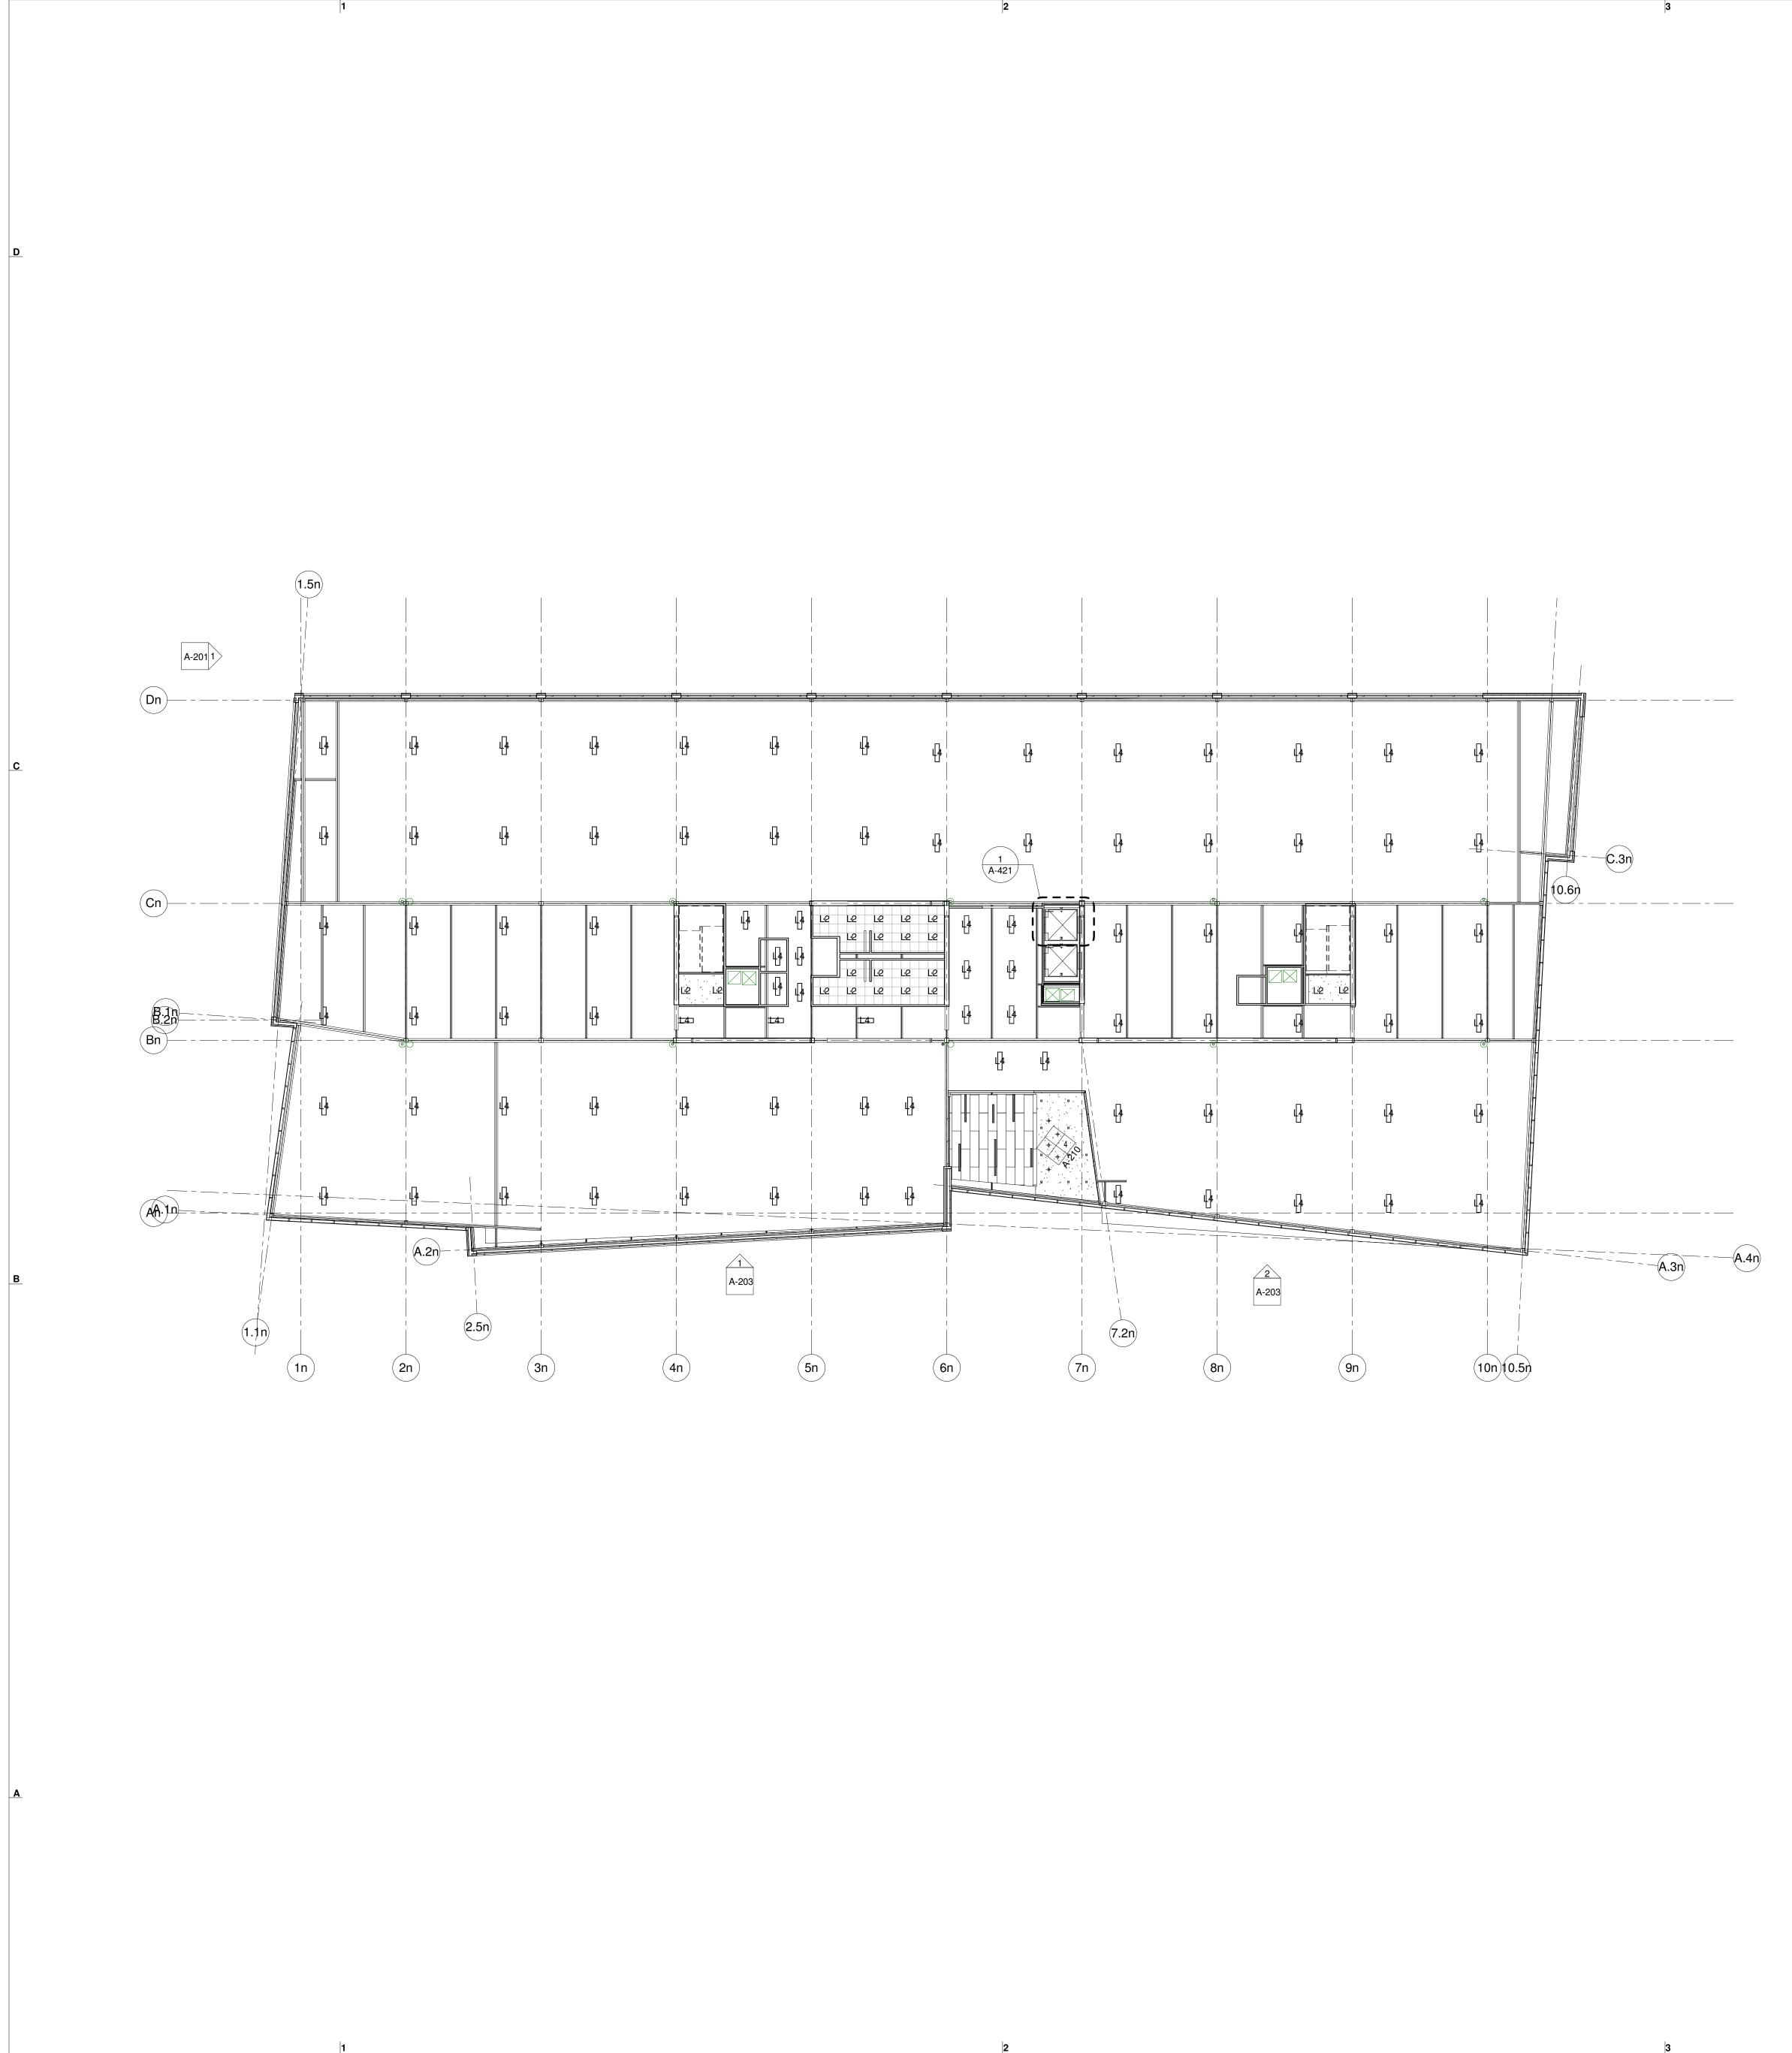


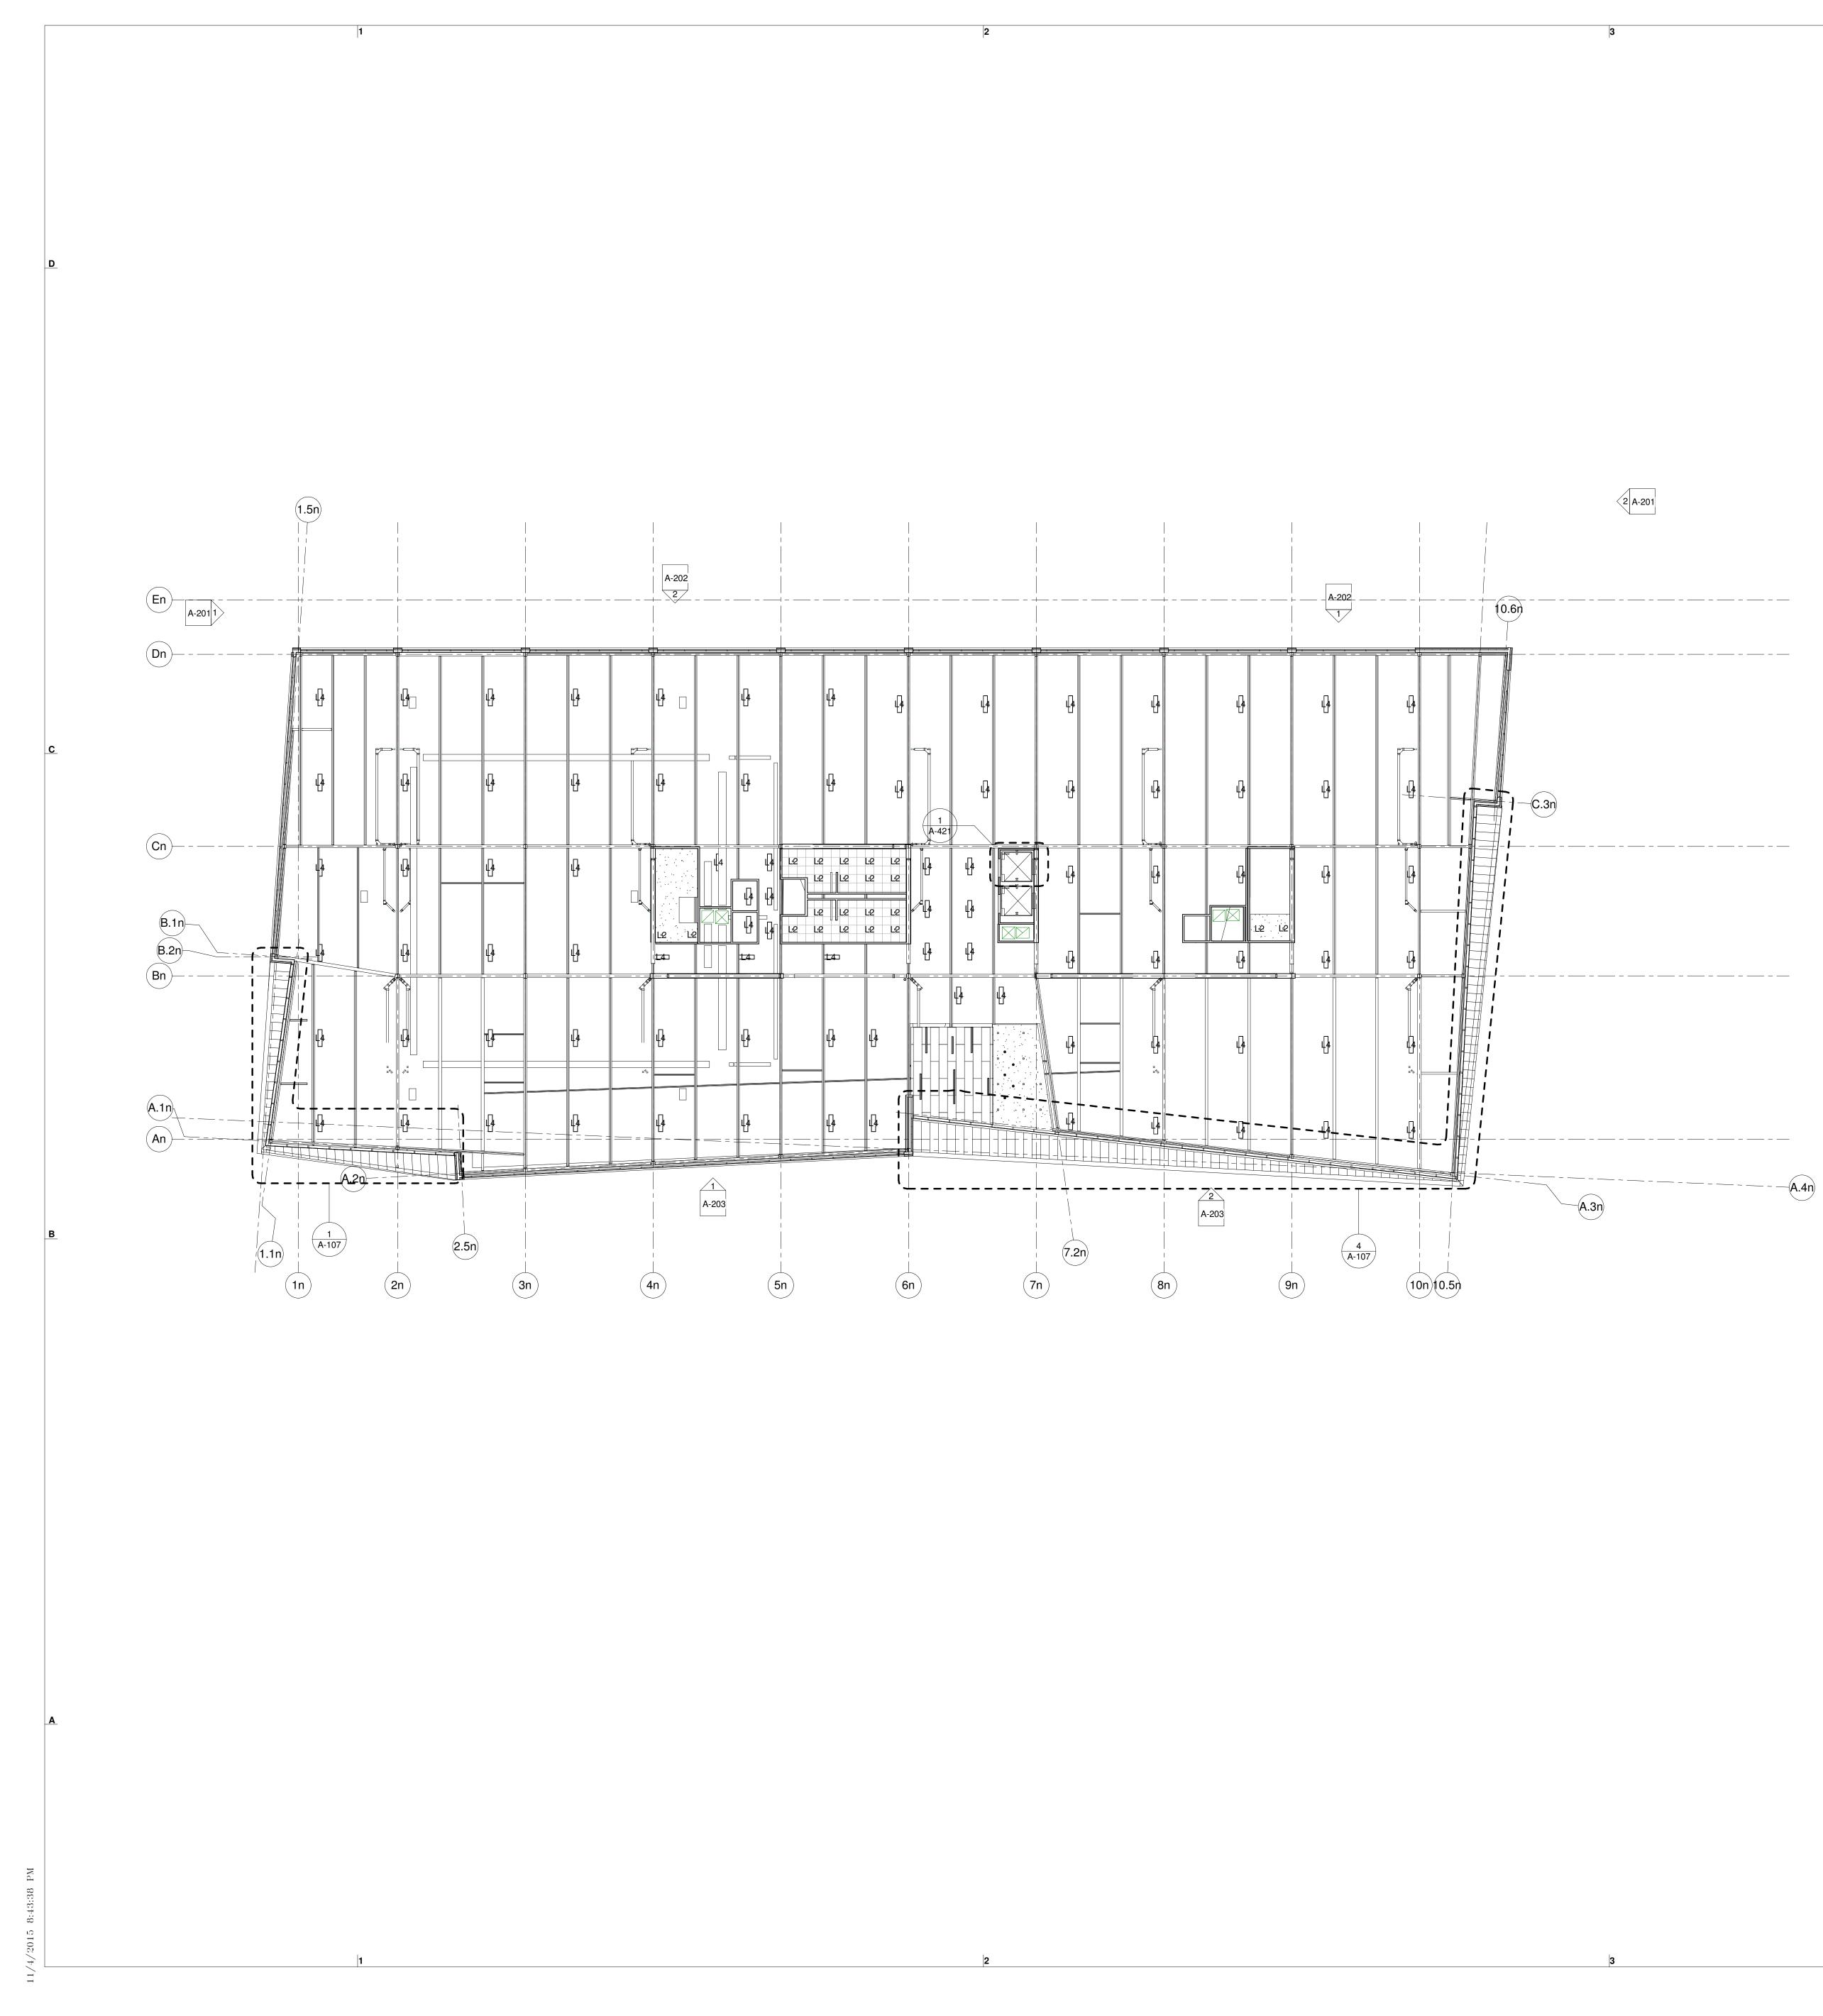

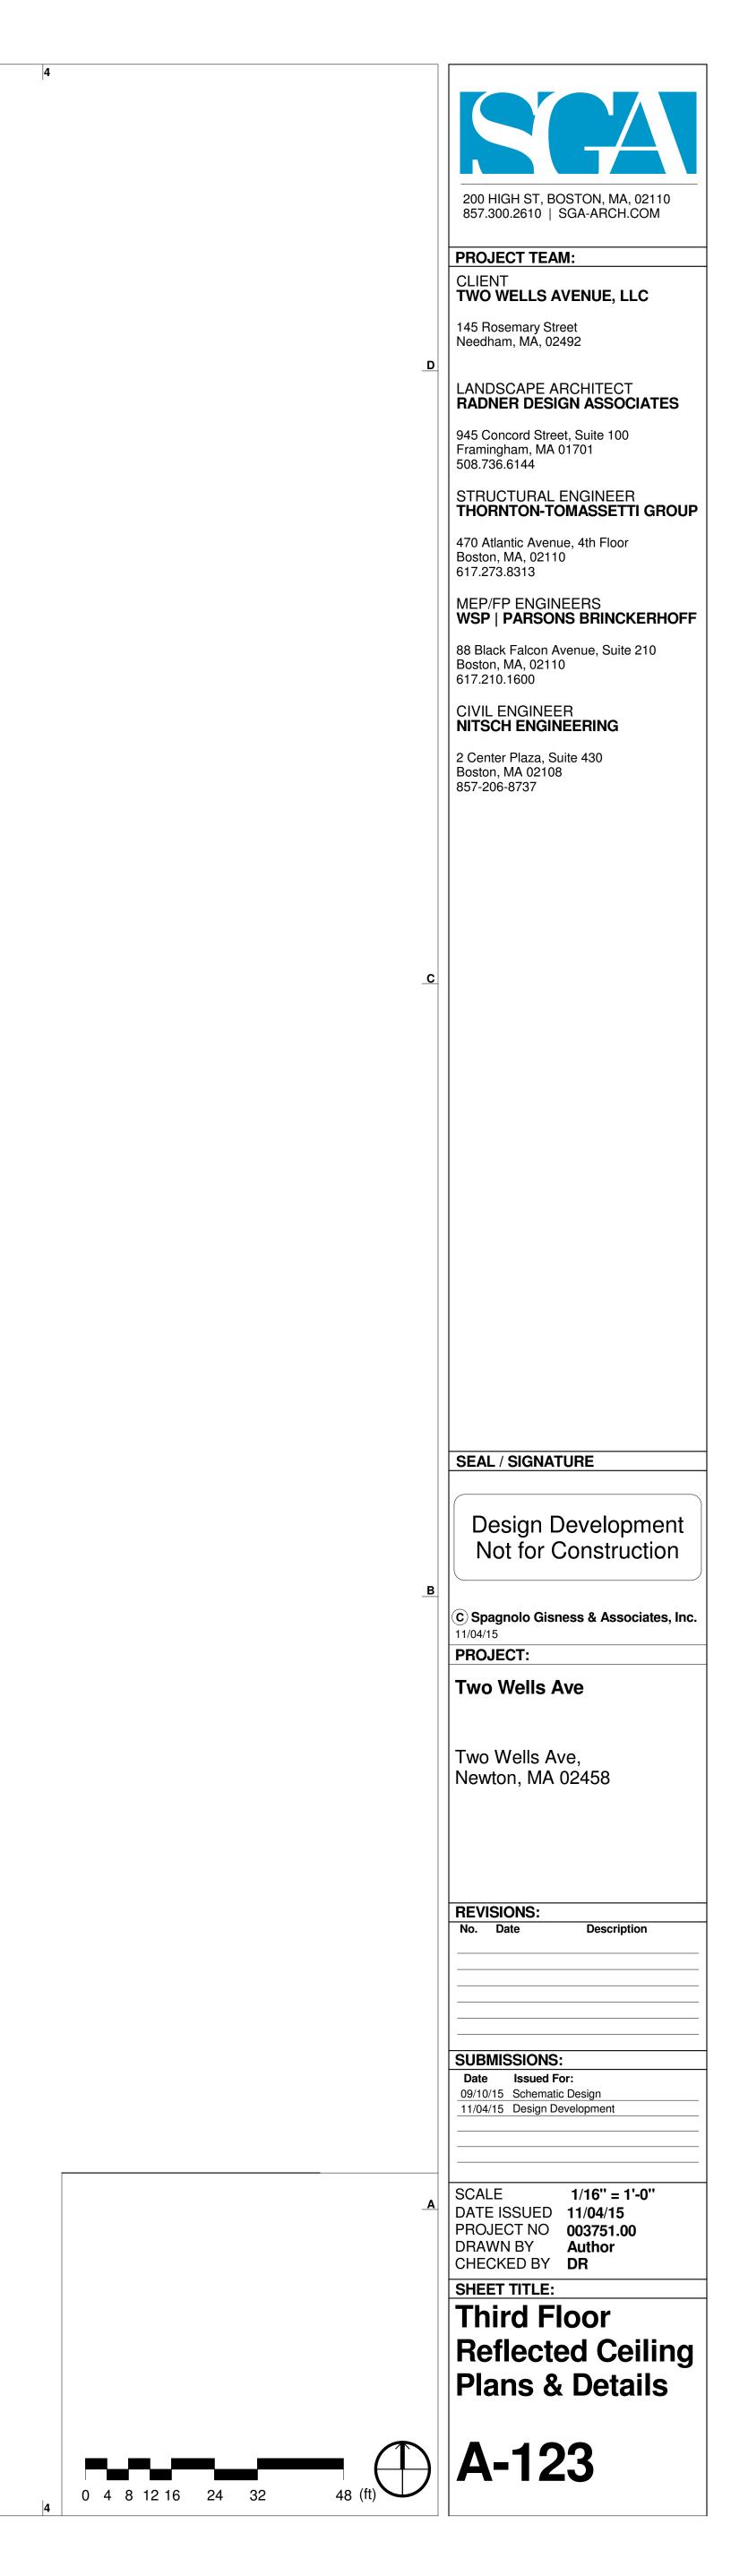

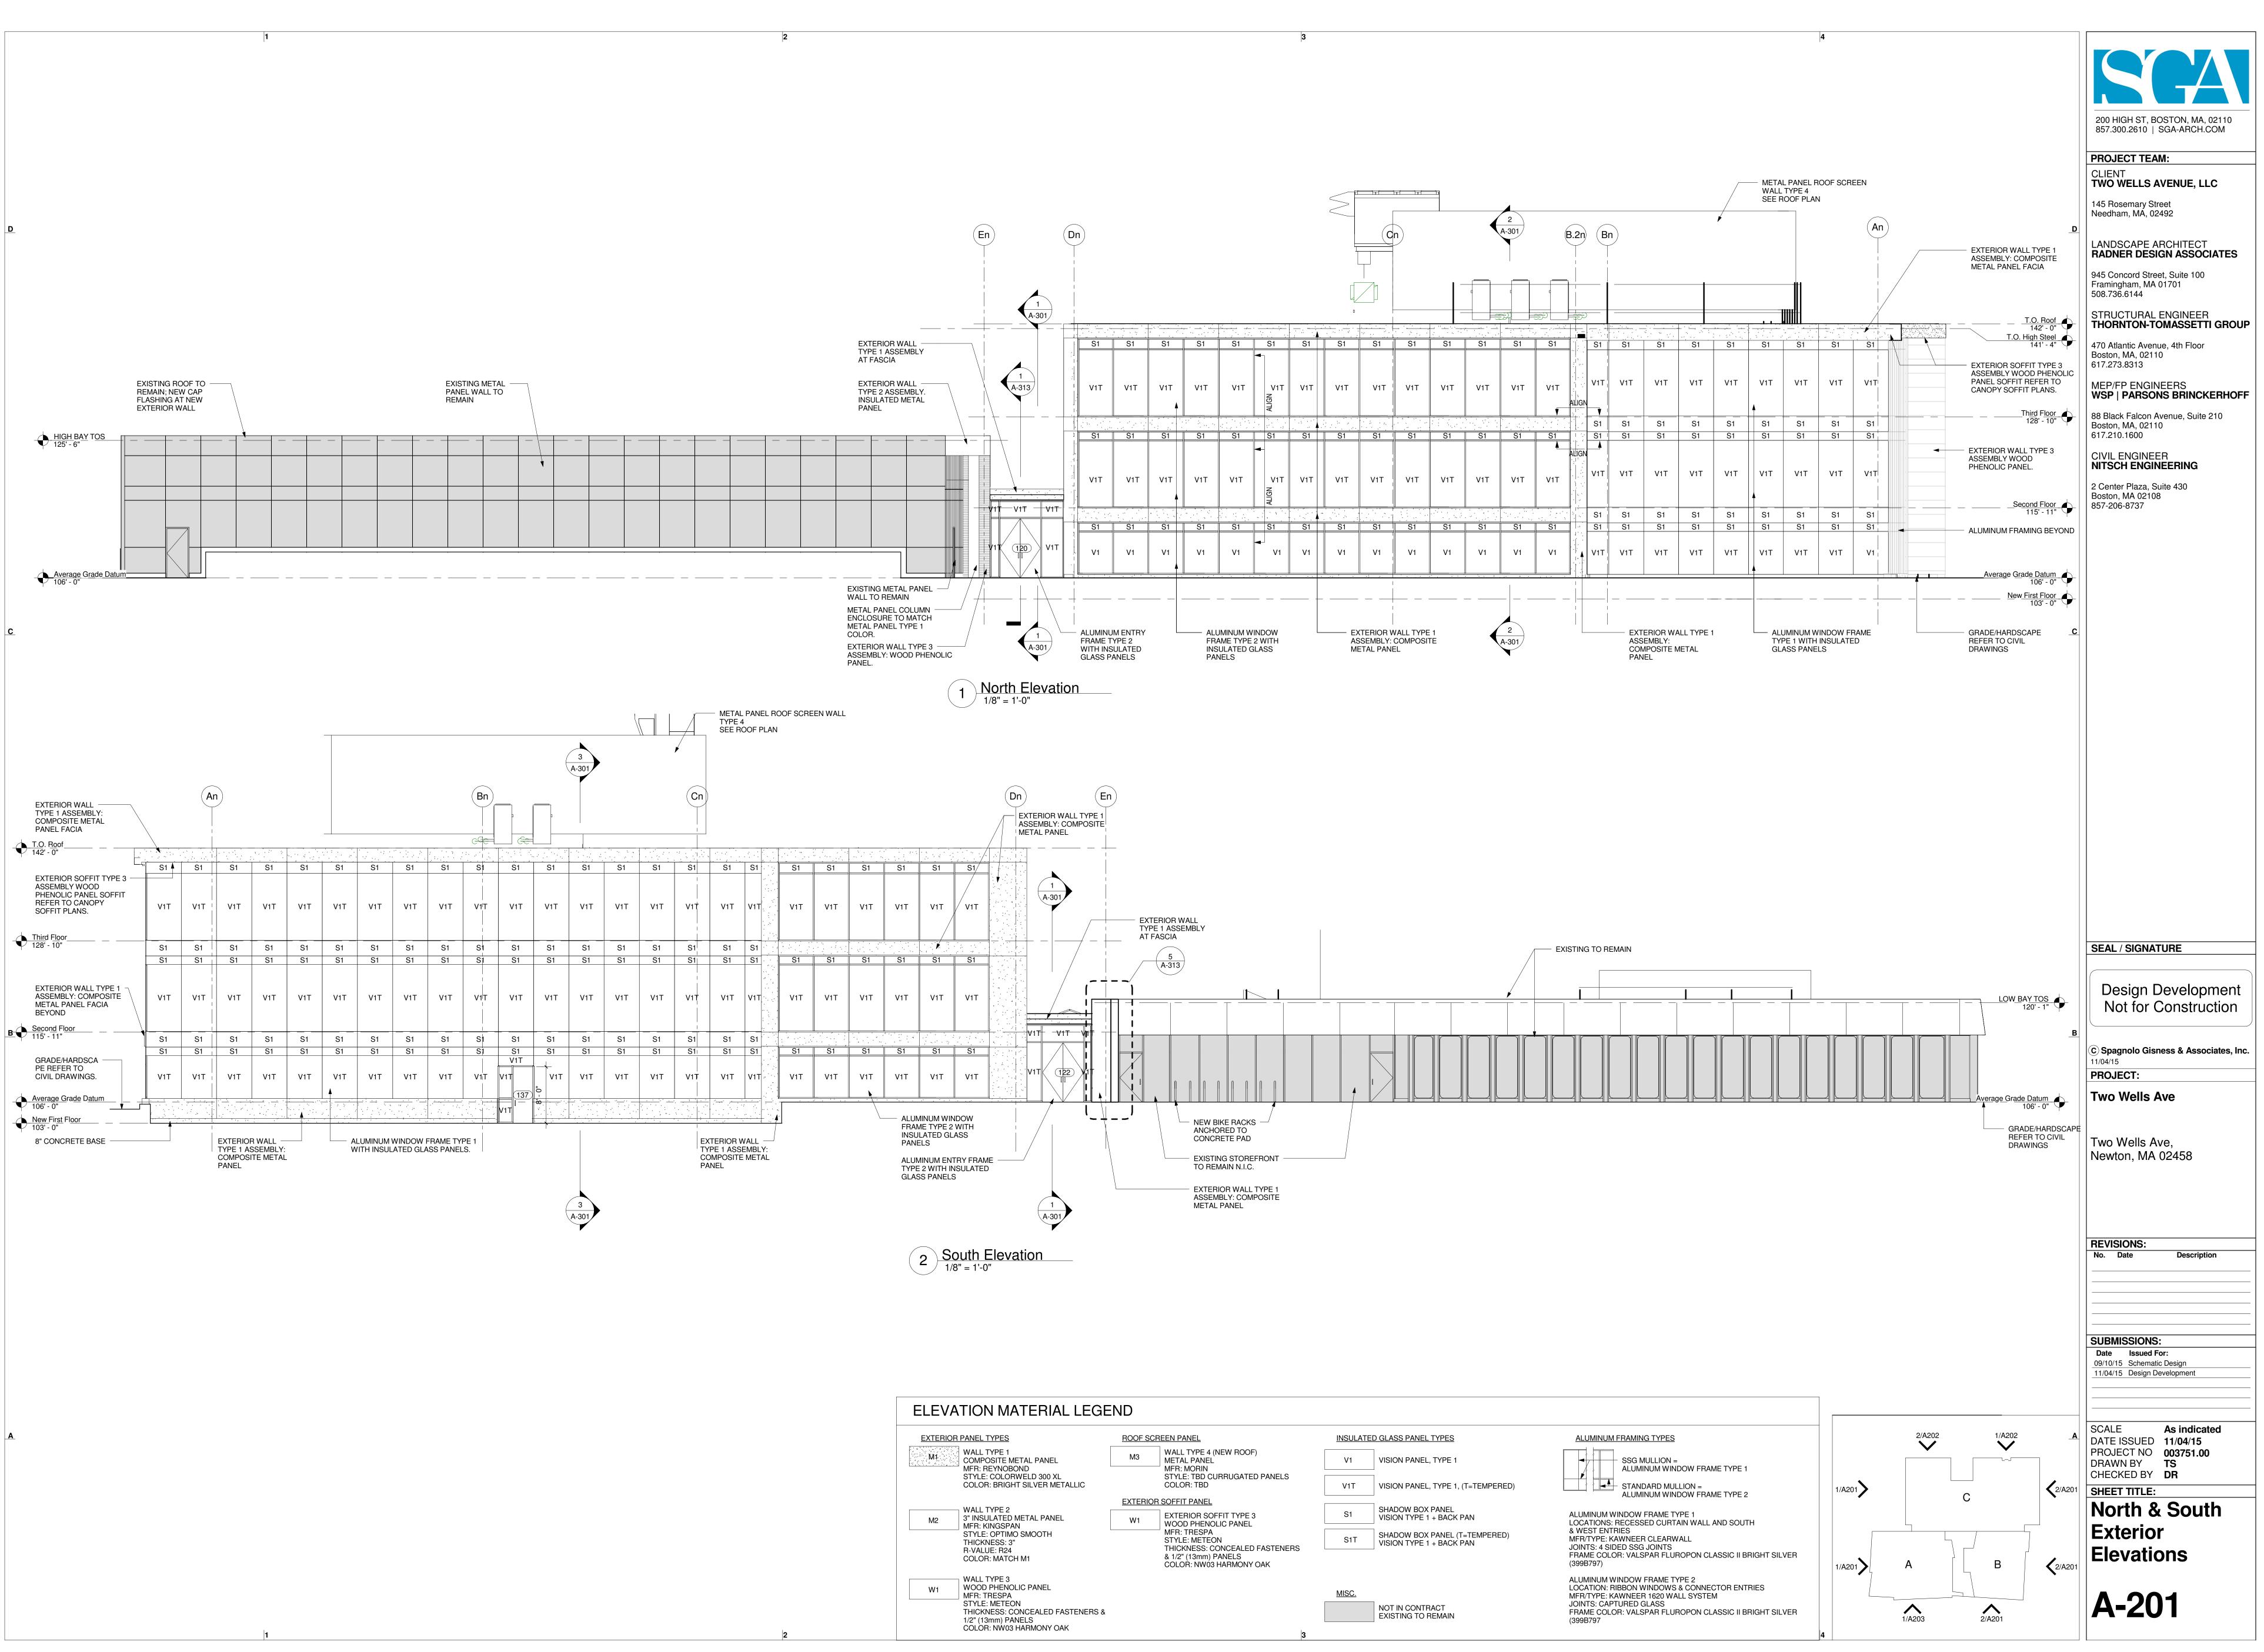



| ELEVATION MATERIAL LEG | | | | | | | | |
|--|---|---|---------------------|--|--|--------|--------|--------|
| EXTERIOR PANEL TYPES | ROOF S | SCREEN PANEL | INSULA ⁻ | TED GLASS PANEL TYPES | ALUMINUM FRAMING TYPES | | 2/A202 | 1/A202 |
| WALL TYPE 1 COMPOSITE METAL PANEL MFR: REYNOBOND | M3 | WALL TYPE 4 (NEW ROOF) METAL PANEL MFR: MORIN | V1 | VISION PANEL, TYPE 1 | SSG MULLION = ALUMINUM WINDOW FRAME TYPE 1 | | • | |
| STYLE: COLORWELD 300 XL COLOR: BRIGHT SILVER METALLIC | | STYLE: TBD CURRUGATED PANELS COLOR: TBD | V1T | VISION PANEL, TYPE 1, (T=TEMPERED) | STANDARD MULLION = ALUMINUM WINDOW FRAME TYPE 2 | 1/A201 | | |
| WALL TYPE 2 3" INSULATED METAL PANEL | | OR SOFFIT PANEL | S1 | SHADOW BOX PANEL VISION TYPE 1 + BACK PAN | ALUMINUM WINDOW FRAME TYPE 1 | | | C |
| MFR: KINGSPAN STYLE: OPTIMO SMOOTH | W1 | WOOD PHENOLIC PANEL MFR: TRESPA STYLE: METEON | S1T | SHADOW BOX PANEL (T=TEMPERED) | LOCATIONS: RECESSED CURTAIN WALL AND SOUTH & WEST ENTRIES MFR/TYPE: KAWNEER CLEARWALL | | | |
| THICKNESS: 3" R-VALUE: R24 COLOR: MATCH M1 | LUE: R24 THICKNESS: CC BB: MATCH M1 & 1/2" (13mm) P/ | THICKNESS: CONCEALED FASTENERS & 1/2" (13mm) PANELS COLOR: NW03 HARMONY OAK | | VISION TYPE 1 + BACK PAN | JOINTS: 4 SIDED SSG JOINTS FRAME COLOR: VALSPAR FLUROPON CLASSIC II BRIGHT SILVER (399B797) | | A | В |
| WALL TYPE 3 WOOD PHENOLIC PANEL MFR: TRESPA | | OCLOTI. NWOSTIANIMONT CAR | MISC. | | ALUMINUM WINDOW FRAME TYPE 2 LOCATION: RIBBON WINDOWS & CONNECTOR ENTRIES MFR/TYPE: KAWNEER 1620 WALL SYSTEM | 1/A201 | | |
| STYLE: METEON THICKNESS: CONCEALED FASTENERS & 1/2" (13mm) PANELS COLOR: NW03 HARMONY OAK | ESS: CONCEALED FASTENERS & m) PANELS | | | NOT IN CONTRACT EXISTING TO REMAIN | JOINTS: CAPTURED GLASS FRAME COLOR: VALSPAR FLUROPON CLASSIC II BRIGHT SILVER (399B797 | | 1/A203 | 2/A201 |

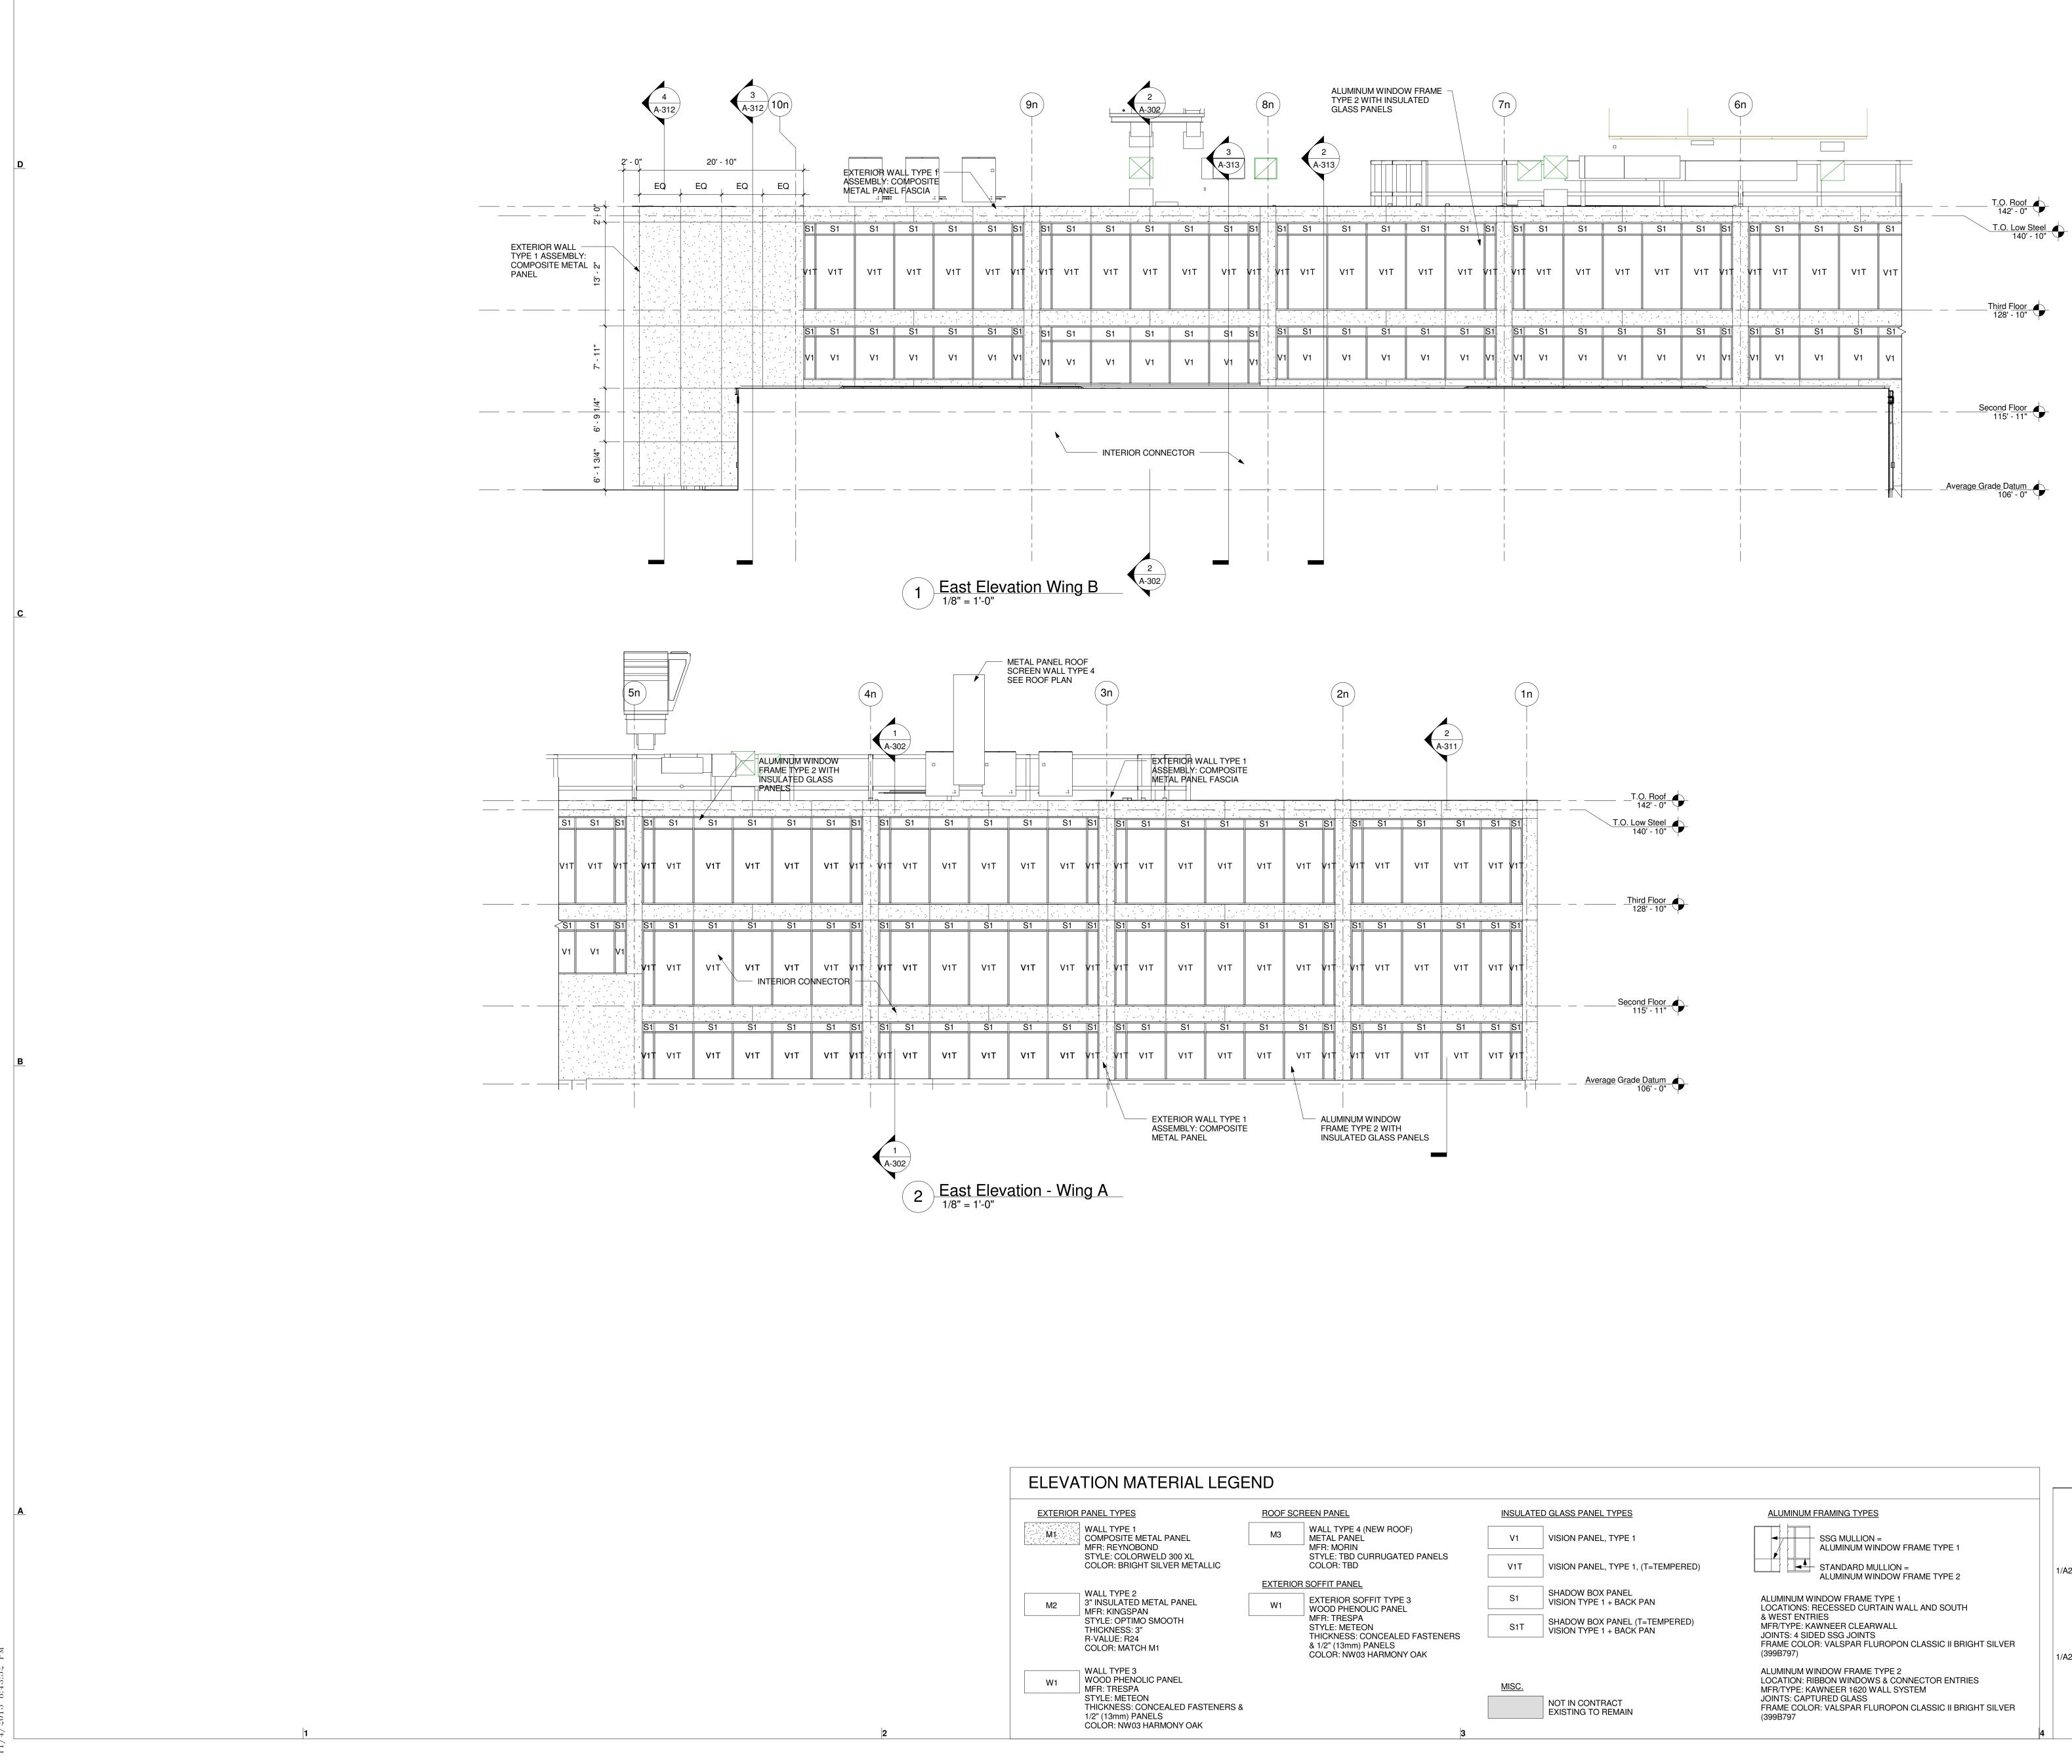

| ELEVATION MATERIAL LEGEND | | | | | | | | | | | |
|---|---------|---|-------|-------|--|--|--|--|--|--|--|
| EXTERIOR PANEL TYPES | ROOF SC | | INSUL | | | | | | | | |
| WALL TYPE 1 COMPOSITE METAL PANEL MFR: REYNOBOND | МЗ | WALL TYPE 4 (NEW ROOF) METAL PANEL MFR: MORIN | | V1 | | | | | | | |
| STYLE: COLORWELD 300 XL COLOR: BRIGHT SILVER METALLIC | | STYLE: TBD CURRUGATED PANELS COLOR: TBD | | V1T | | | | | | | |
| | EXTERIO | R SOFFIT PANEL | | | | | | | | | |
| M2 M2 M2 M2 MER: KINGSPAN | W1 | EXTERIOR SOFFIT TYPE 3 WOOD PHENOLIC PANEL | | S1 | | | | | | | |
| STYLE: OPTIMO SMOOTH THICKNESS: 3" R-VALUE: R24 | | ☐ MFR: TRESPA STYLE: METEON THICKNESS: CONCEALED FASTENEF | s | S1T | | | | | | | |
| COLOR: MATCH M1 | | & 1/2" (13mm) PANELS COLOR: NW03 HARMONY OAK | | | | | | | | | |
| W1 WALL TYPE 3 WOOD PHENOLIC PANEL MFR: TRESPA | | | | MISC. | | | | | | | |
| STYLE: METEON THICKNESS: CONCEALED FASTENERS & 1/2" (13mm) PANELS | | | | | | | | | | | |
| COLOR: NW03 HARMONY OAK | | | 3 | | | | | | | | |


2/A202 1/A202 ____ 1/A201 С B 1/A201 1/A203 \wedge 2/A201

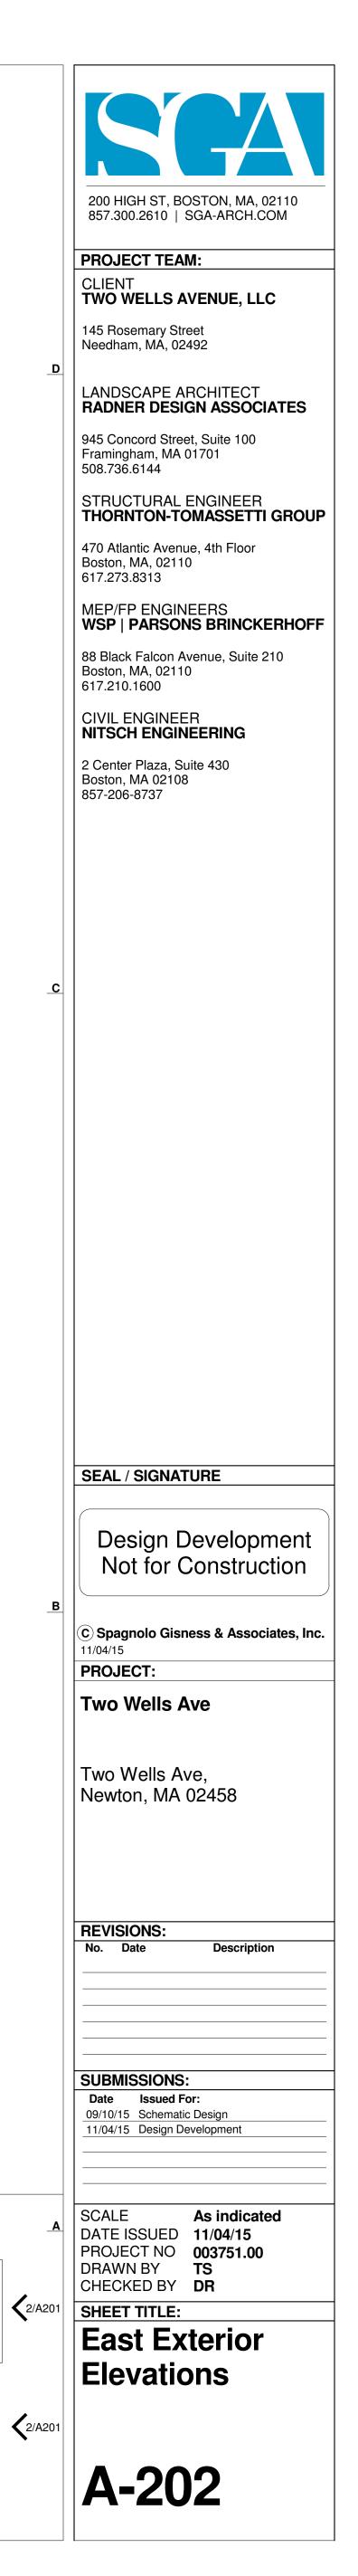


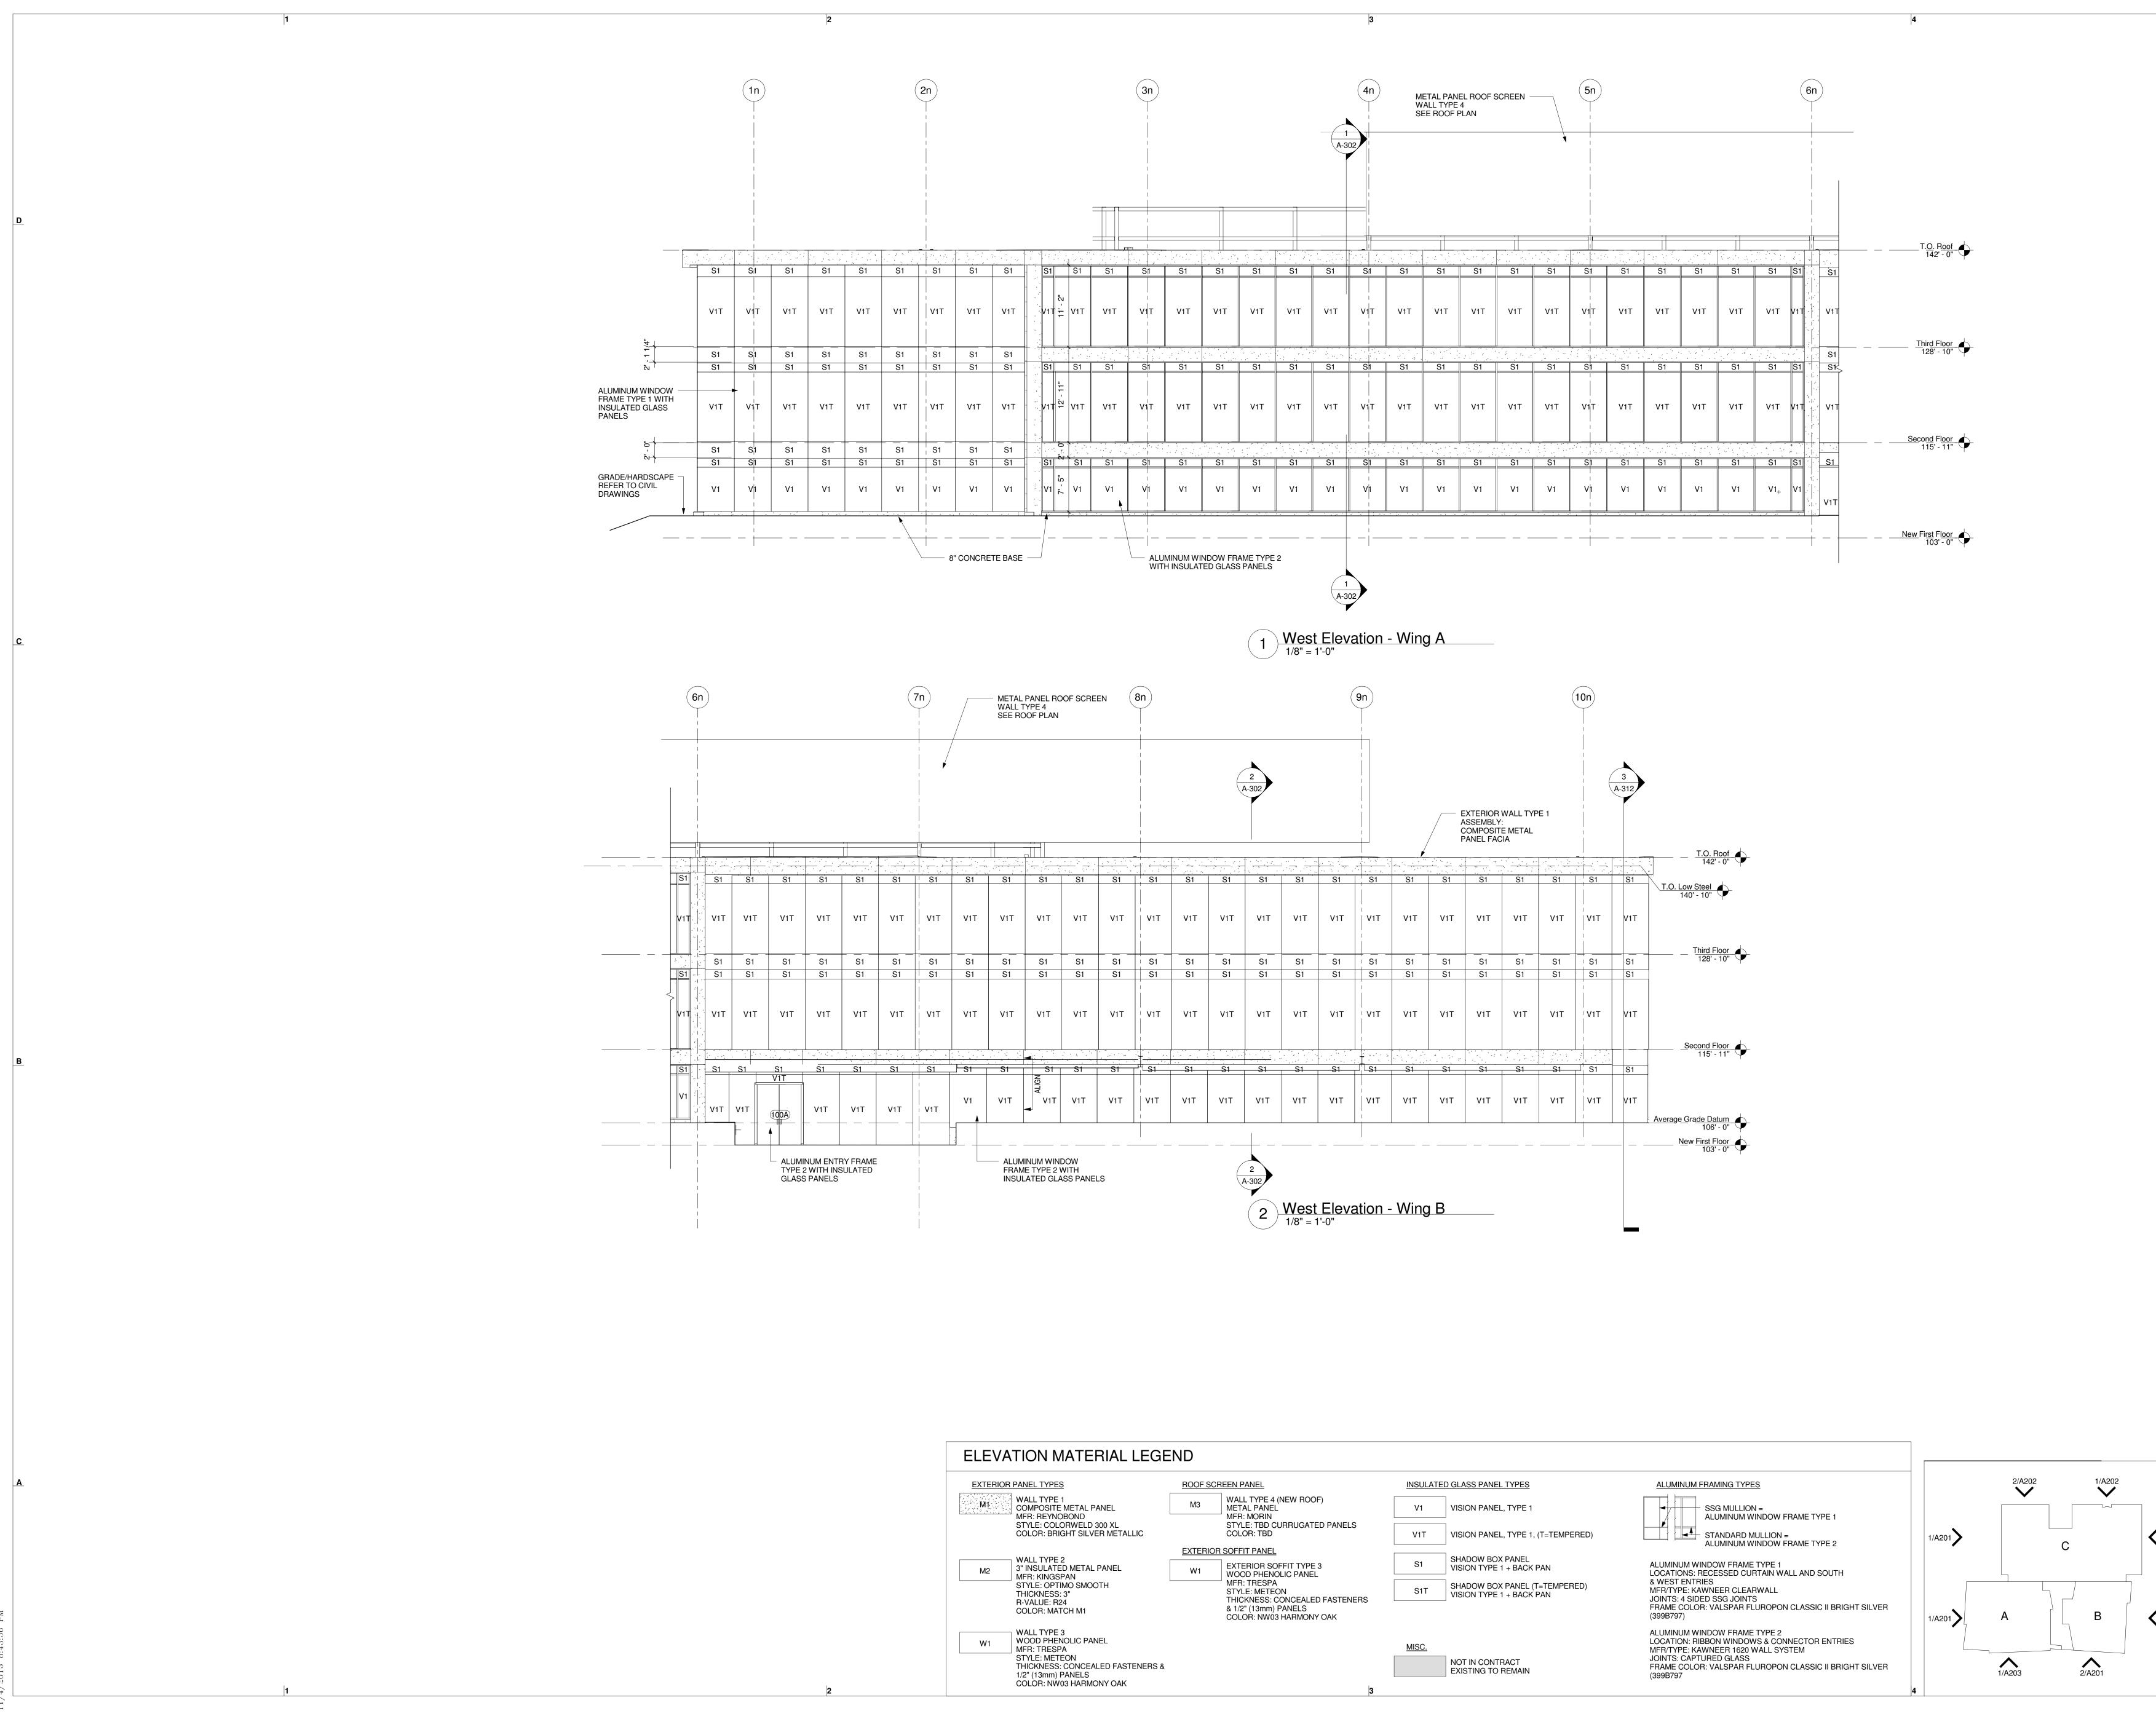


| | 6n | | | | | | | 7 n | | WALL | PANEL RC TYPE 4 DOF PLAN | OF SCRE | EN | 8n | | | | | (| 9n | |
|-------------|------|-----------|---|---|-------------------------------------|----------|-------------|---------------|-----------------|-----------|---|----------------|-------------------------|------|---|------------|---------------|--|---|----------|---|
| | | | | | | | | | | | | | | | | | 2 | | | | |
| | | | | | | | | - | | | | | | | | | | | | | _ |
| `′- `` | | | | | | <u> </u> | · · · · · · | | <u> </u> | <u> </u> | ↓ `` <u></u> | <u> </u> | <u>, -, (-) (</u> , -, | -+ | <u> </u> | | <u> </u> | · · · · · · · · · · · | <u>,, -, -, -, -, -, -, -, -, -, -, -, -, -</u> | | <u>, , , , , , , , , , , , , , , , , , , </u> |
| S1 | | S1 [| | <u>, , , , , , , , , , , , , , , , , , , </u> | <u> </u> | S1 | S1 | <u> </u> S1 | <u> </u> | S1 | <u>) - , , , , , , , , , , , , , , , , , , </u> | <u> </u> | S1 | S1 | <u> </u> | S1 | <u>-,</u> | <u> </u> | S1 | <u> </u> | S1 |
| , | | | | | | | | | | | | | | | | | | | | | |
| /11 | | V1T | V1T | V1T | V1T | V1T | V1T | V1T | V1T | V1T | V1T | V1T | V1T | V1T | V1T | V1T | V1T | V1T | V1T | V1T | V1T |
| -, , (| - 1 | S1 | | | | | | S1 | | | | | | ↓ S1 | | S1 | | | | 51 | S1 |
| S1 | | S1 | S1 | S1 | S1 | S1 | S1 | S1 | S1 | S1 | S1 | S1 | S1 | S1 | S1 | S1 | S1 | S1 | S1 | S1 | S1 |
| /11 | | V1T | V1T | V1T | V1T | V1T | V1T | V1T | V1T | V1T | V1T | V1T | V1T | V1T | V1T | V1T | V1T | V1T | V1T | V1T | V1T |
| · · · · · | | | | | | | | | | | | | | | | | | | | | |
| · -' . - | - 1/ | | , <u>, , , , , , , , , , , , , , , , , , </u> | | | | · , | | | · · · · · | | | · ,- · · · · · · | | / · · · · · · · · · · · · · · · · · · · | | , | i an an an an an an An an | 1 - 1 × 1, 1 | | 1 - C - C - C - |
| <u>S1</u>) | | <u>S1</u> | S1 | <u>S1</u> V1T | S1 | S1 | S1 | S1 | _ S1 | S1 | <u>\$1</u> | \$1 | S1 | | <u>\$1</u> | <u>\$1</u> | <u>\$1</u> | S1 | <u>\$1</u> | S1 | S1 |
| V1 | | V1T | V1T | | V1T | V1T | V1T | V1T | V1 | V1T | V1T | V1T | V1T | V1T | V1T | V1T | V1T | V1T | V1T | V1T | V1T |
| | | | | TYPE | INUM ENTF 2 WITH INS S PANELS | | | | | FRAM | IINUM WINI IE TYPE 2 \ LATED GLA | NITH | | | | | 2 302 2 | West | <u>Elev</u> a | ation - | Wing |


| ELEVATION MATERIAL LEGEND | | | | | | | | | | |
|--|---|-------------------------------|-------|--|--|--|--|--|--|--|
| EXTERIOR PANEL TYPES | ROOF SCREEN PANEL | | INSU | | | | | | | |
| WALL TYPE 1 COMPOSITE METAL PANEL MFR: REYNOBOND | M3 WALL TYPE METAL PAN MFR: MORII | | V1 | | | | | | | |
| STYLE: COLORWELD 300 XL COLOR: BRIGHT SILVER METALLIC | STYLE: TBD COLOR: TB | D CURRUGATED PANELS D | V1T | | | | | | | |
| | EXTERIOR SOFFIT PAN | EL | | | | | | | | |
| M2 WALL TYPE 2 3" INSULATED METAL PANEL MFR: KINGSPAN | EXTERIOR | SOFFIT TYPE 3 ENOLIC PANEL | S1 | | | | | | | |
| STYLE: OPTIMO SMOOTH THICKNESS: 3" R-VALUE: R24 | MFR: TRES STYLE: MET THICKNESS | | S17 | | | | | | | |
| COLOR: MATCH M1 | & 1/2" (13mr | | | | | | | | | |
| WALL TYPE 3 WOOD PHENOLIC PANEL MFR: TRESPA STYLE: METEON THICKNESS: CONCEALED FASTENERS & 1/2" (13mm) PANELS | | | MISC. | | | | | | | |
| COLOR: NW03 HARMONY OAK | | 3 | | | | | | | | |

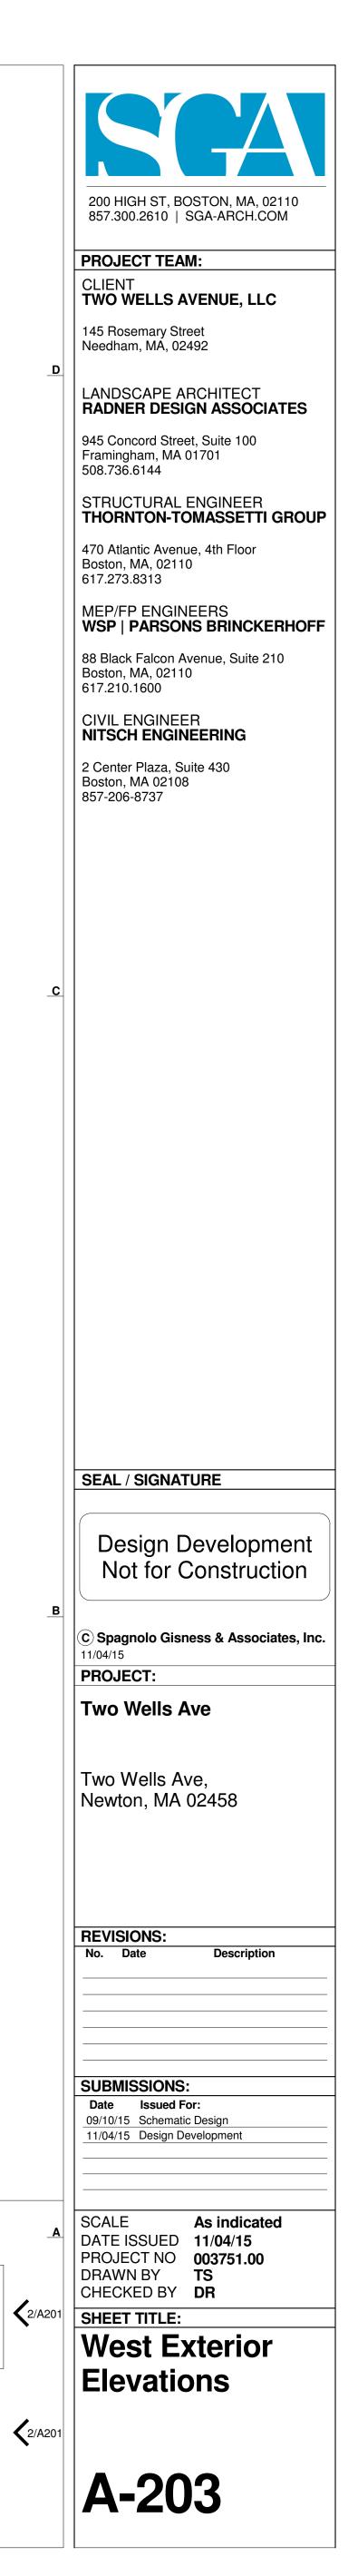


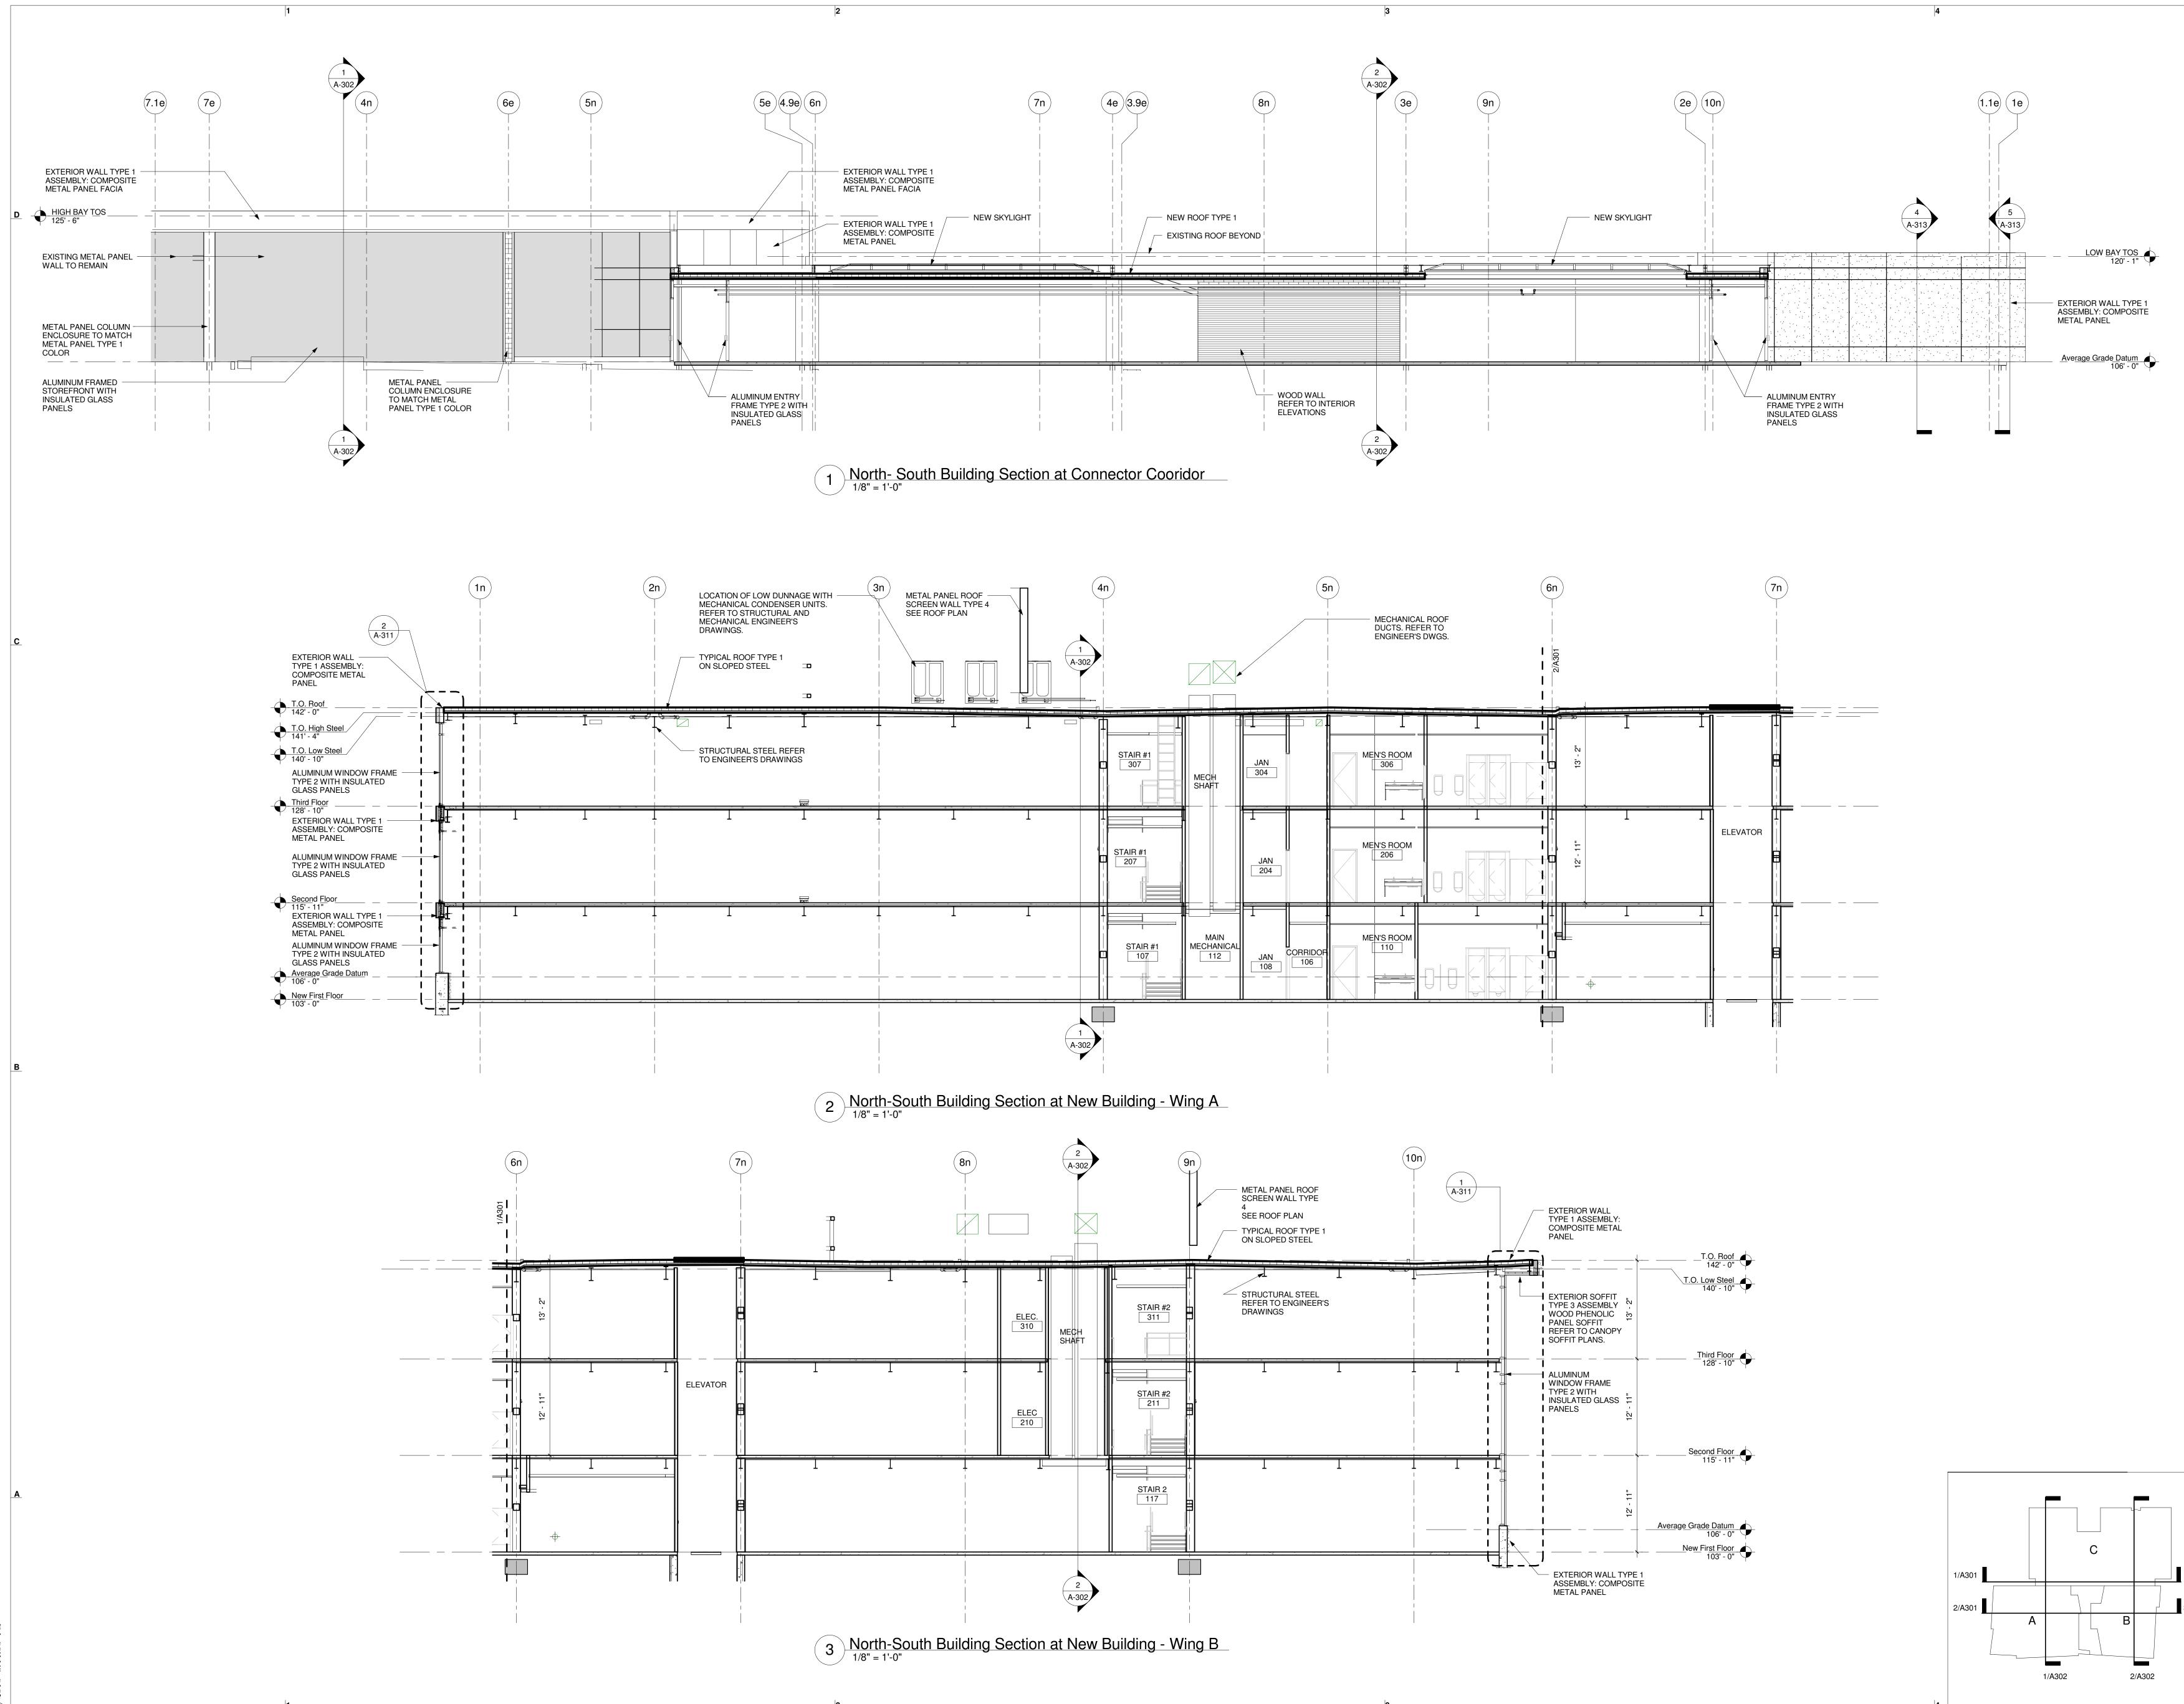


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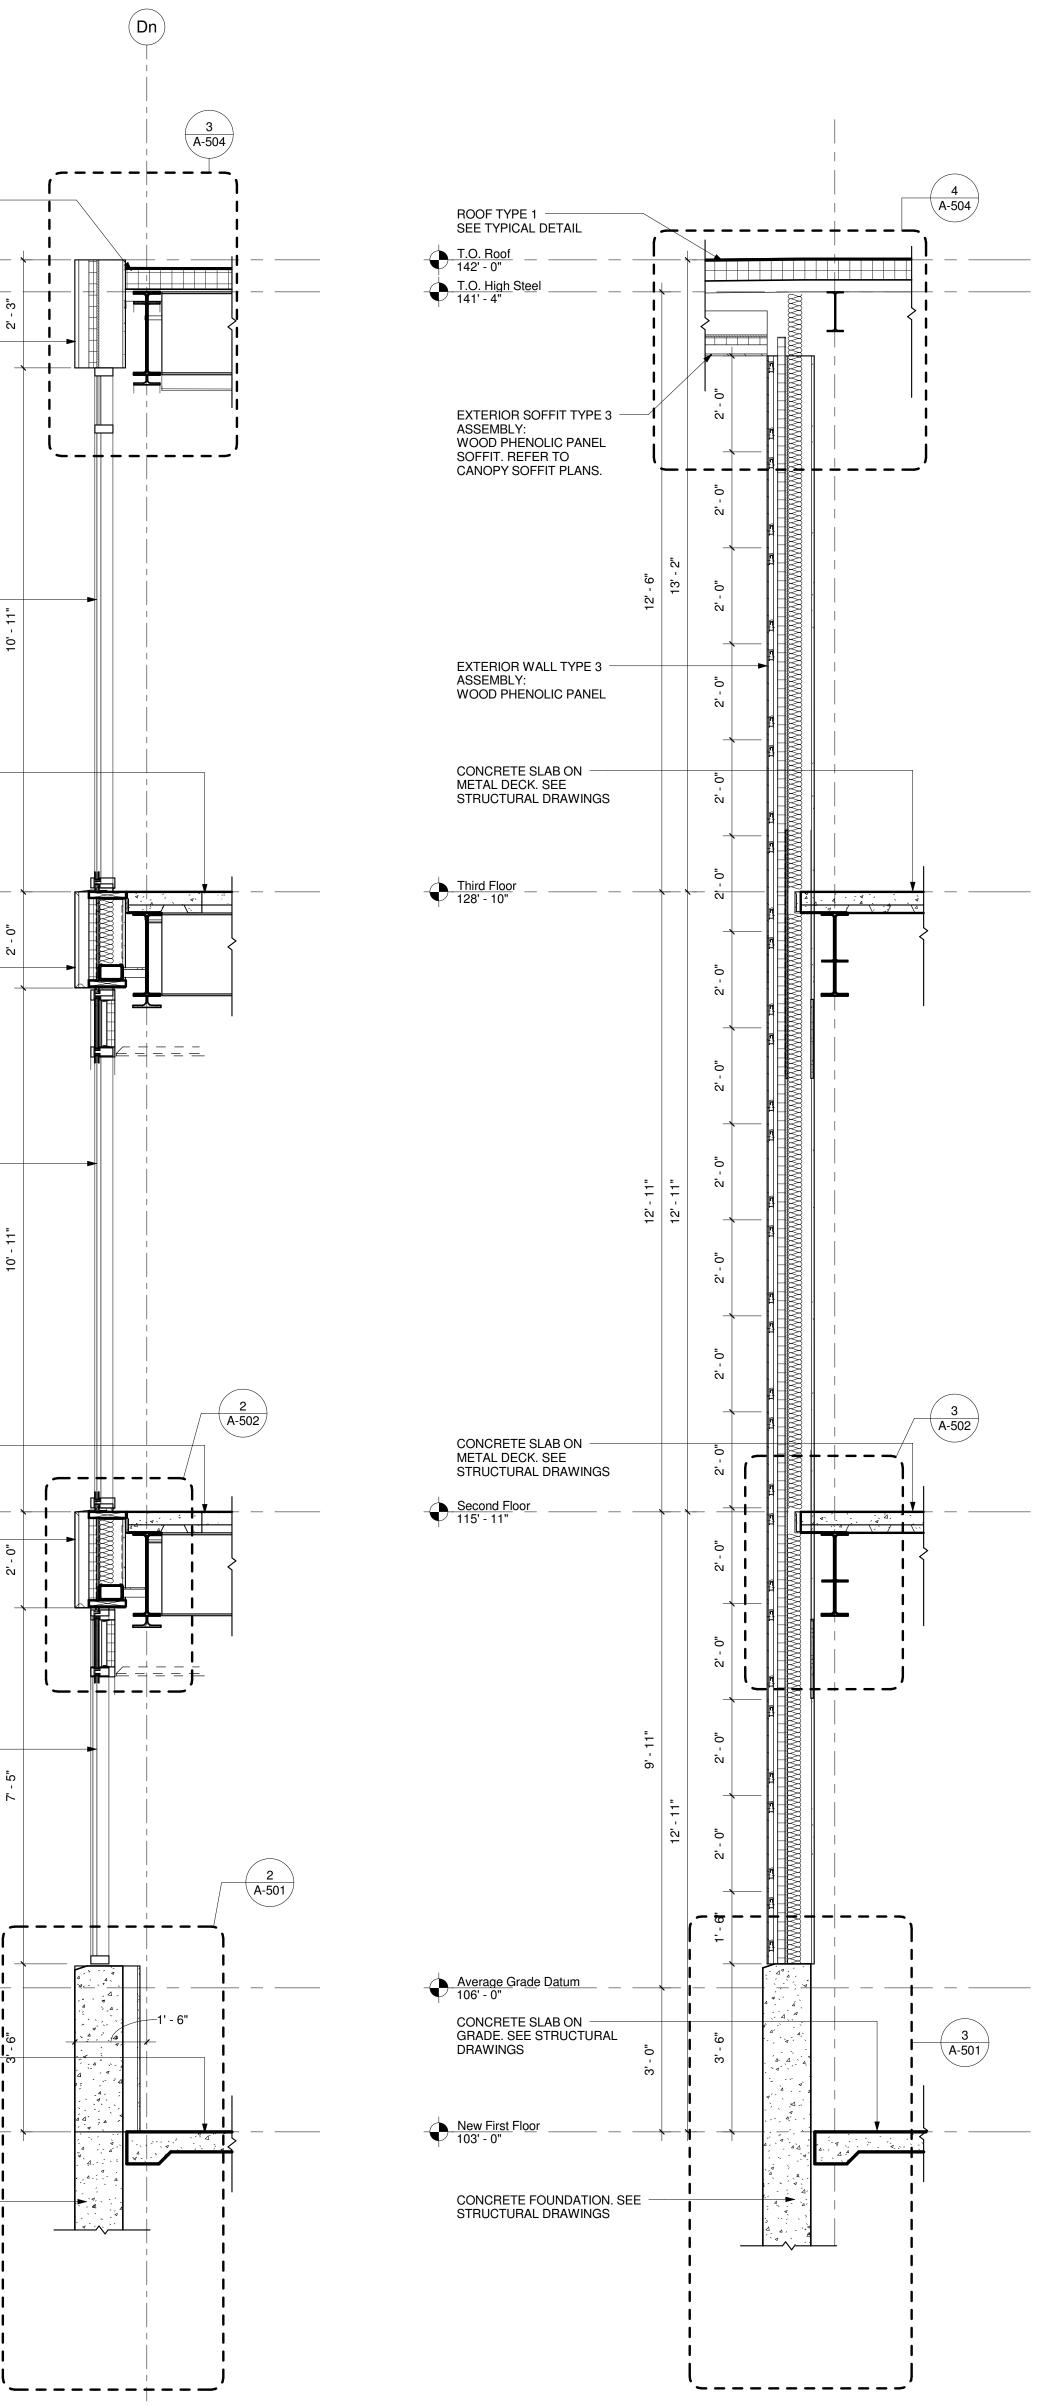


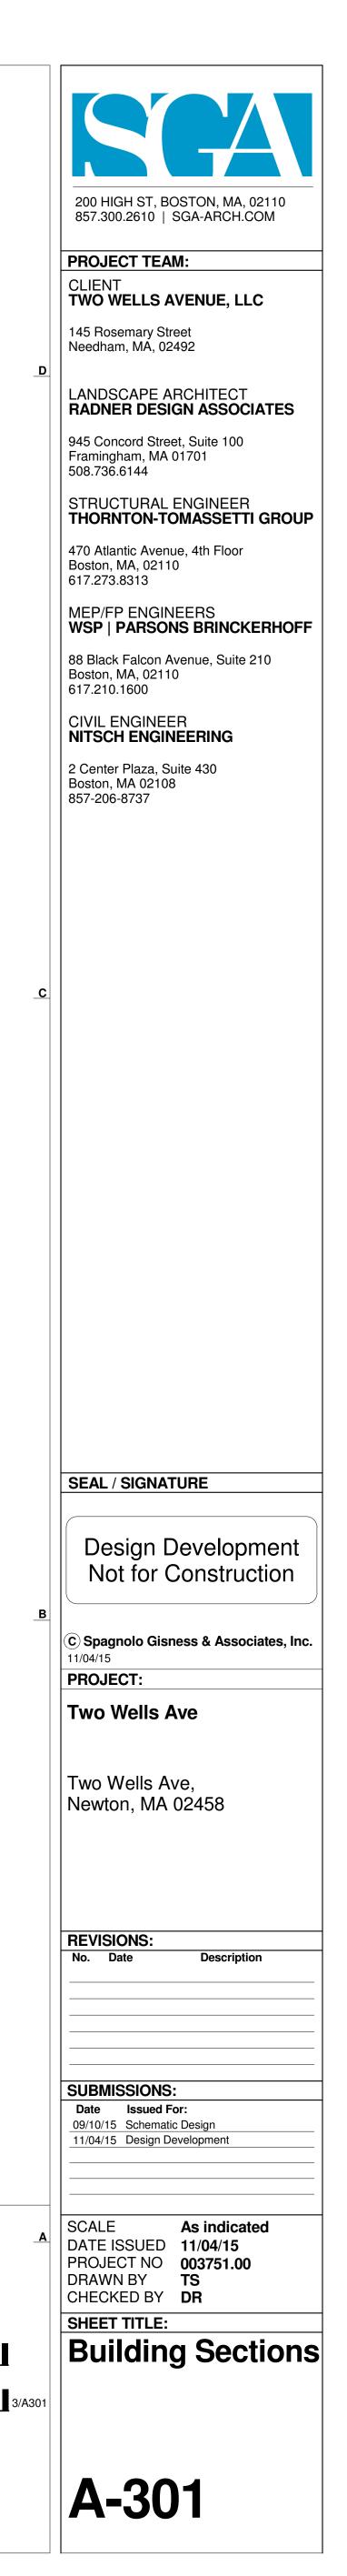

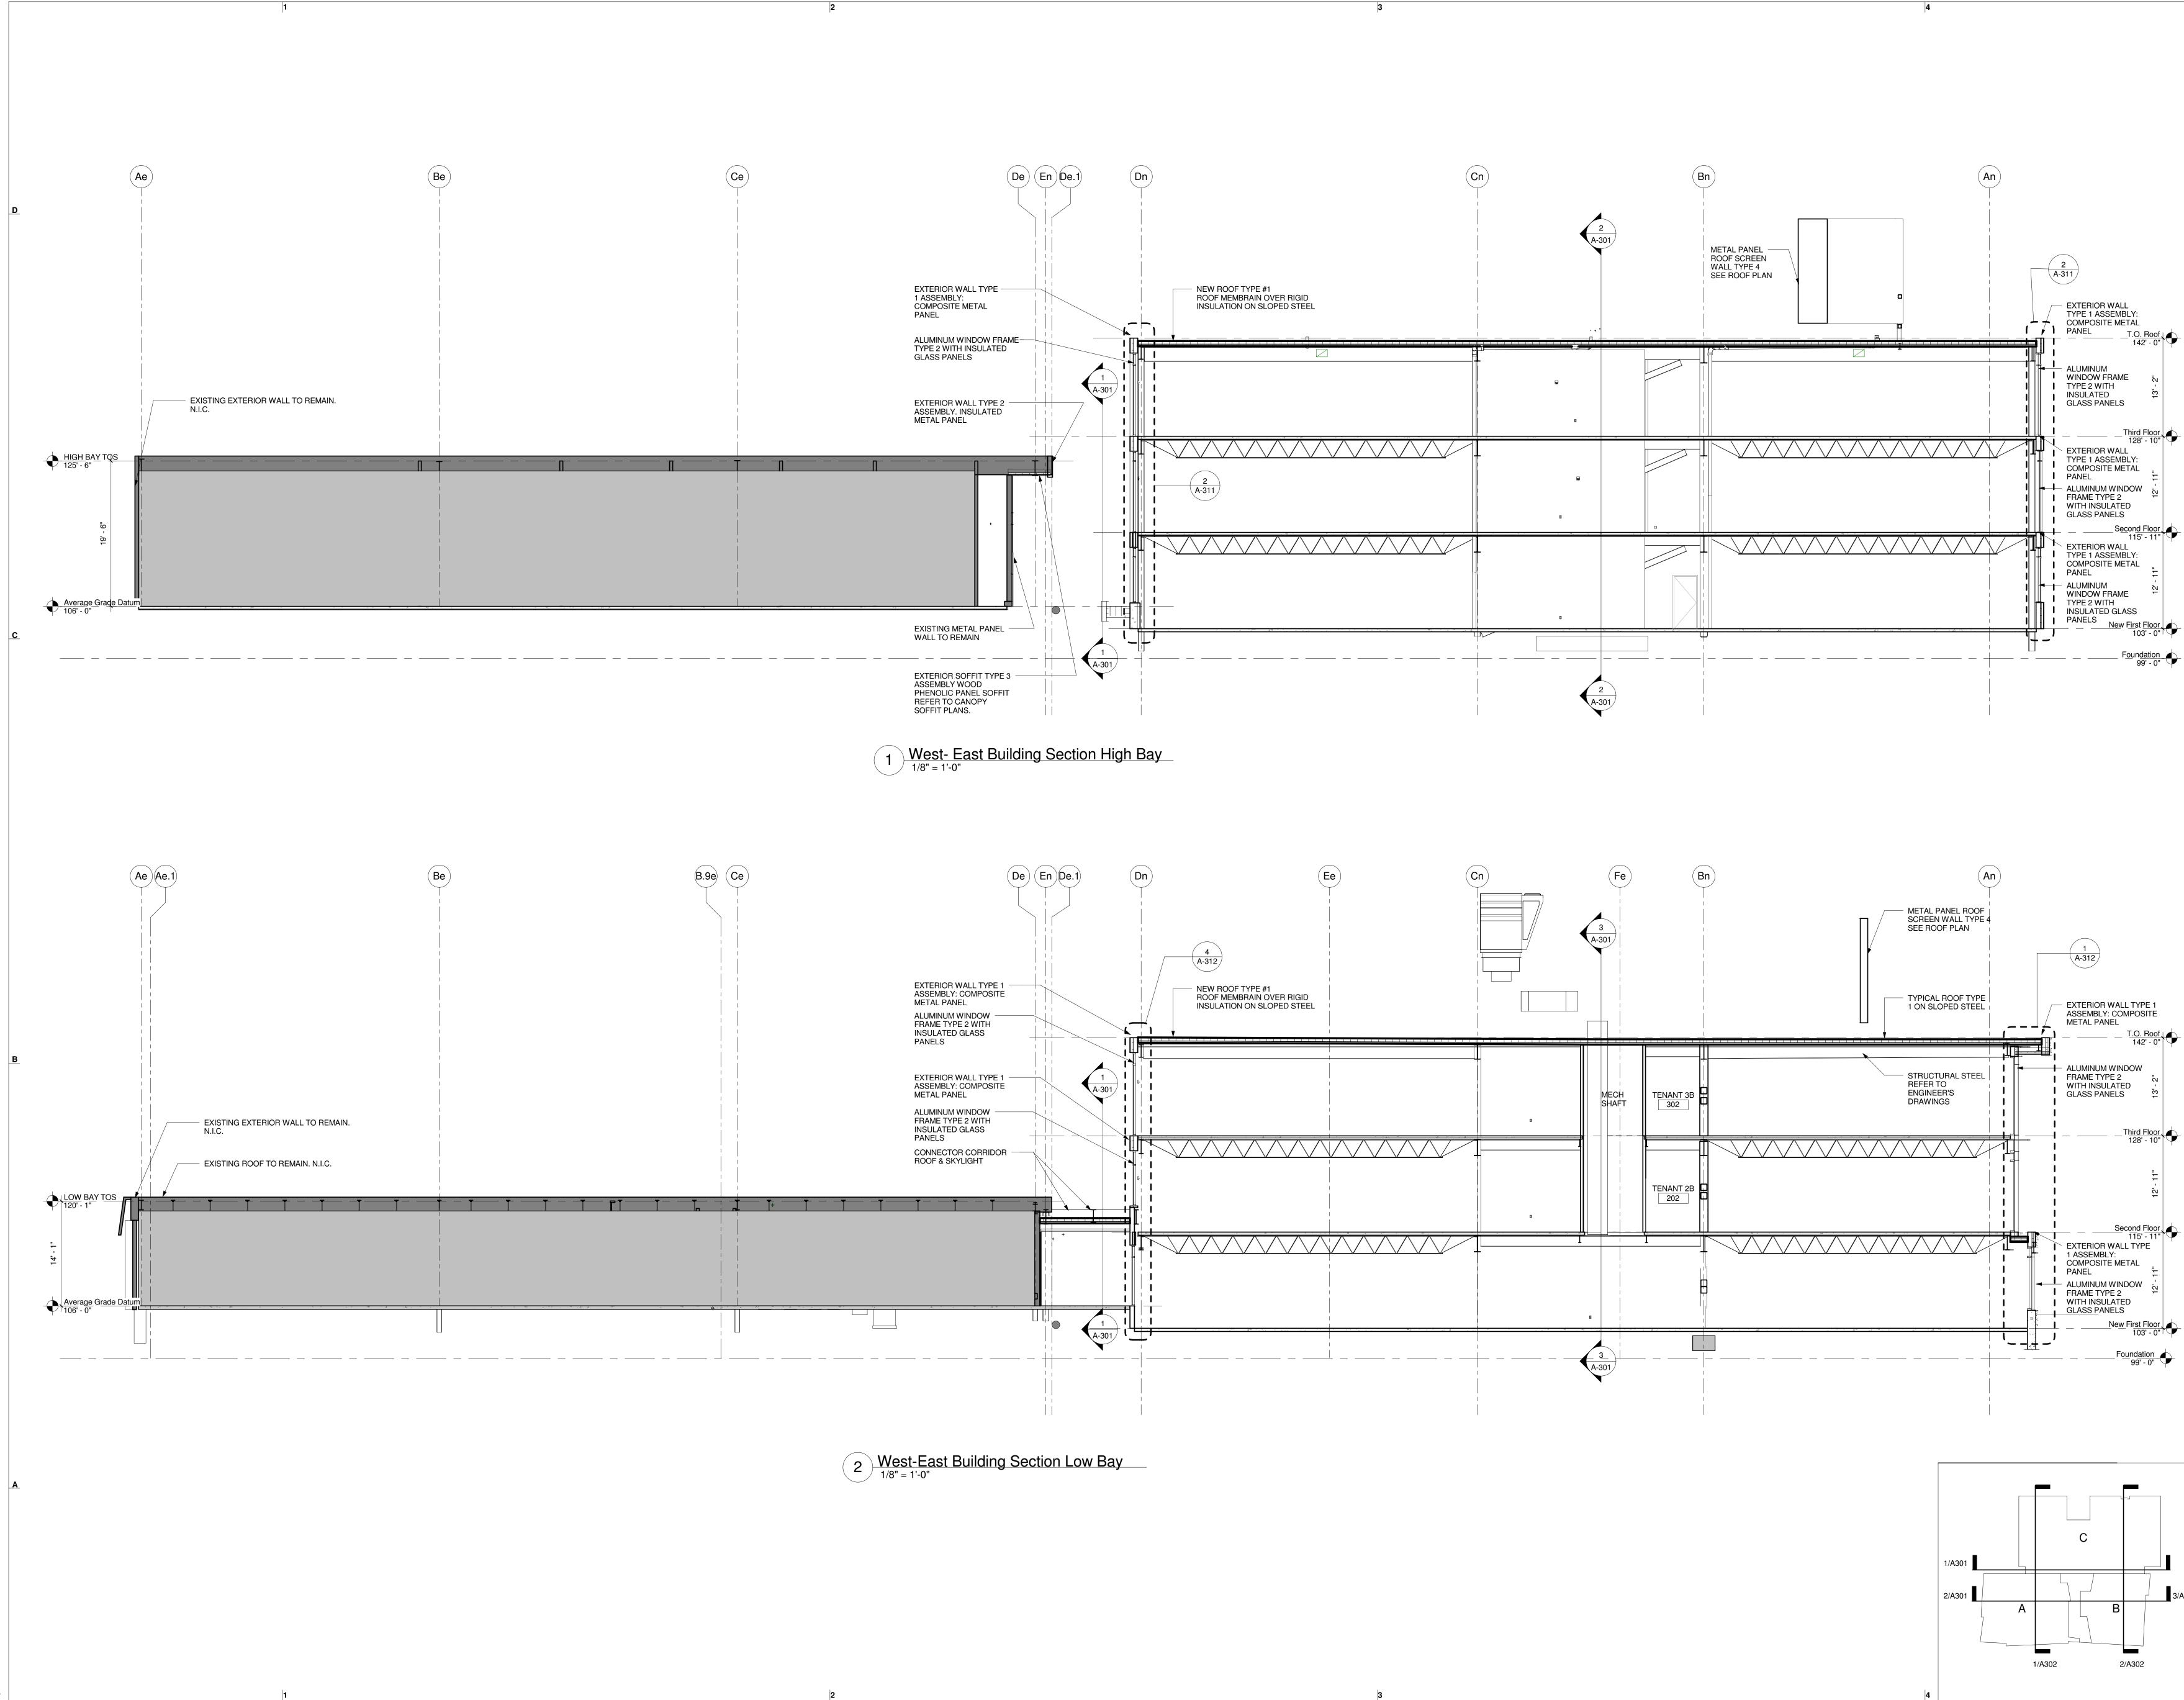

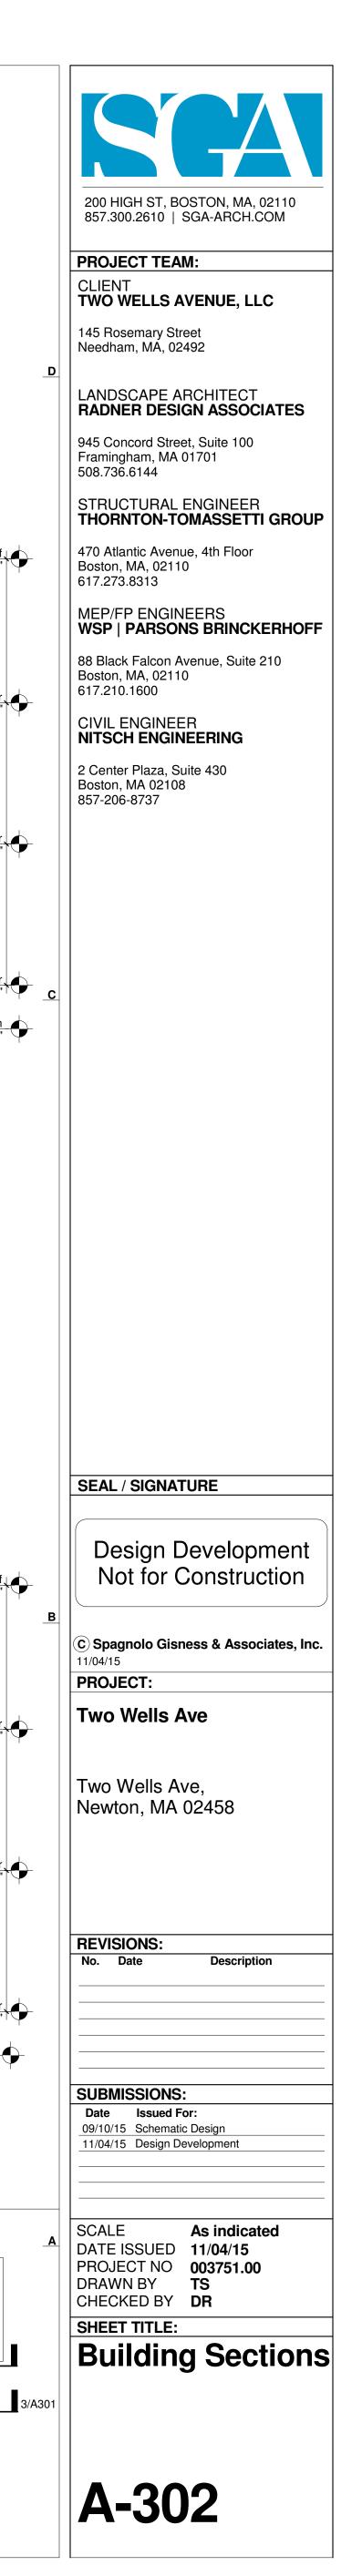


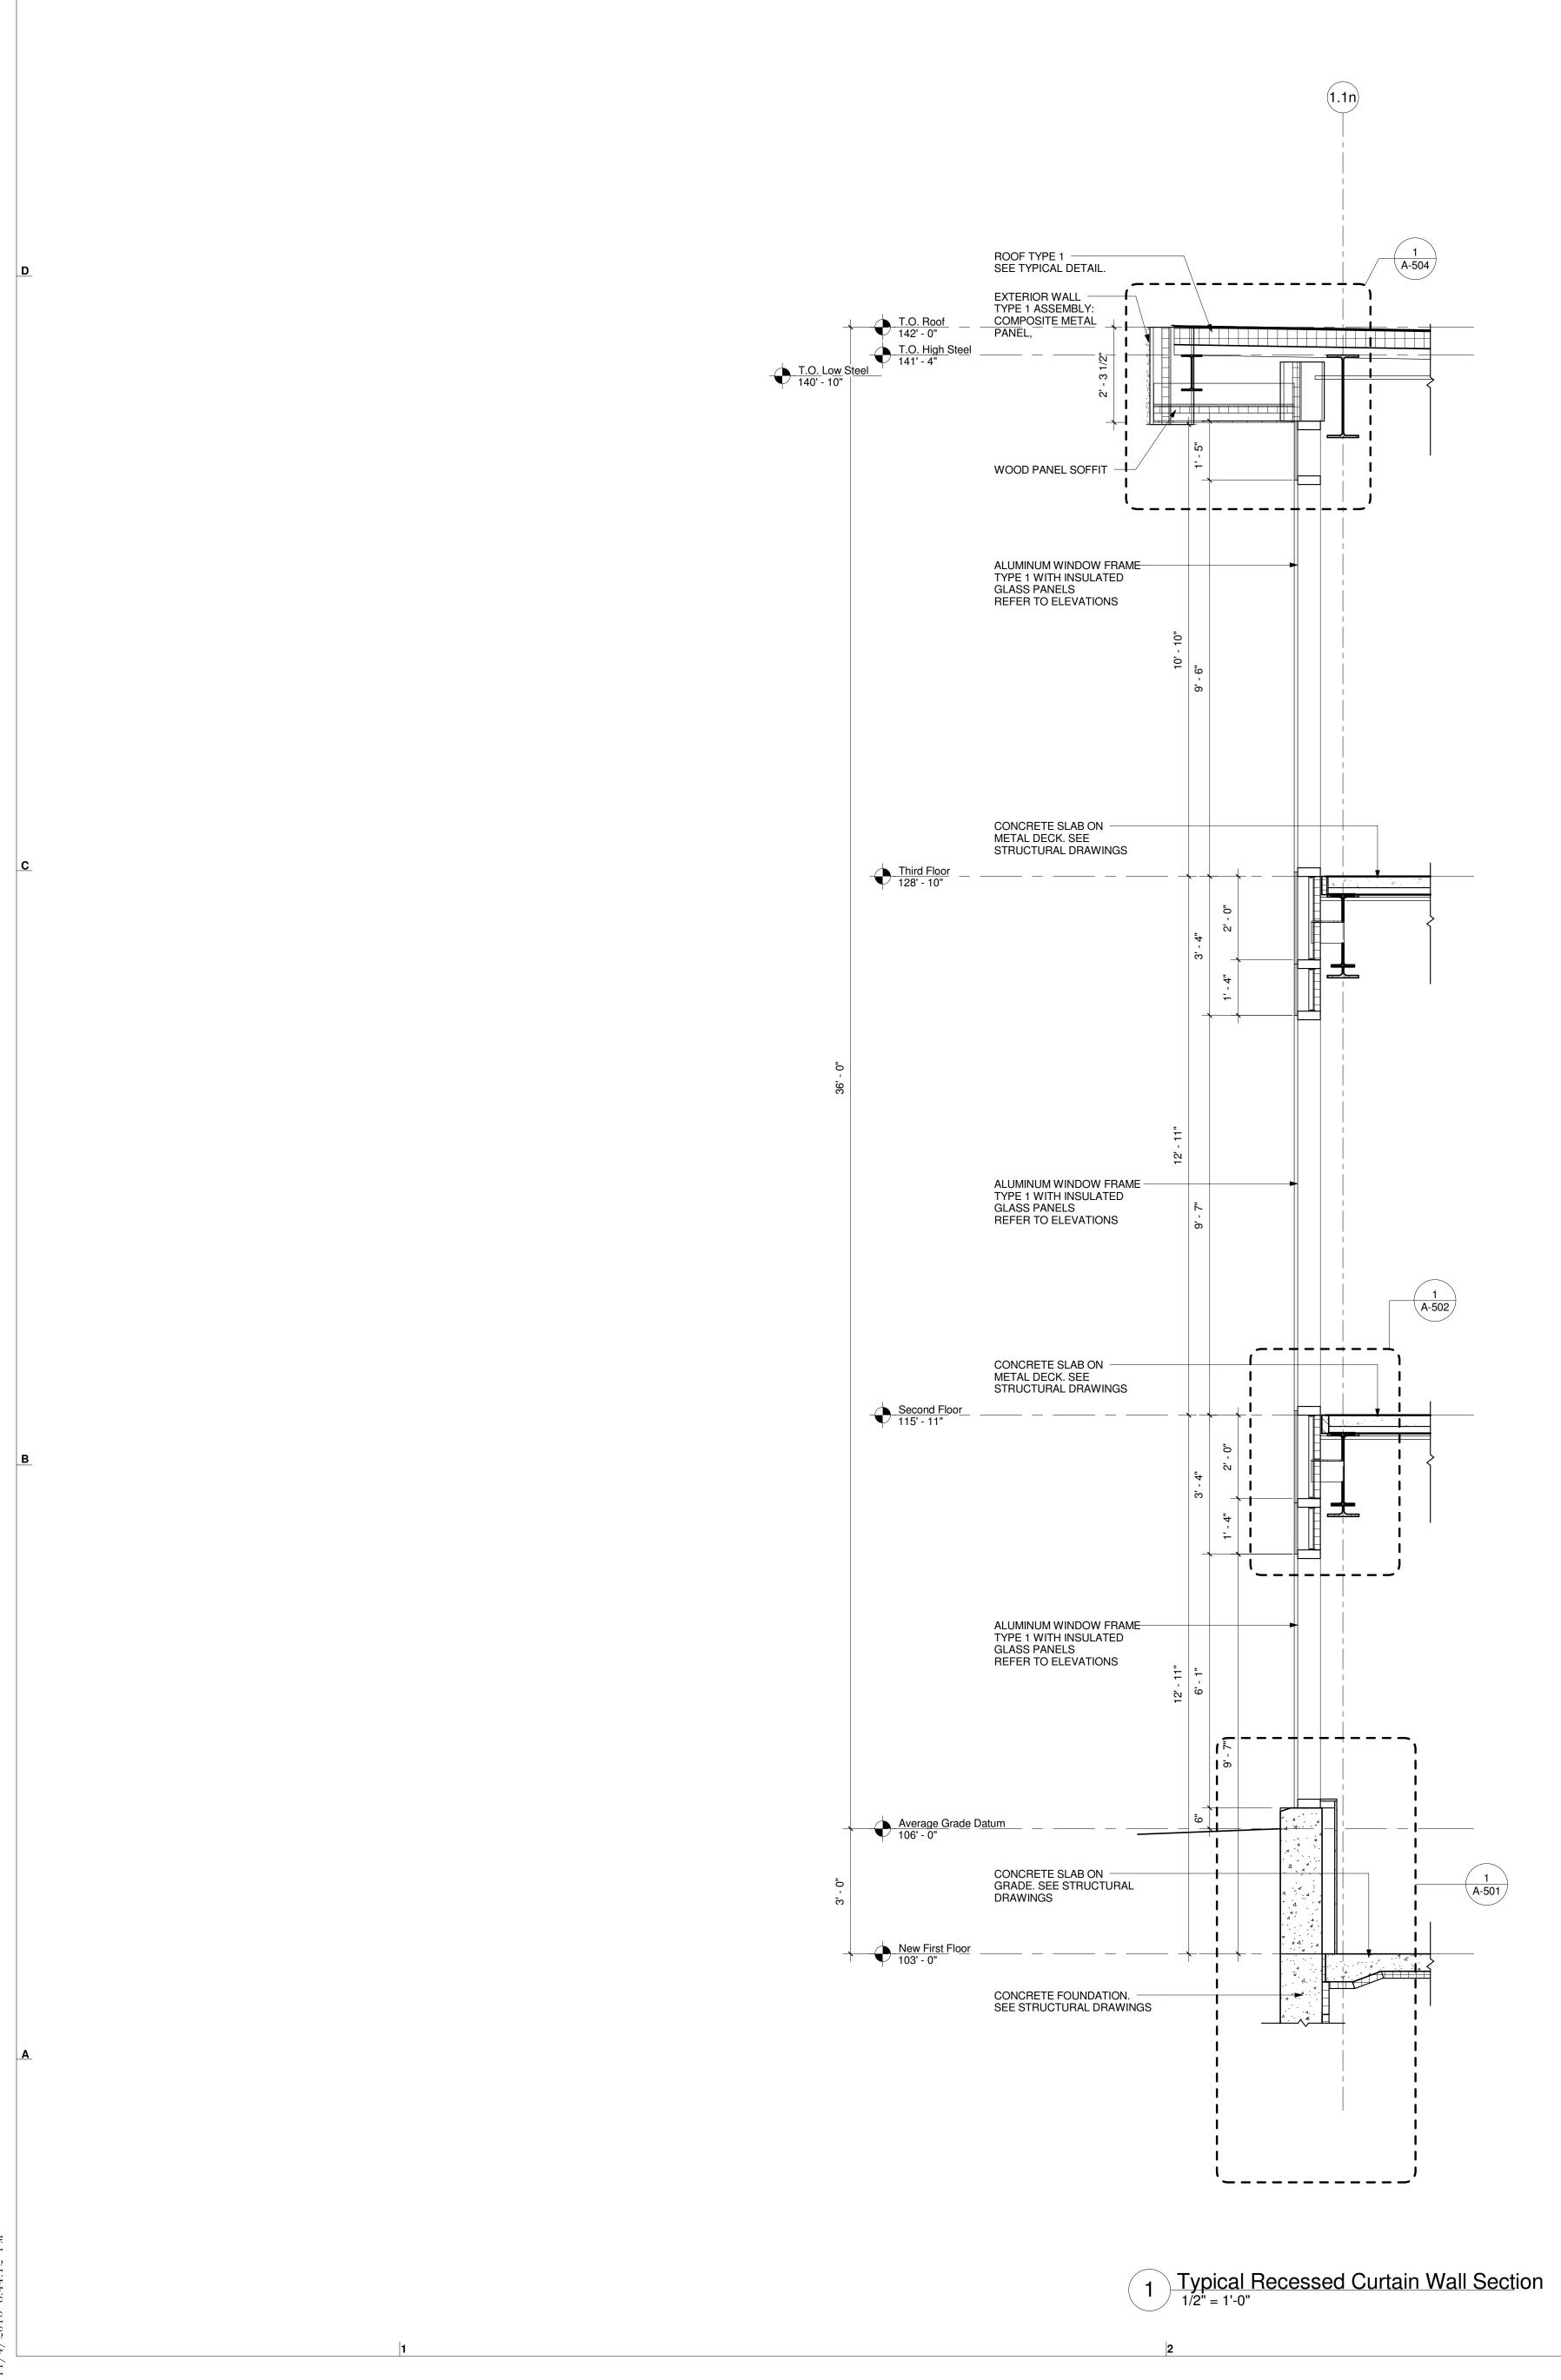
| ROOF TYPE 1 SEE TYPICAL DETAIL | | s |
|---|-----------|-----------|
| EXTERIOR WALL TYPE 1 | | 2' - 3" |
| ASSEMBLY: COMPOSITE METAL PANEL, | - 2" | |
| ALUMINUM WINDOW FRAME TYPE 2 WITH INSULATED GLASS PANELS | 13' | 10' - 11" |
| CONCRETE SLAB ON METAL DECK. SEE STRUCTURAL DRAWINGS | | |
| - Third Floor | | 2' - 0" |
| EXTERIOR WALL TYPE 1 ASSEMBLY: COMPOSITE METAL PANEL | | , |
| ALUMINUM WINDOW FRAME TYPE 2 WITH INSULATED GLASS PANELS | 12' - 11" | 10' - 11" |
| CONCRETE SLAB ON METAL DECK. SEE STRUCTURAL DRAWINGS | | |
| EXTERIOR WALL TYPE 1 ASSEMBLY: COMPOSITE METAL PANEL, | | 2' - 0" |
| ALUMINUM FRAMING AND INSULATED GLASS WINDOW SYSTEM REFER TO ELEVATIONS | 12' - 11" | |
| Average Grade Datum | | |
| CONCRETE SLAB ON 5 GRADE. SEE 5 STRUCTURAL DRAWINGS <u>New First Floor</u> 103' - 0" | | , |
| CONCRETE FOUNDATION. SEE STRUCTURAL DRAWINGS | | |




2 Typical Wall Section at Storefront


3 Typical Wall Section at Wood Panel

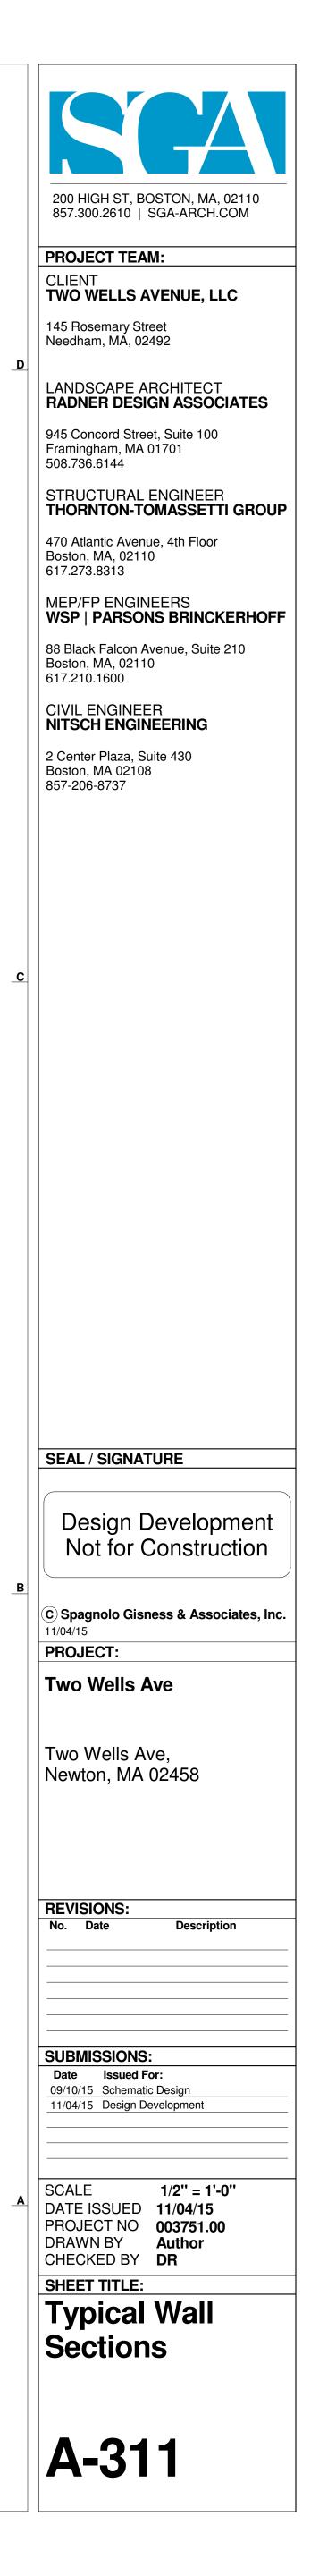


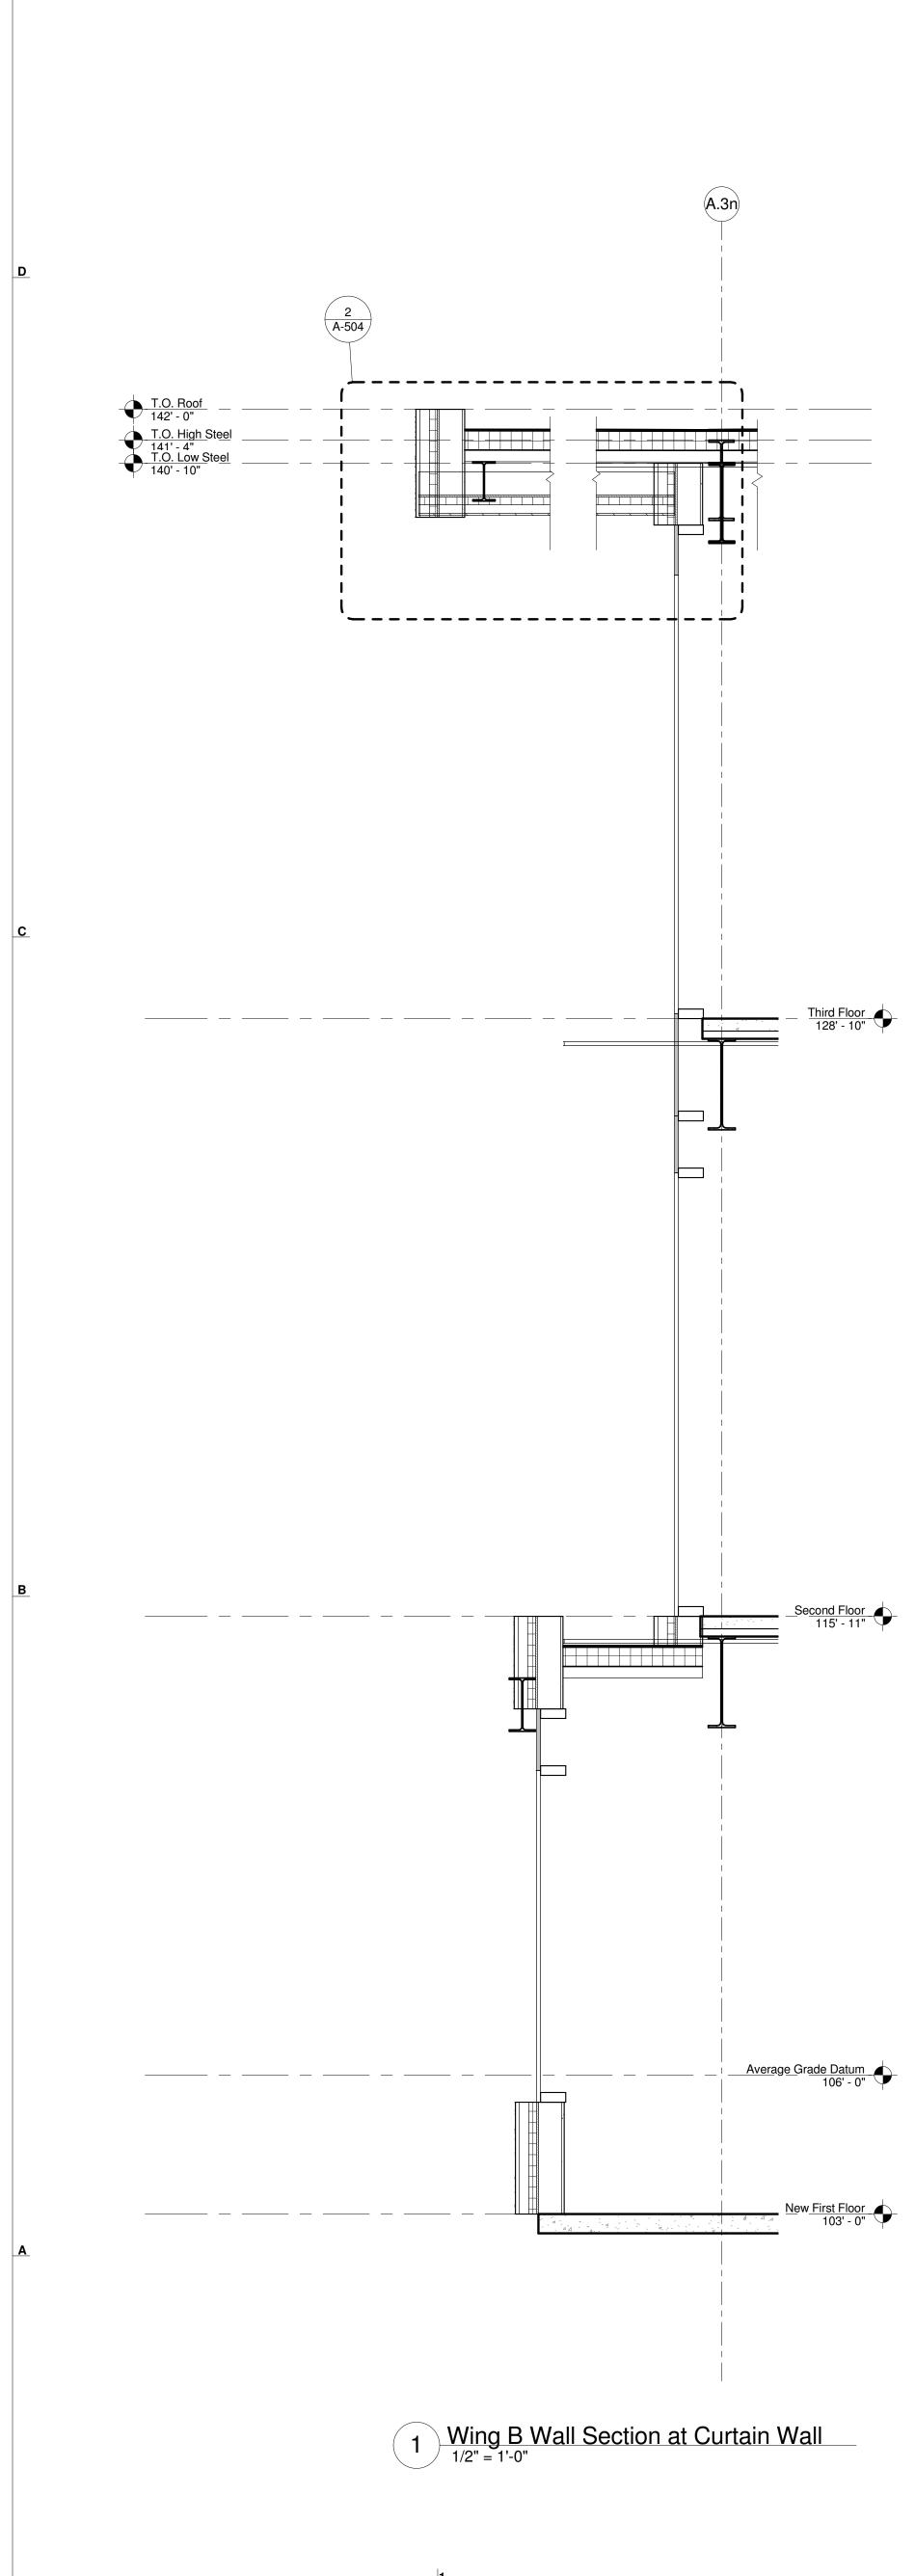



2 Wing B Wall Section at Vestibule

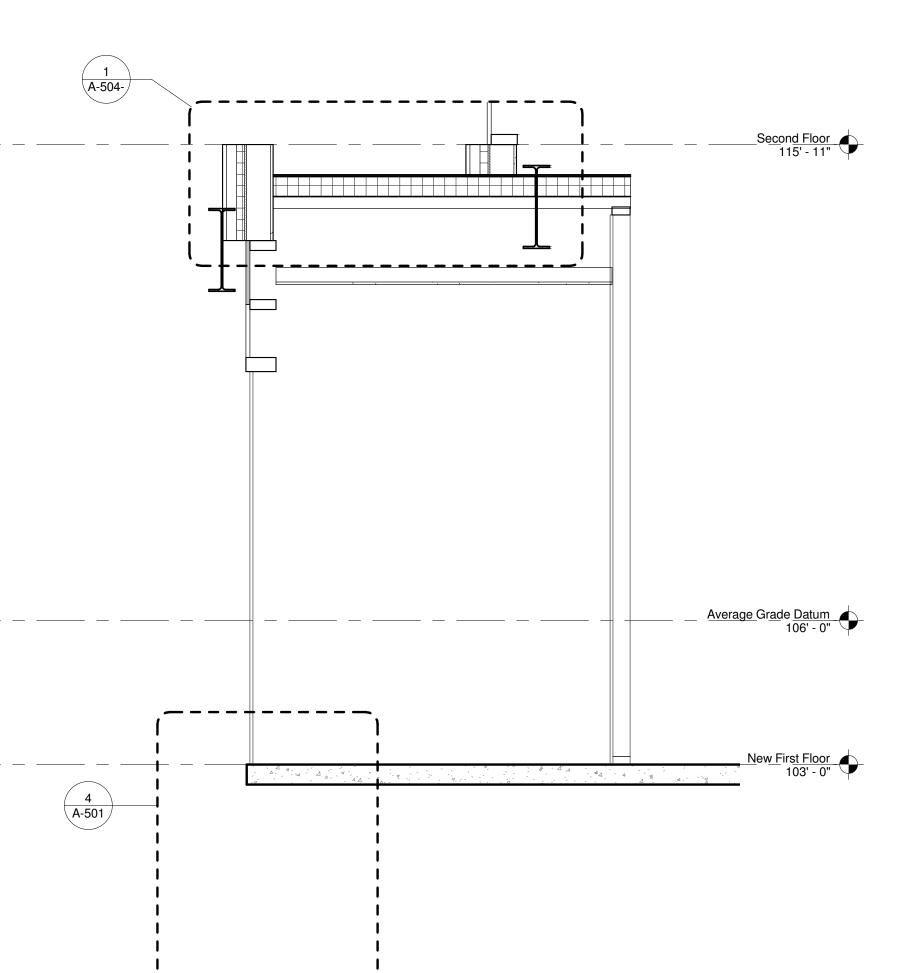


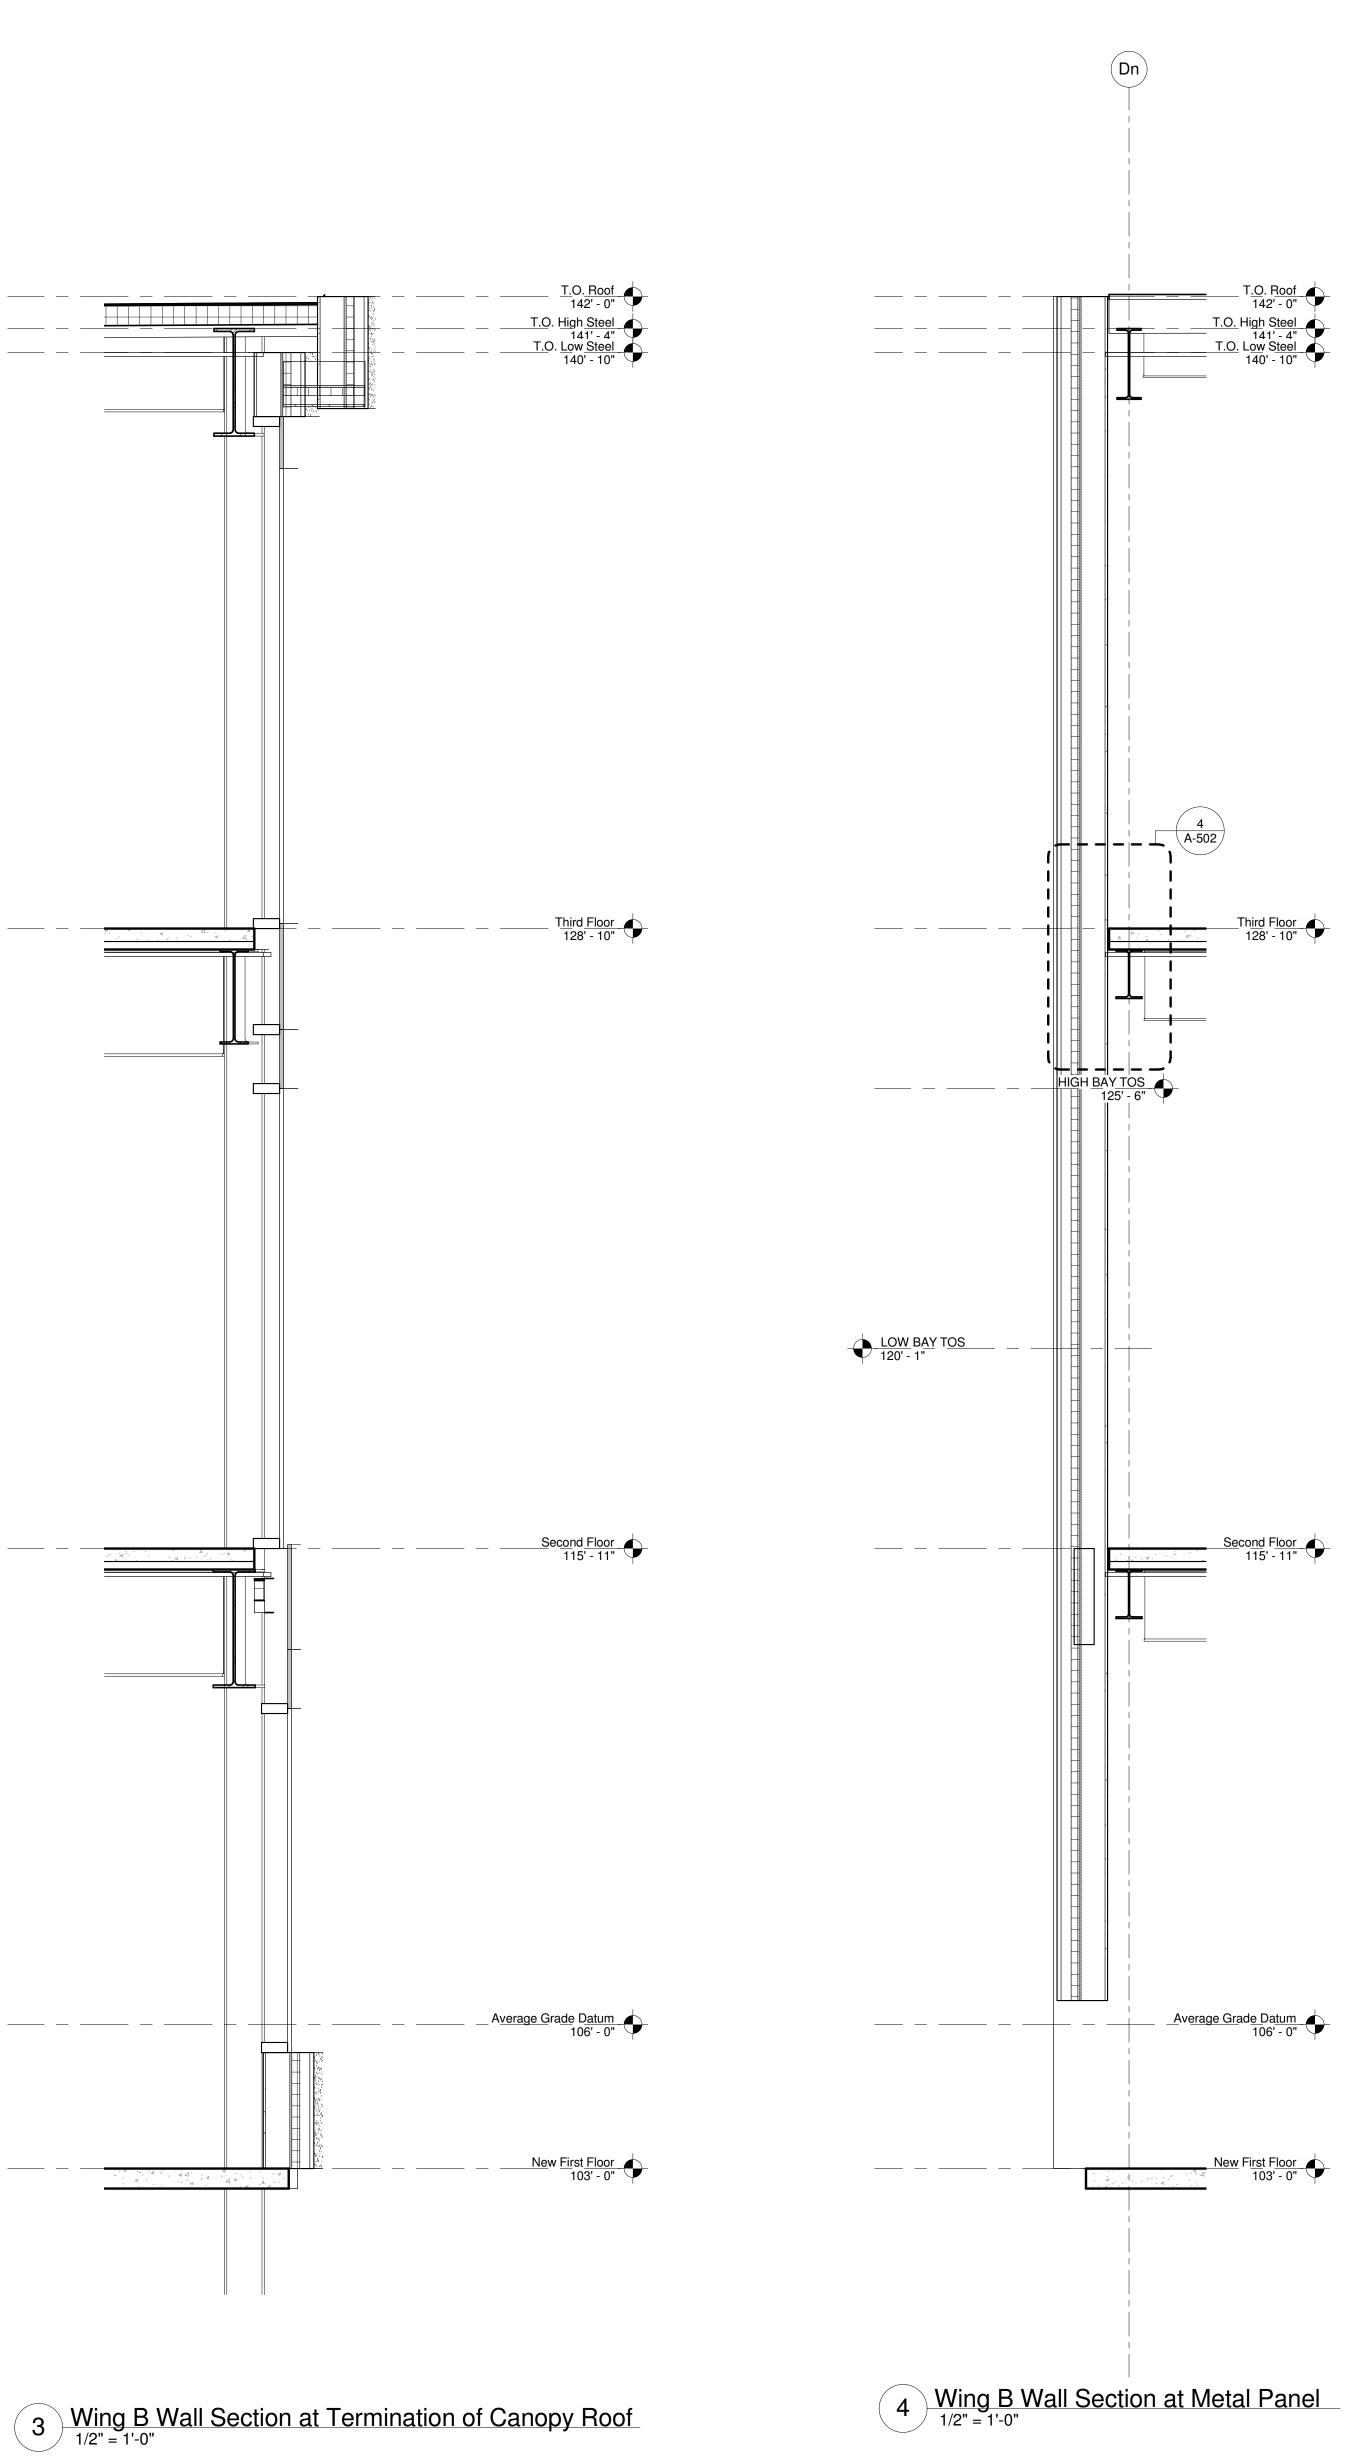


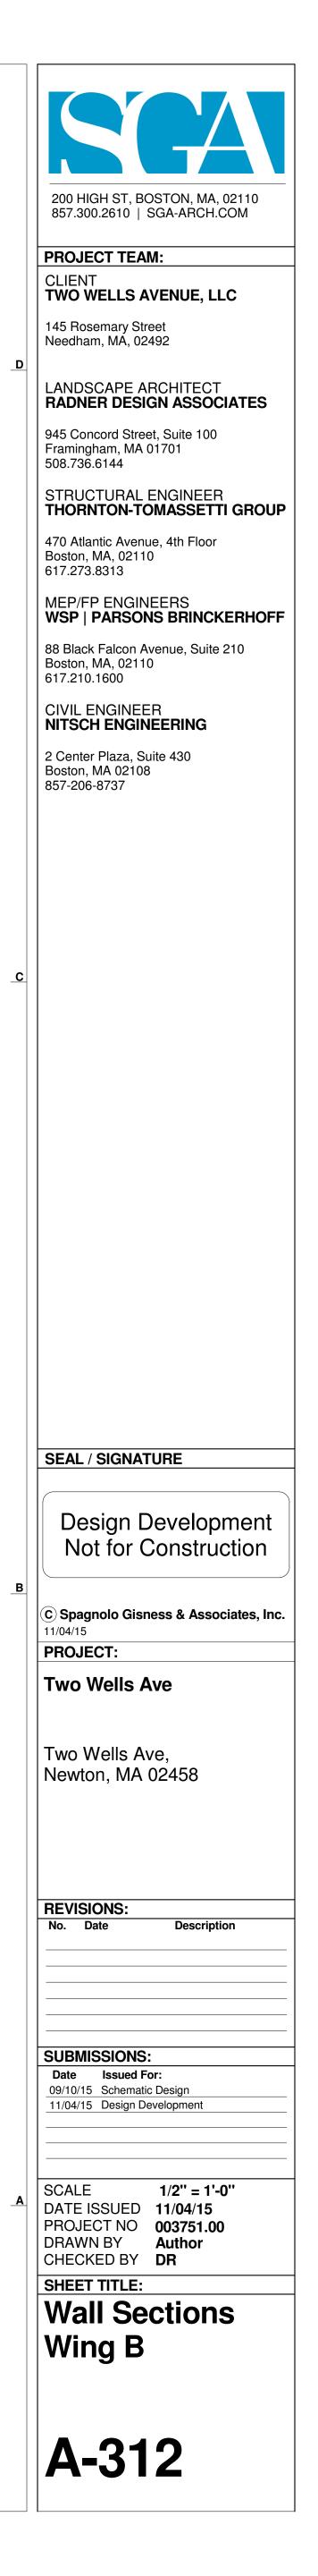

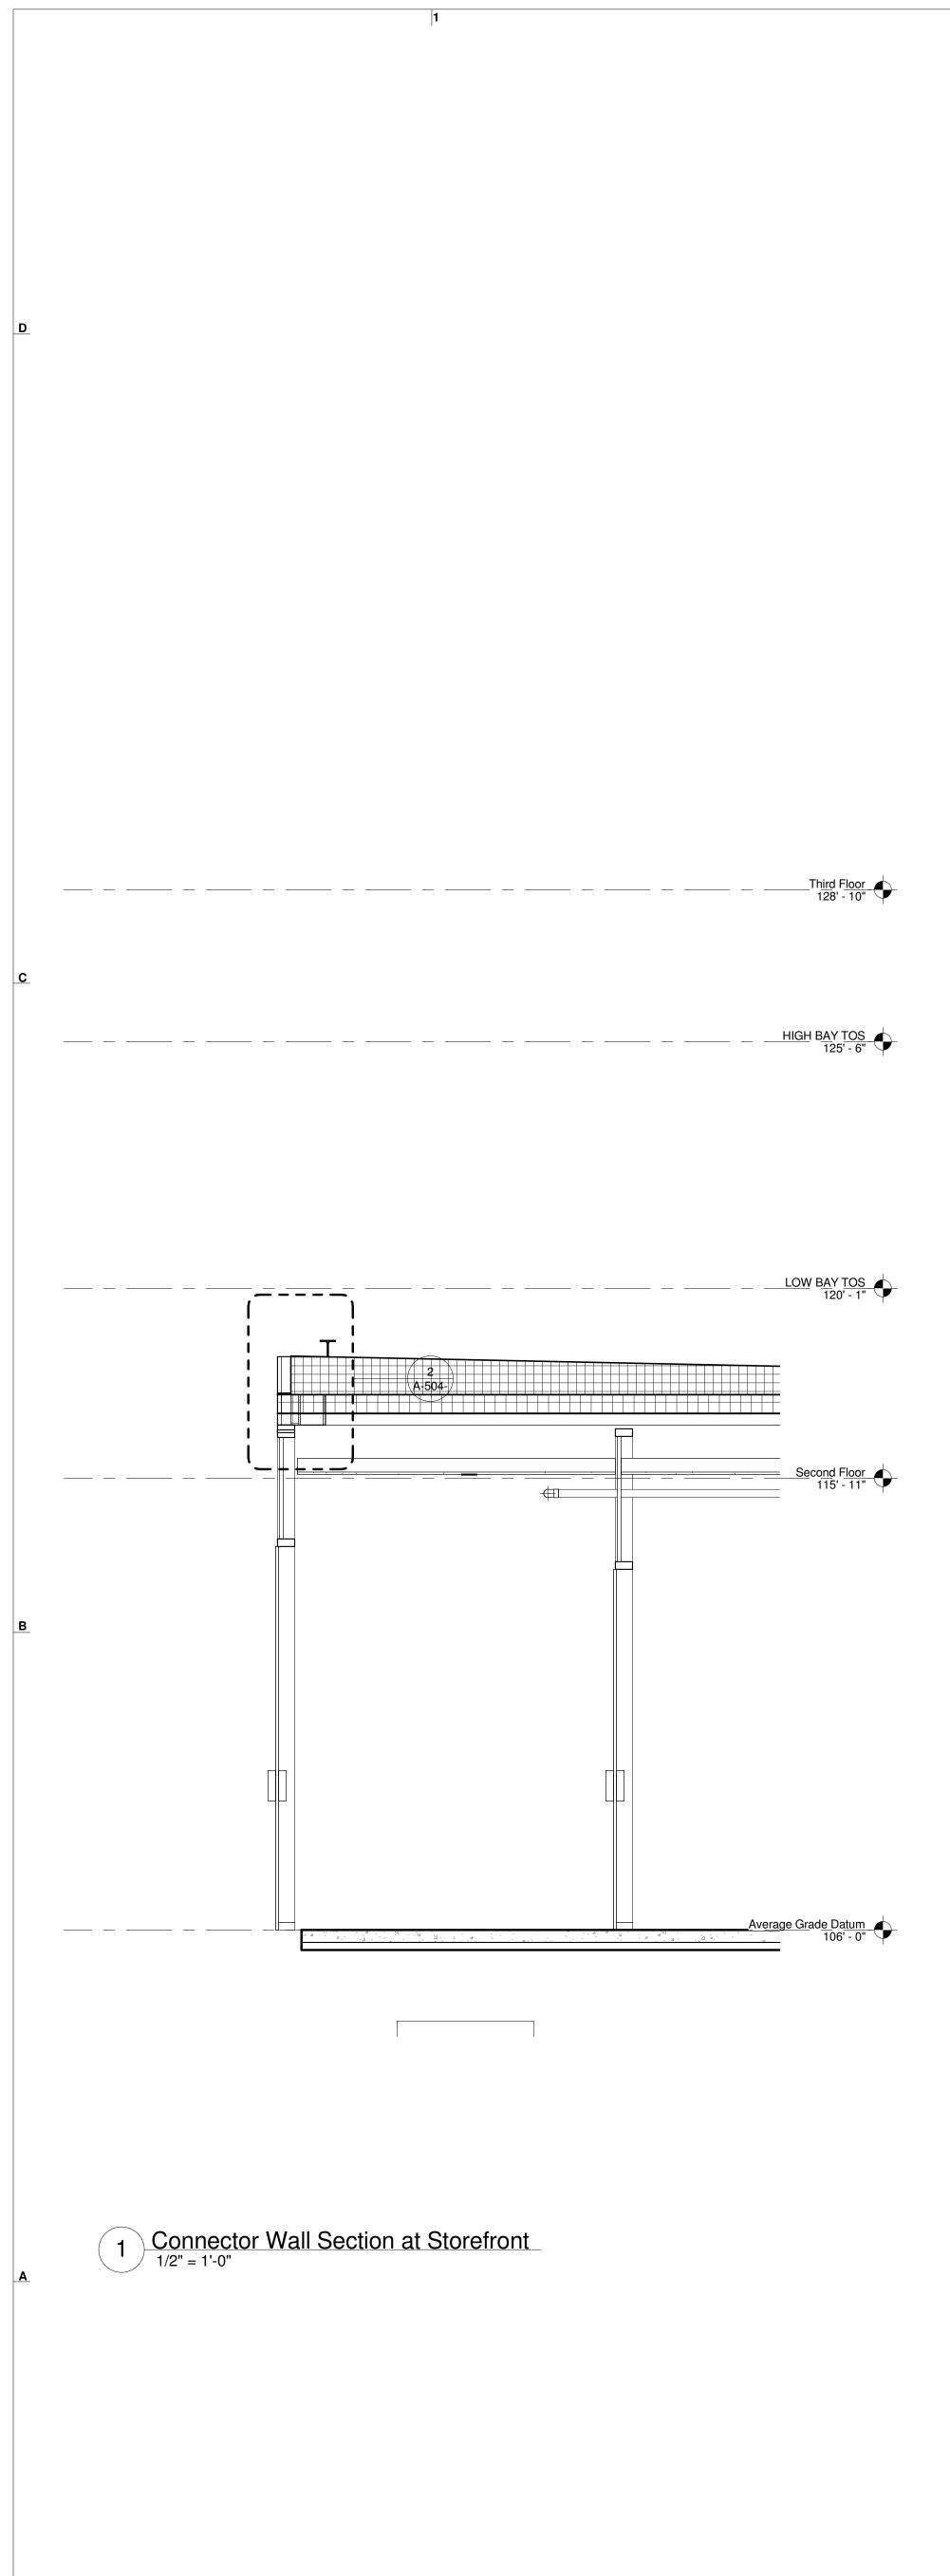


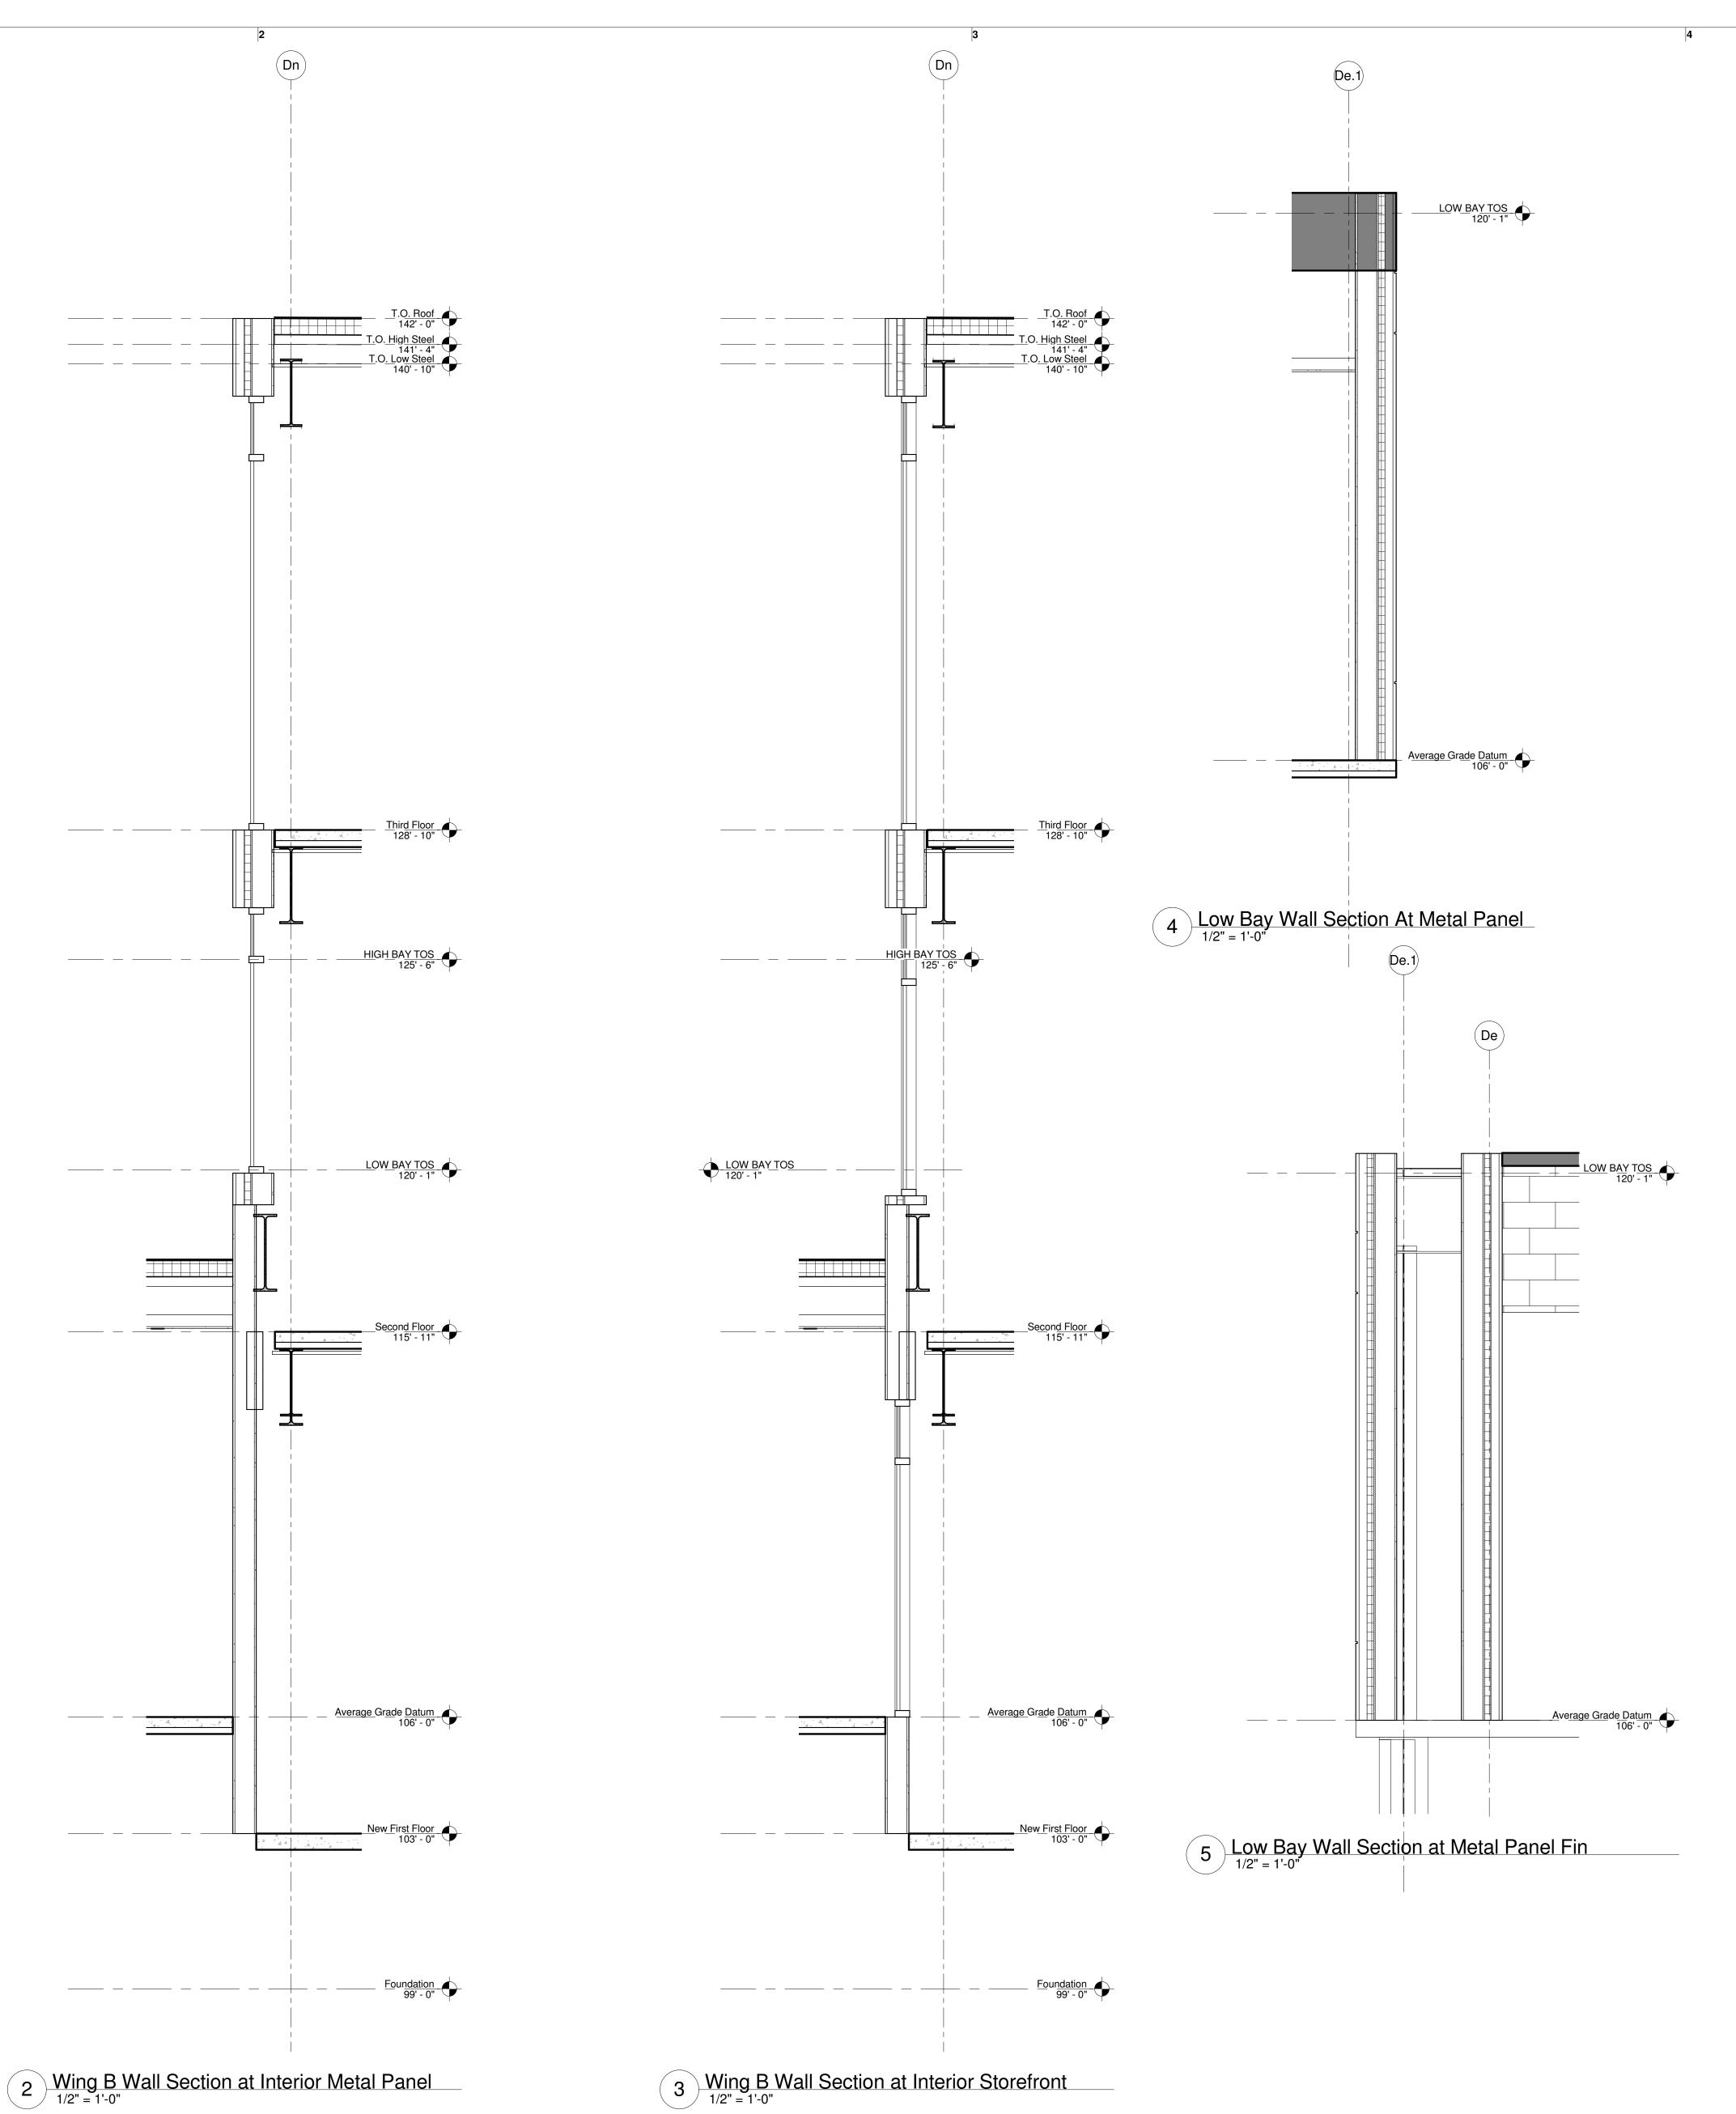


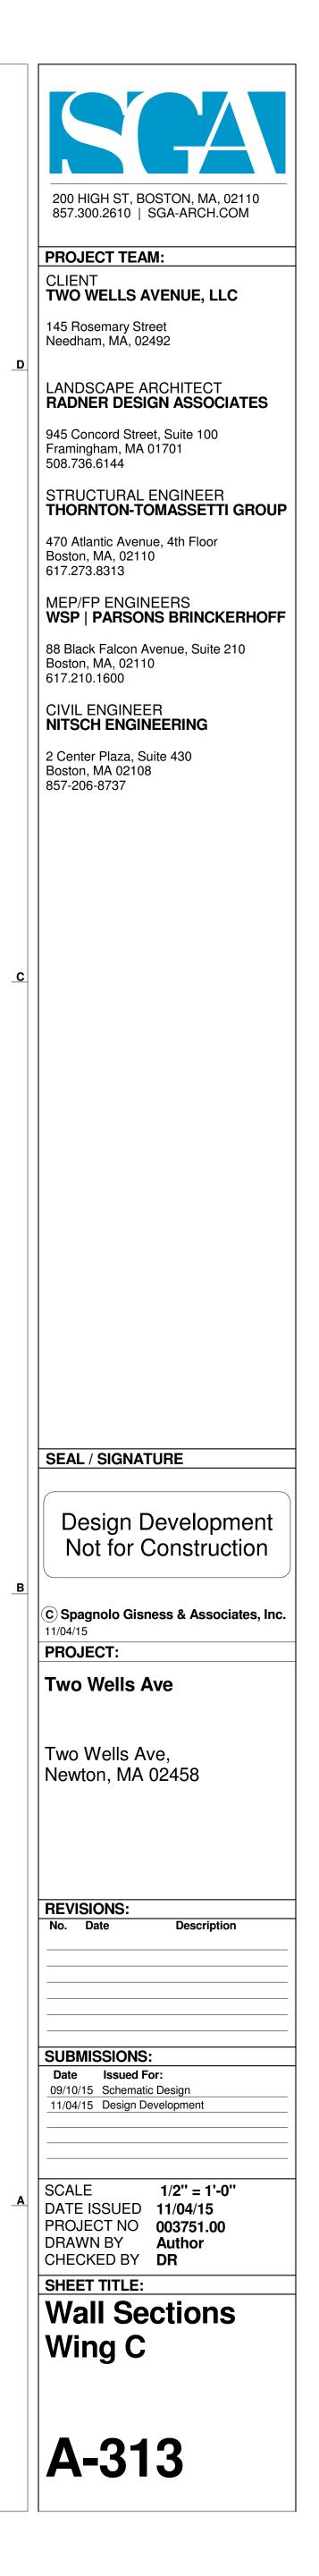


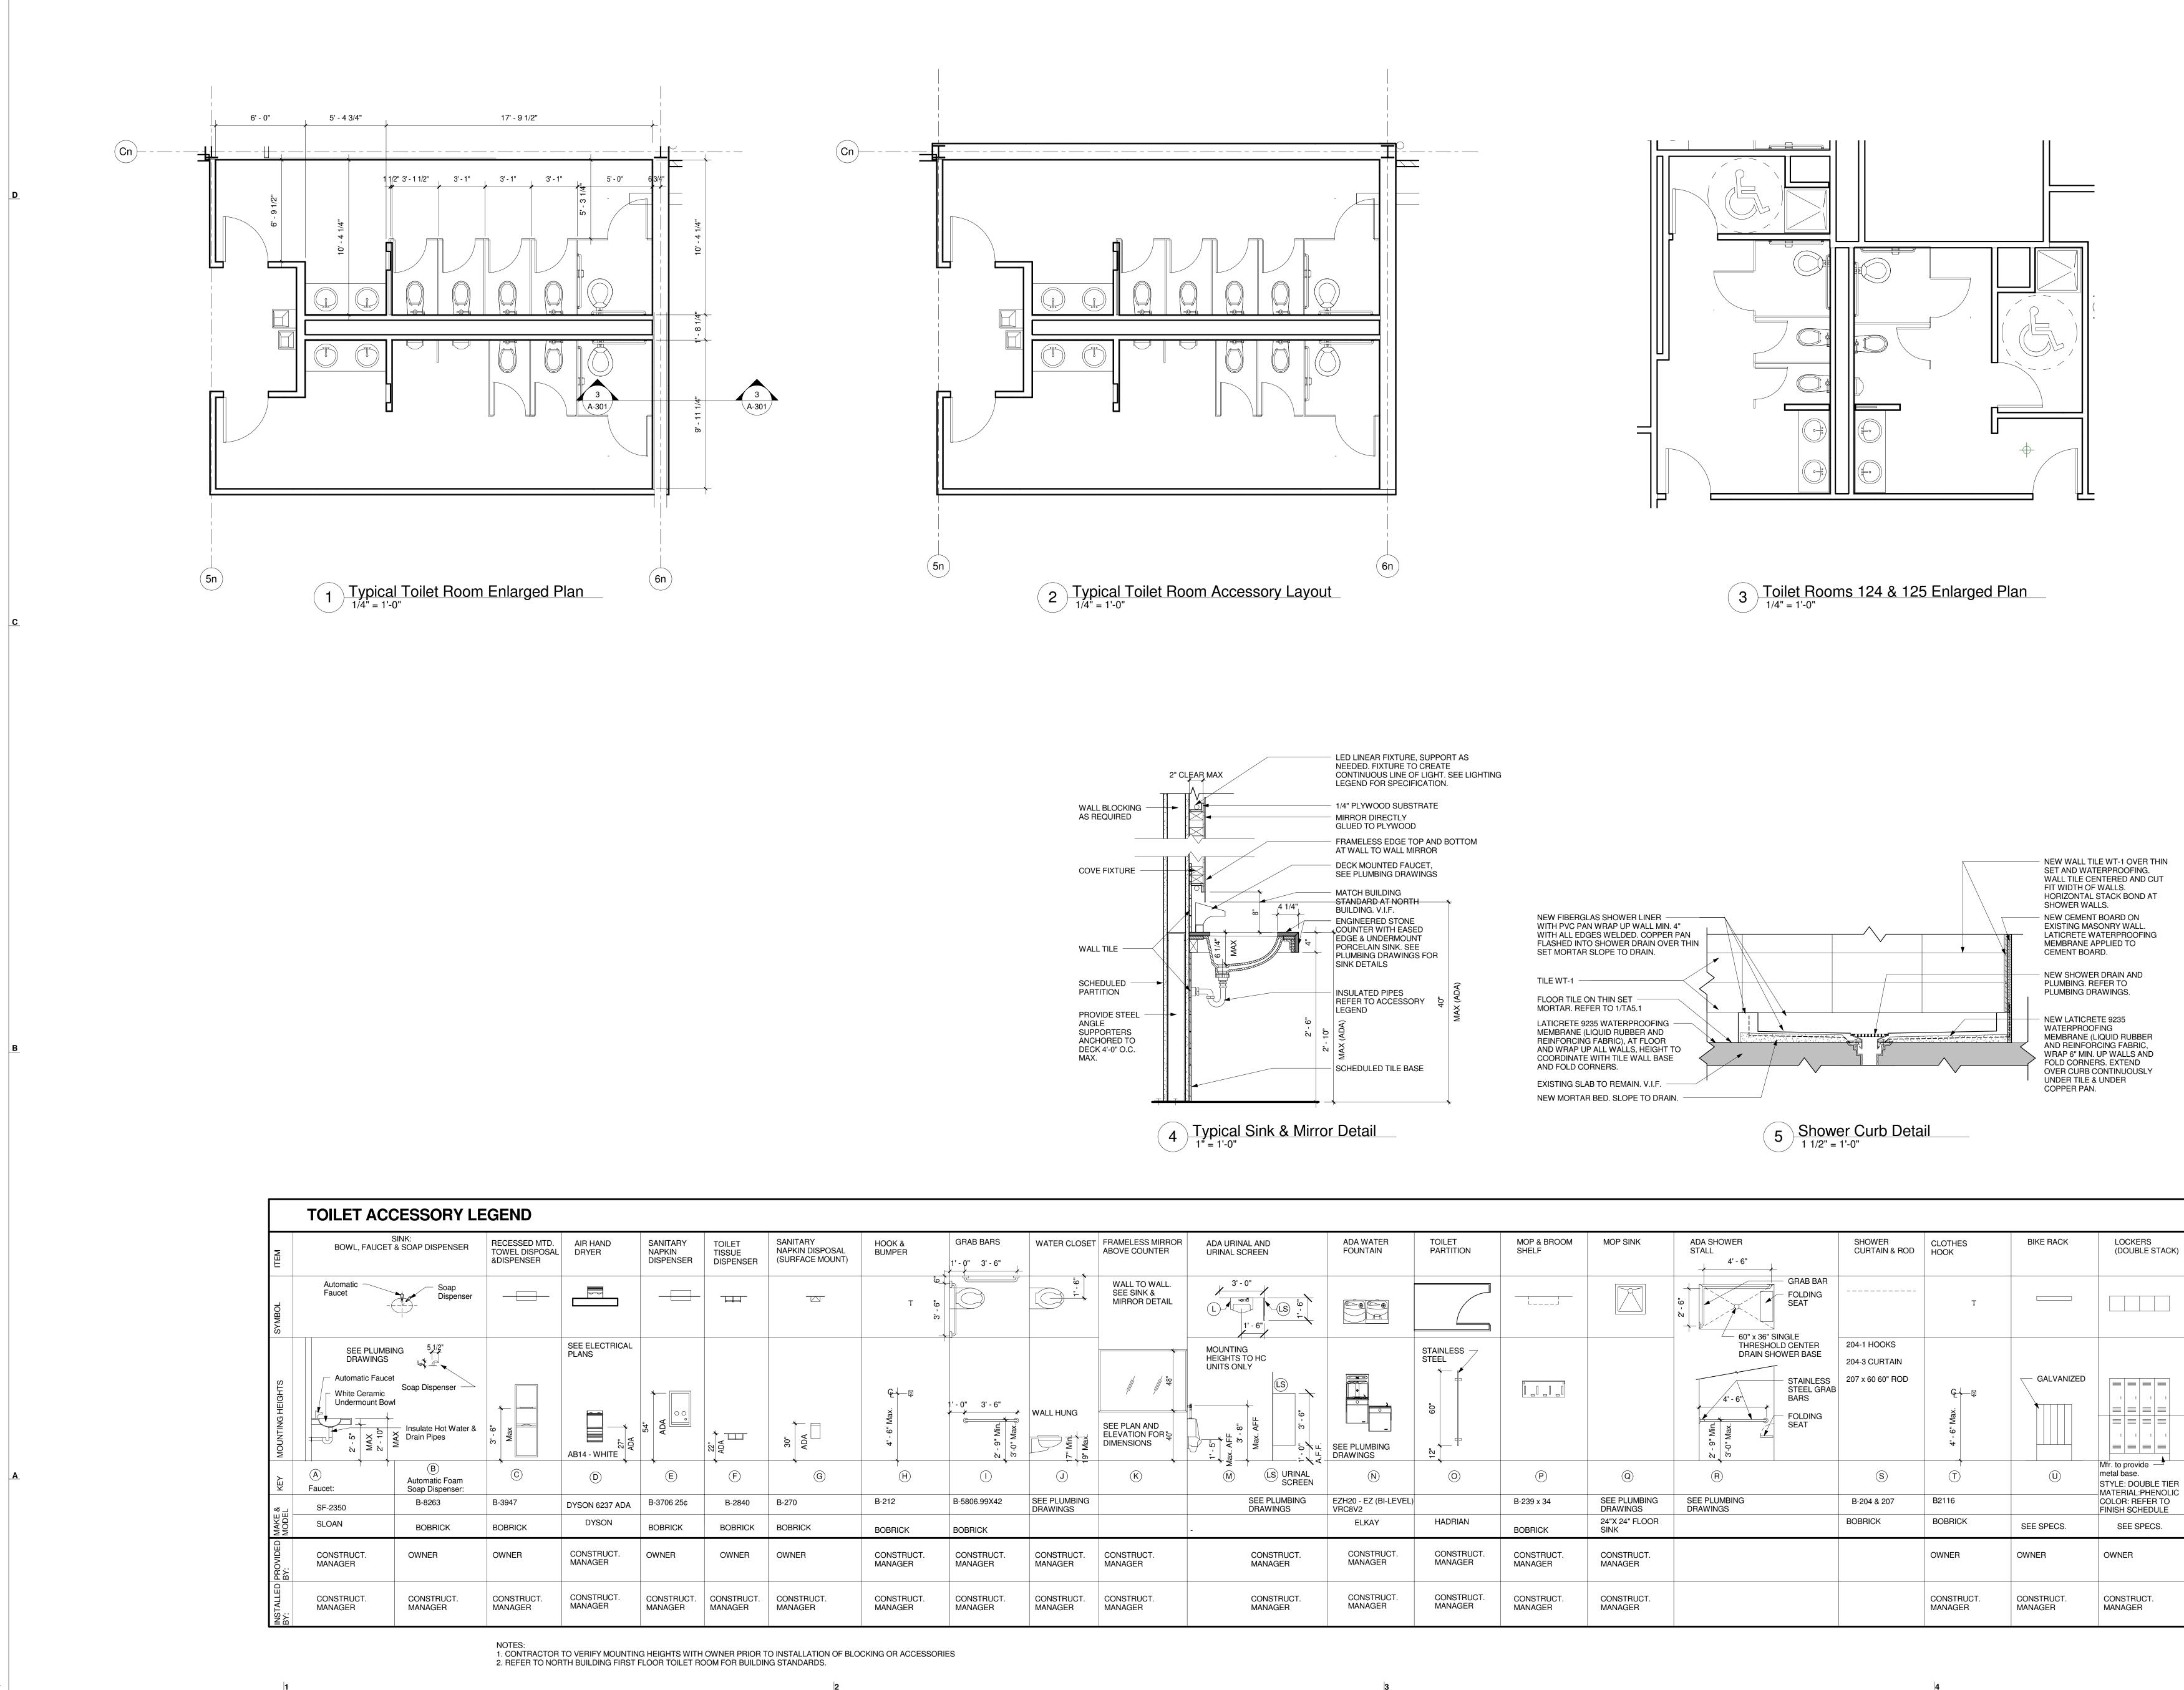



| r ER | TOILET TISSUE DISPENSER | SANITARY NAPKIN DISPOSAL (SURFACE MOUNT) | HOOK & BUMPER | GRAB BARS 1' - 0" 3' - 6" | WATER CLOSET | FRAMELESS MIRROR ABOVE COUNTER | ADA URINAL AND URINAL SCREEN | ADA WATER FOUNTAIN | toil Par |
|---------|-------------------------------|--|-----------------------|------------------------------|--------------------------|---|---|---------------------------------|-----------------|
| | | | io_ | | ٥ | WALL TO WALL. | 3' - 0" | | |
| | | -23- | ತ್ T ಸ. | | | SEE SINK & MIRROR DETAIL | | | |
| | | | | | | - | | | |
| | | | | | | | MOUNTING HEIGHTS TO HC UNITS ONLY | | STAINI STEEL |
| | | | ଢ଼ୣ୕ୣୄ୷ୣଢ଼ | | | 48" | | | |
| | | | lax. | 1'-0" 3'-6" | WALL HUNG | ļ | ц | | 60" |
| | | 30" ADA | 4' - 6" Max. | 2' - 9" Min. | Max. | SEE PLAN AND ELEVATION FOR 5 DIMENSIONS | 3, AF 8 | | _ + |
| | | | | ື່ ທີ່ | | | A, F, C, Max, AFF A, F, C, Max, AFF A, F, F, C, A, AFF A, F, C, C, C, A, | DRAWINGS | 12 |
| | F | G | H | | J | K | M LS URINAL SCREEN | N | |
| ¢ | B-2840 | B-270 | B-212 | B-5806.99X42 | SEE PLUMBING DRAWINGS | | SEE PLUMBING DRAWINGS | EZH20 - EZ (BI-LEVEL) VRC8V2 | |
| | BOBRICK | BOBRICK | BOBRICK | BOBRICK | | | - | ELKAY | HA |
| | OWNER | OWNER | CONSTRUCT. MANAGER | CONSTRUCT. MANAGER | CONSTRUCT. MANAGER | CONSTRUCT. MANAGER | CONSTRUCT. MANAGER | CONSTRUCT. MANAGER | CC MA |
| CT. | CONSTRUCT. MANAGER | CONSTRUCT. MANAGER | CONSTRUCT. MANAGER | CONSTRUCT. MANAGER | CONSTRUCT. MANAGER | CONSTRUCT. MANAGER | CONSTRUCT. MANAGER | CONSTRUCT. MANAGER | CC MA |
| | I | | | | 1 | 1 | 1 | 1 | 1 |

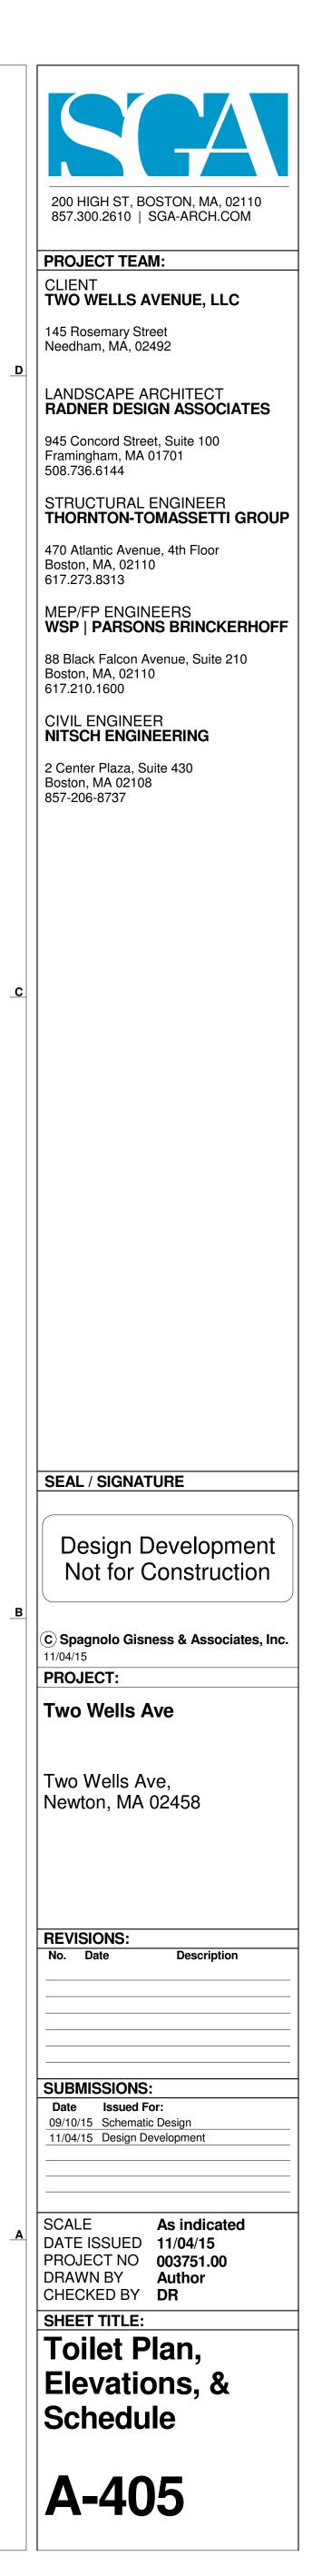


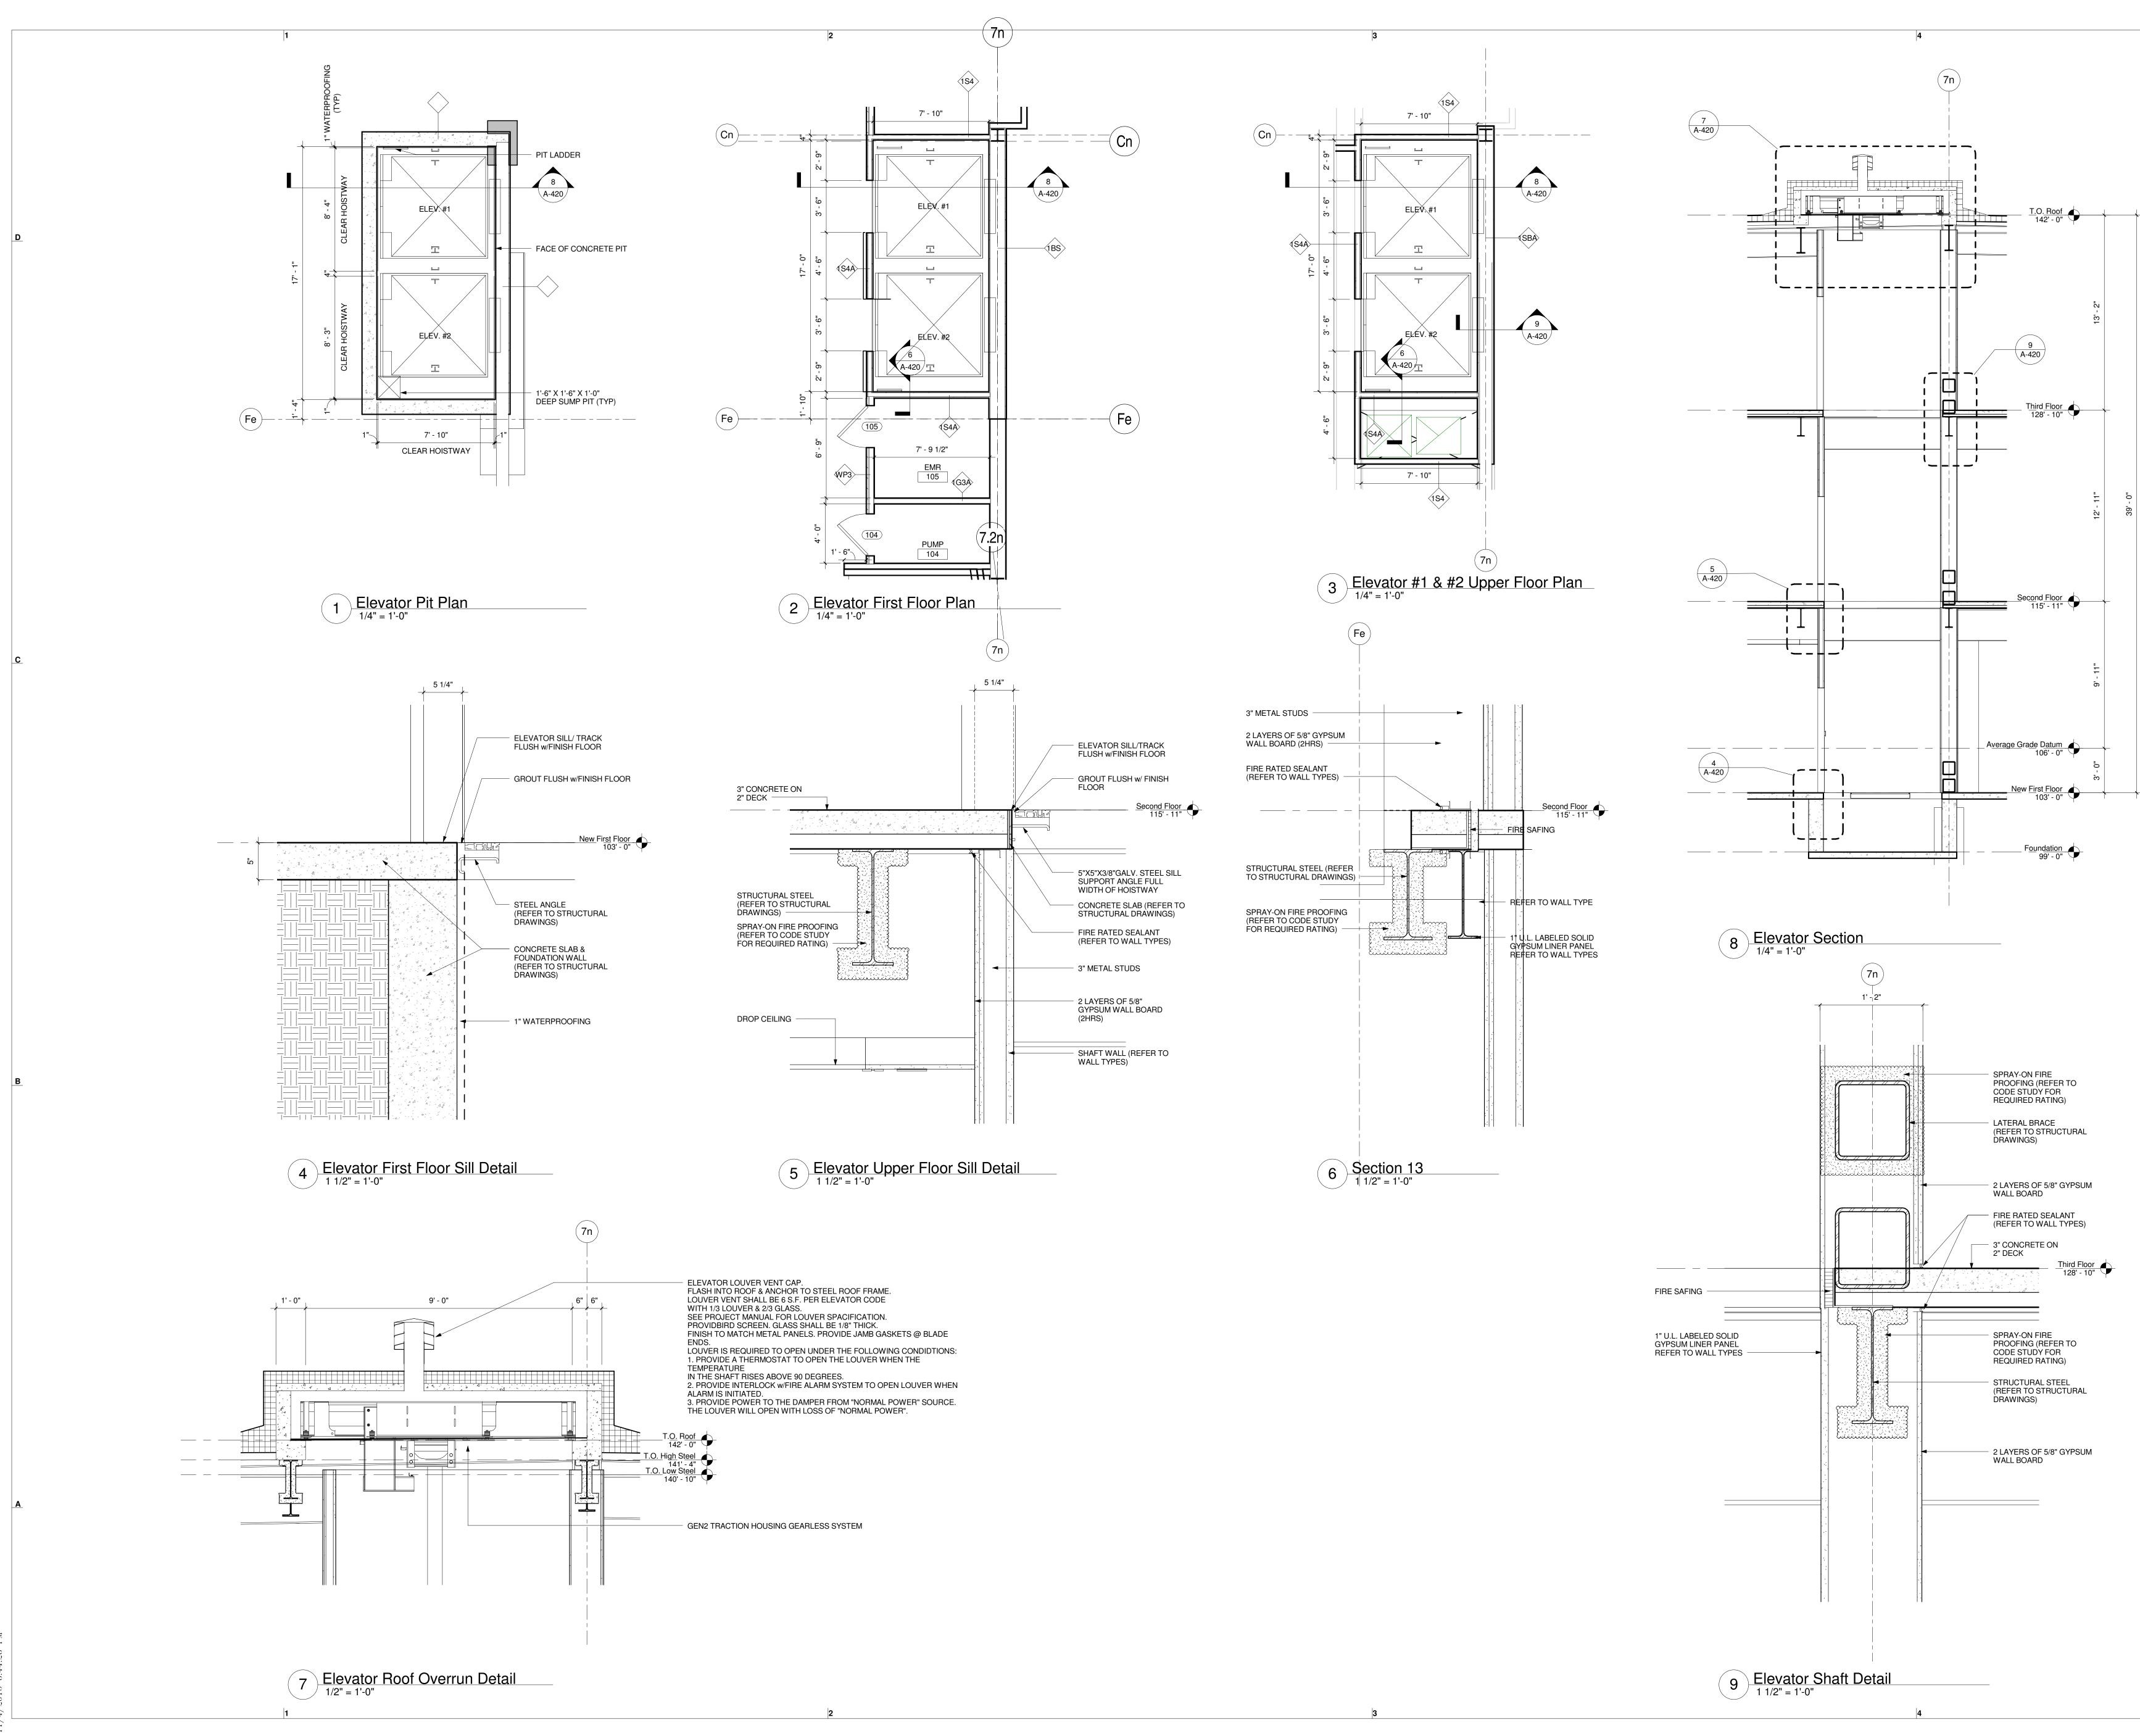


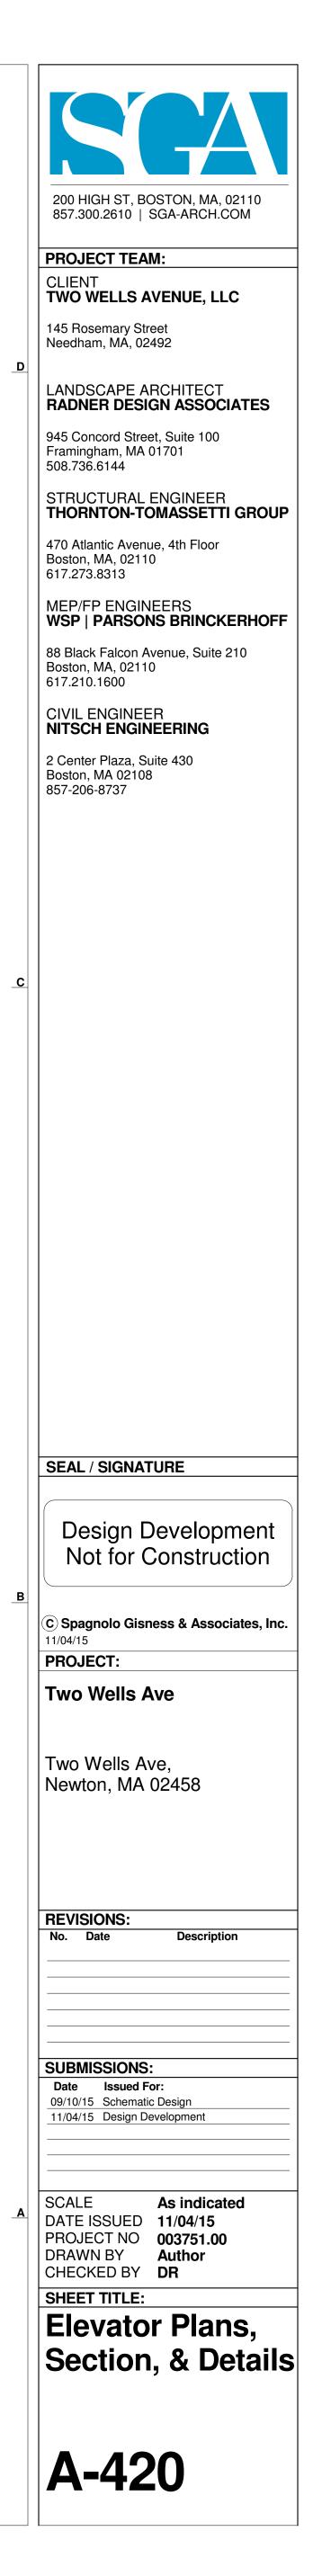


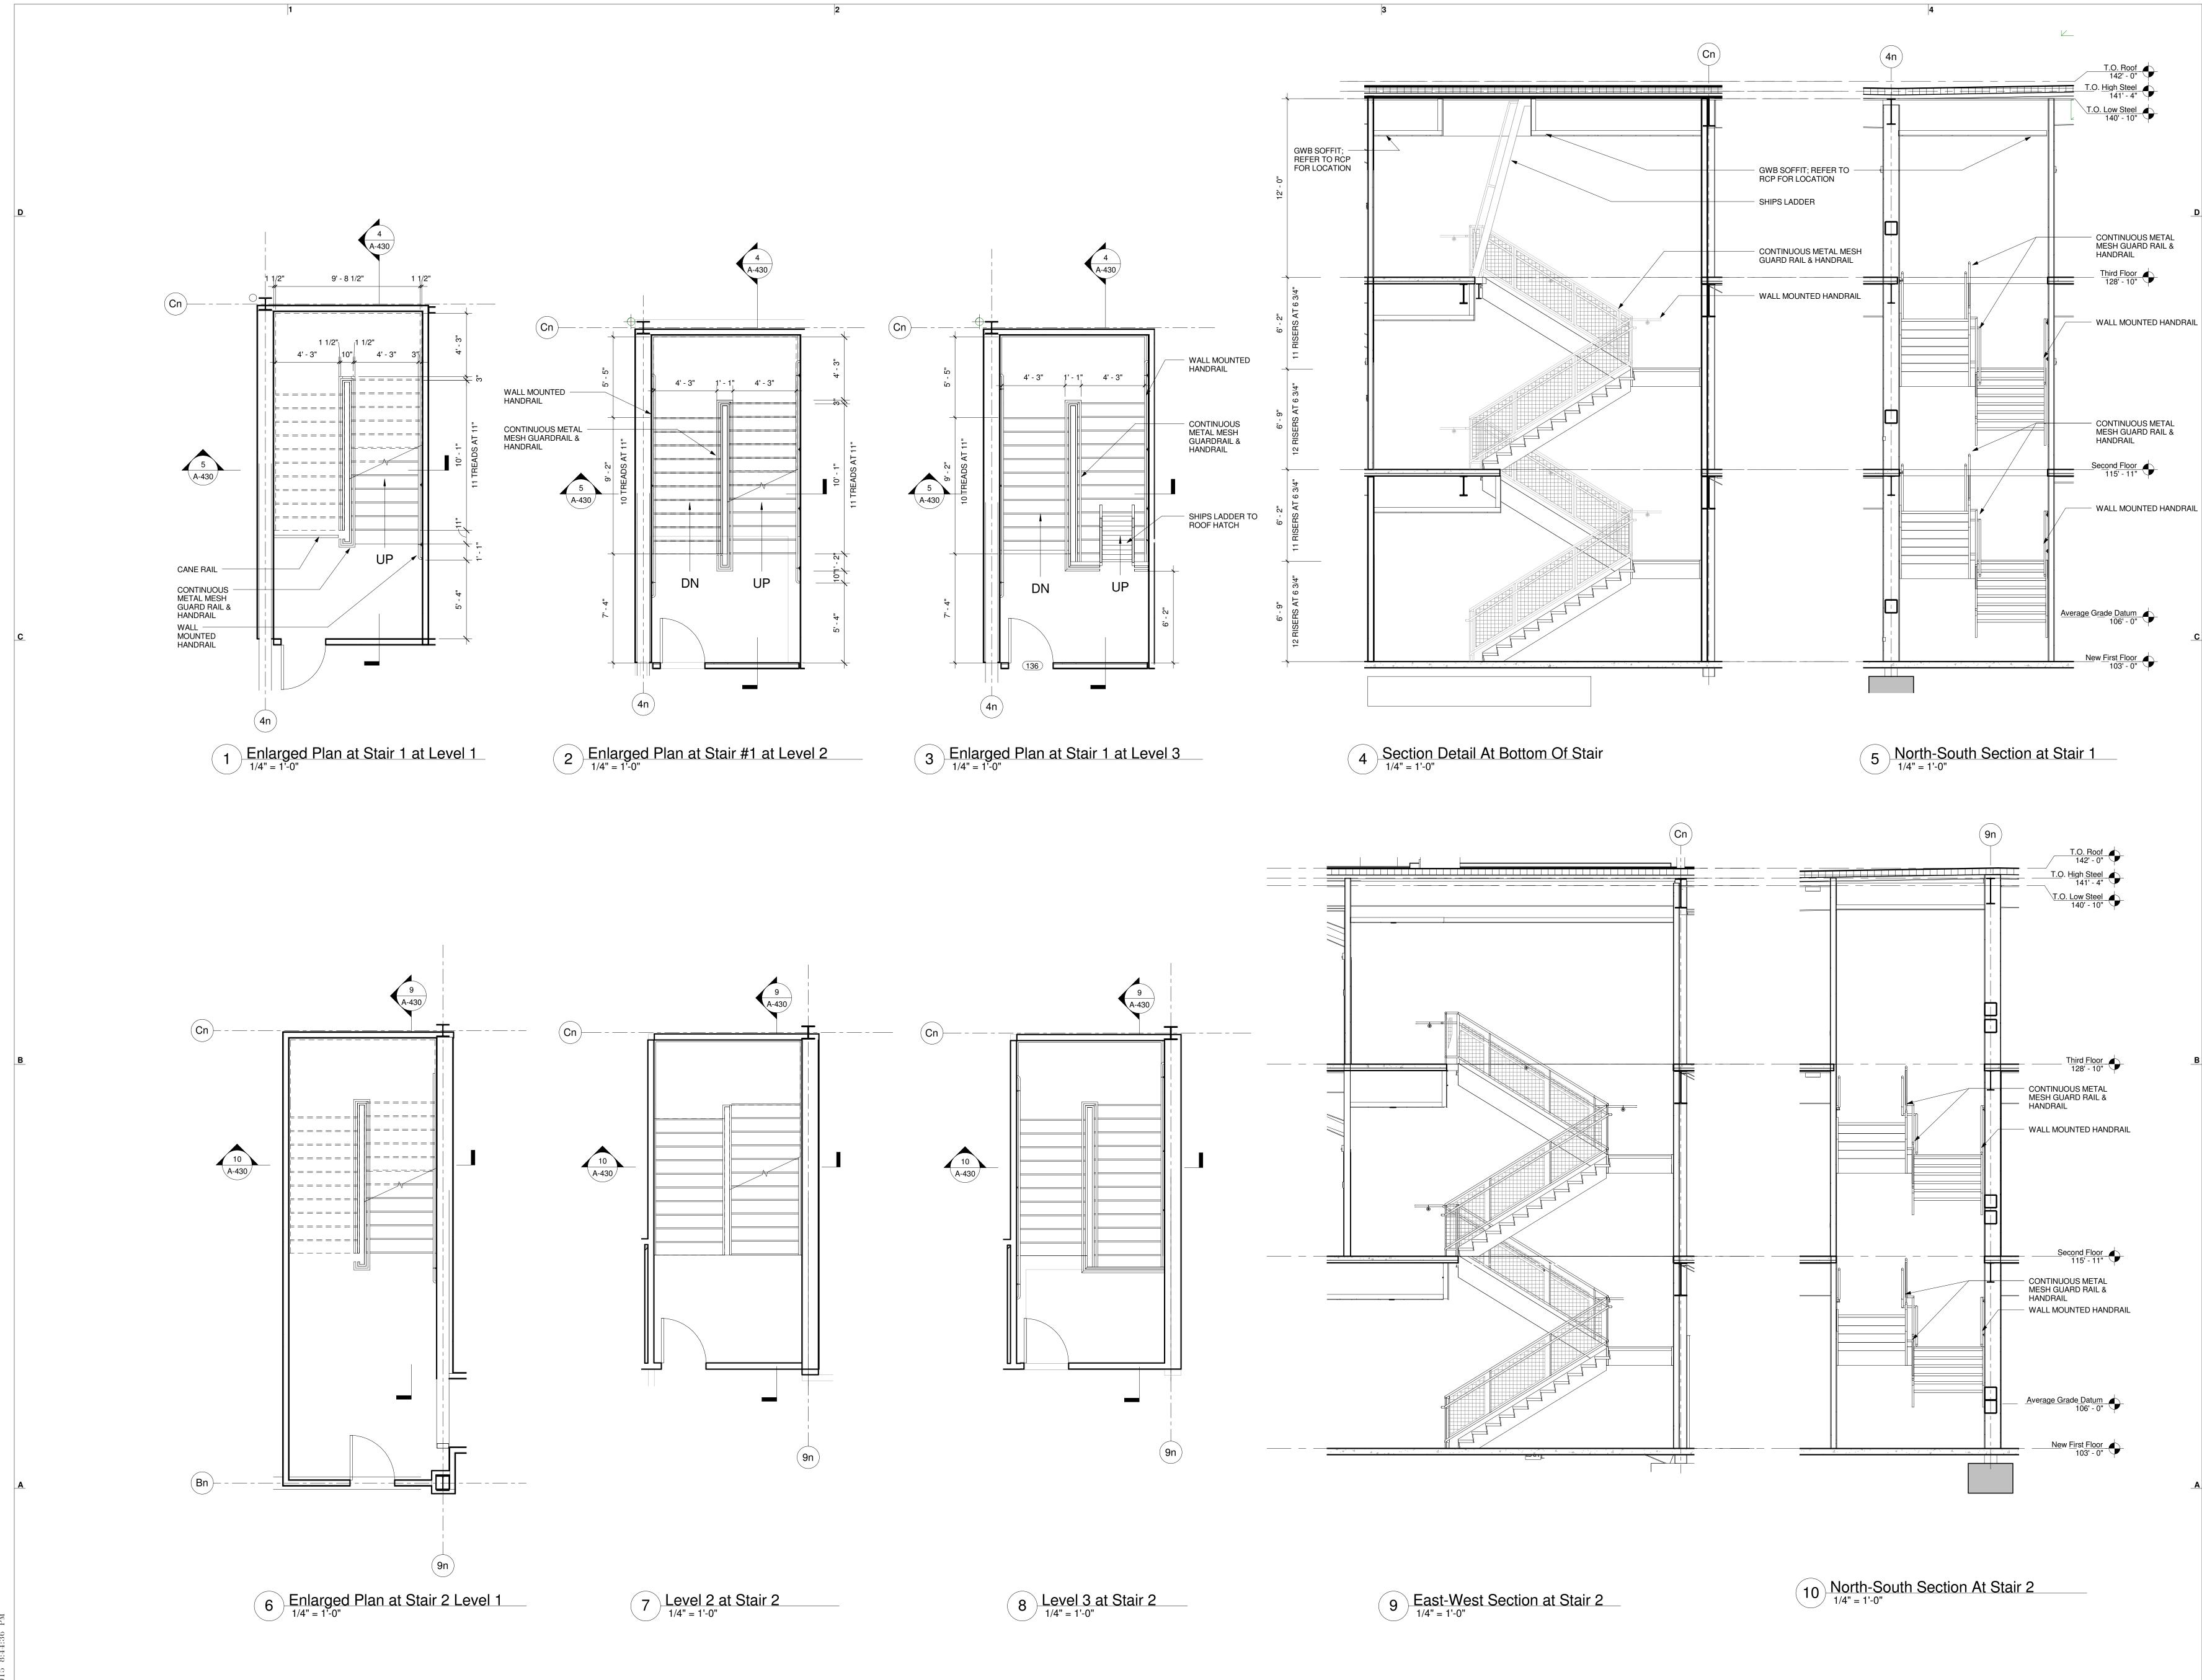

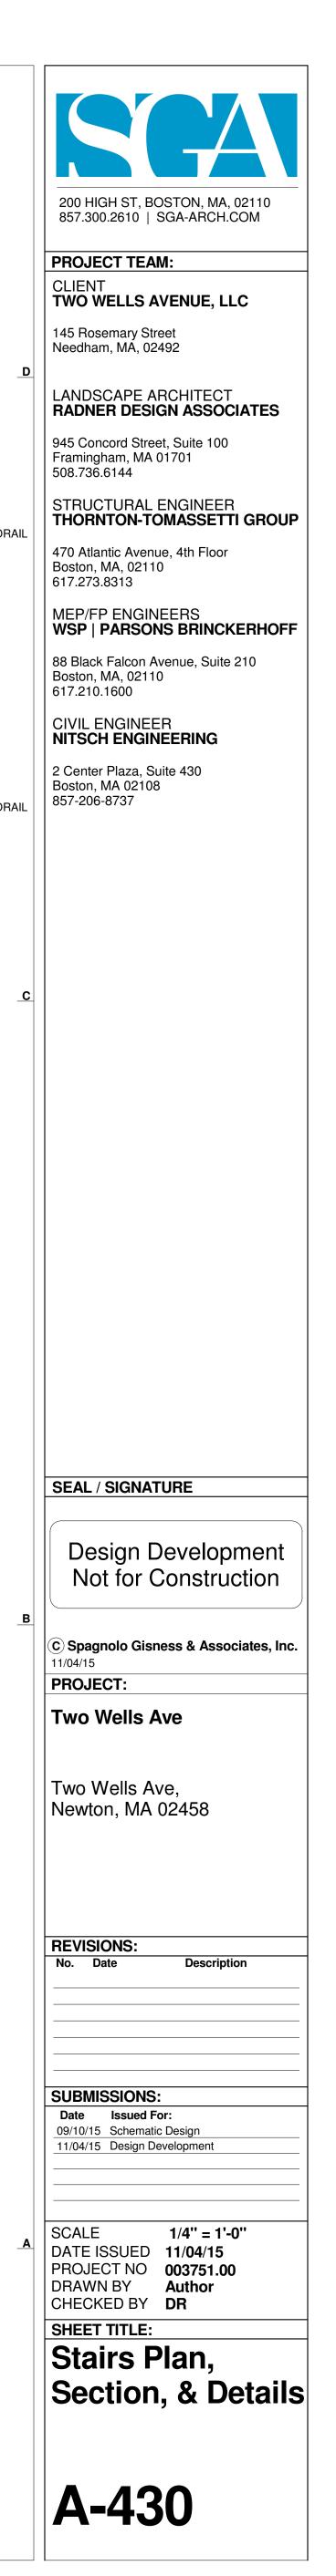


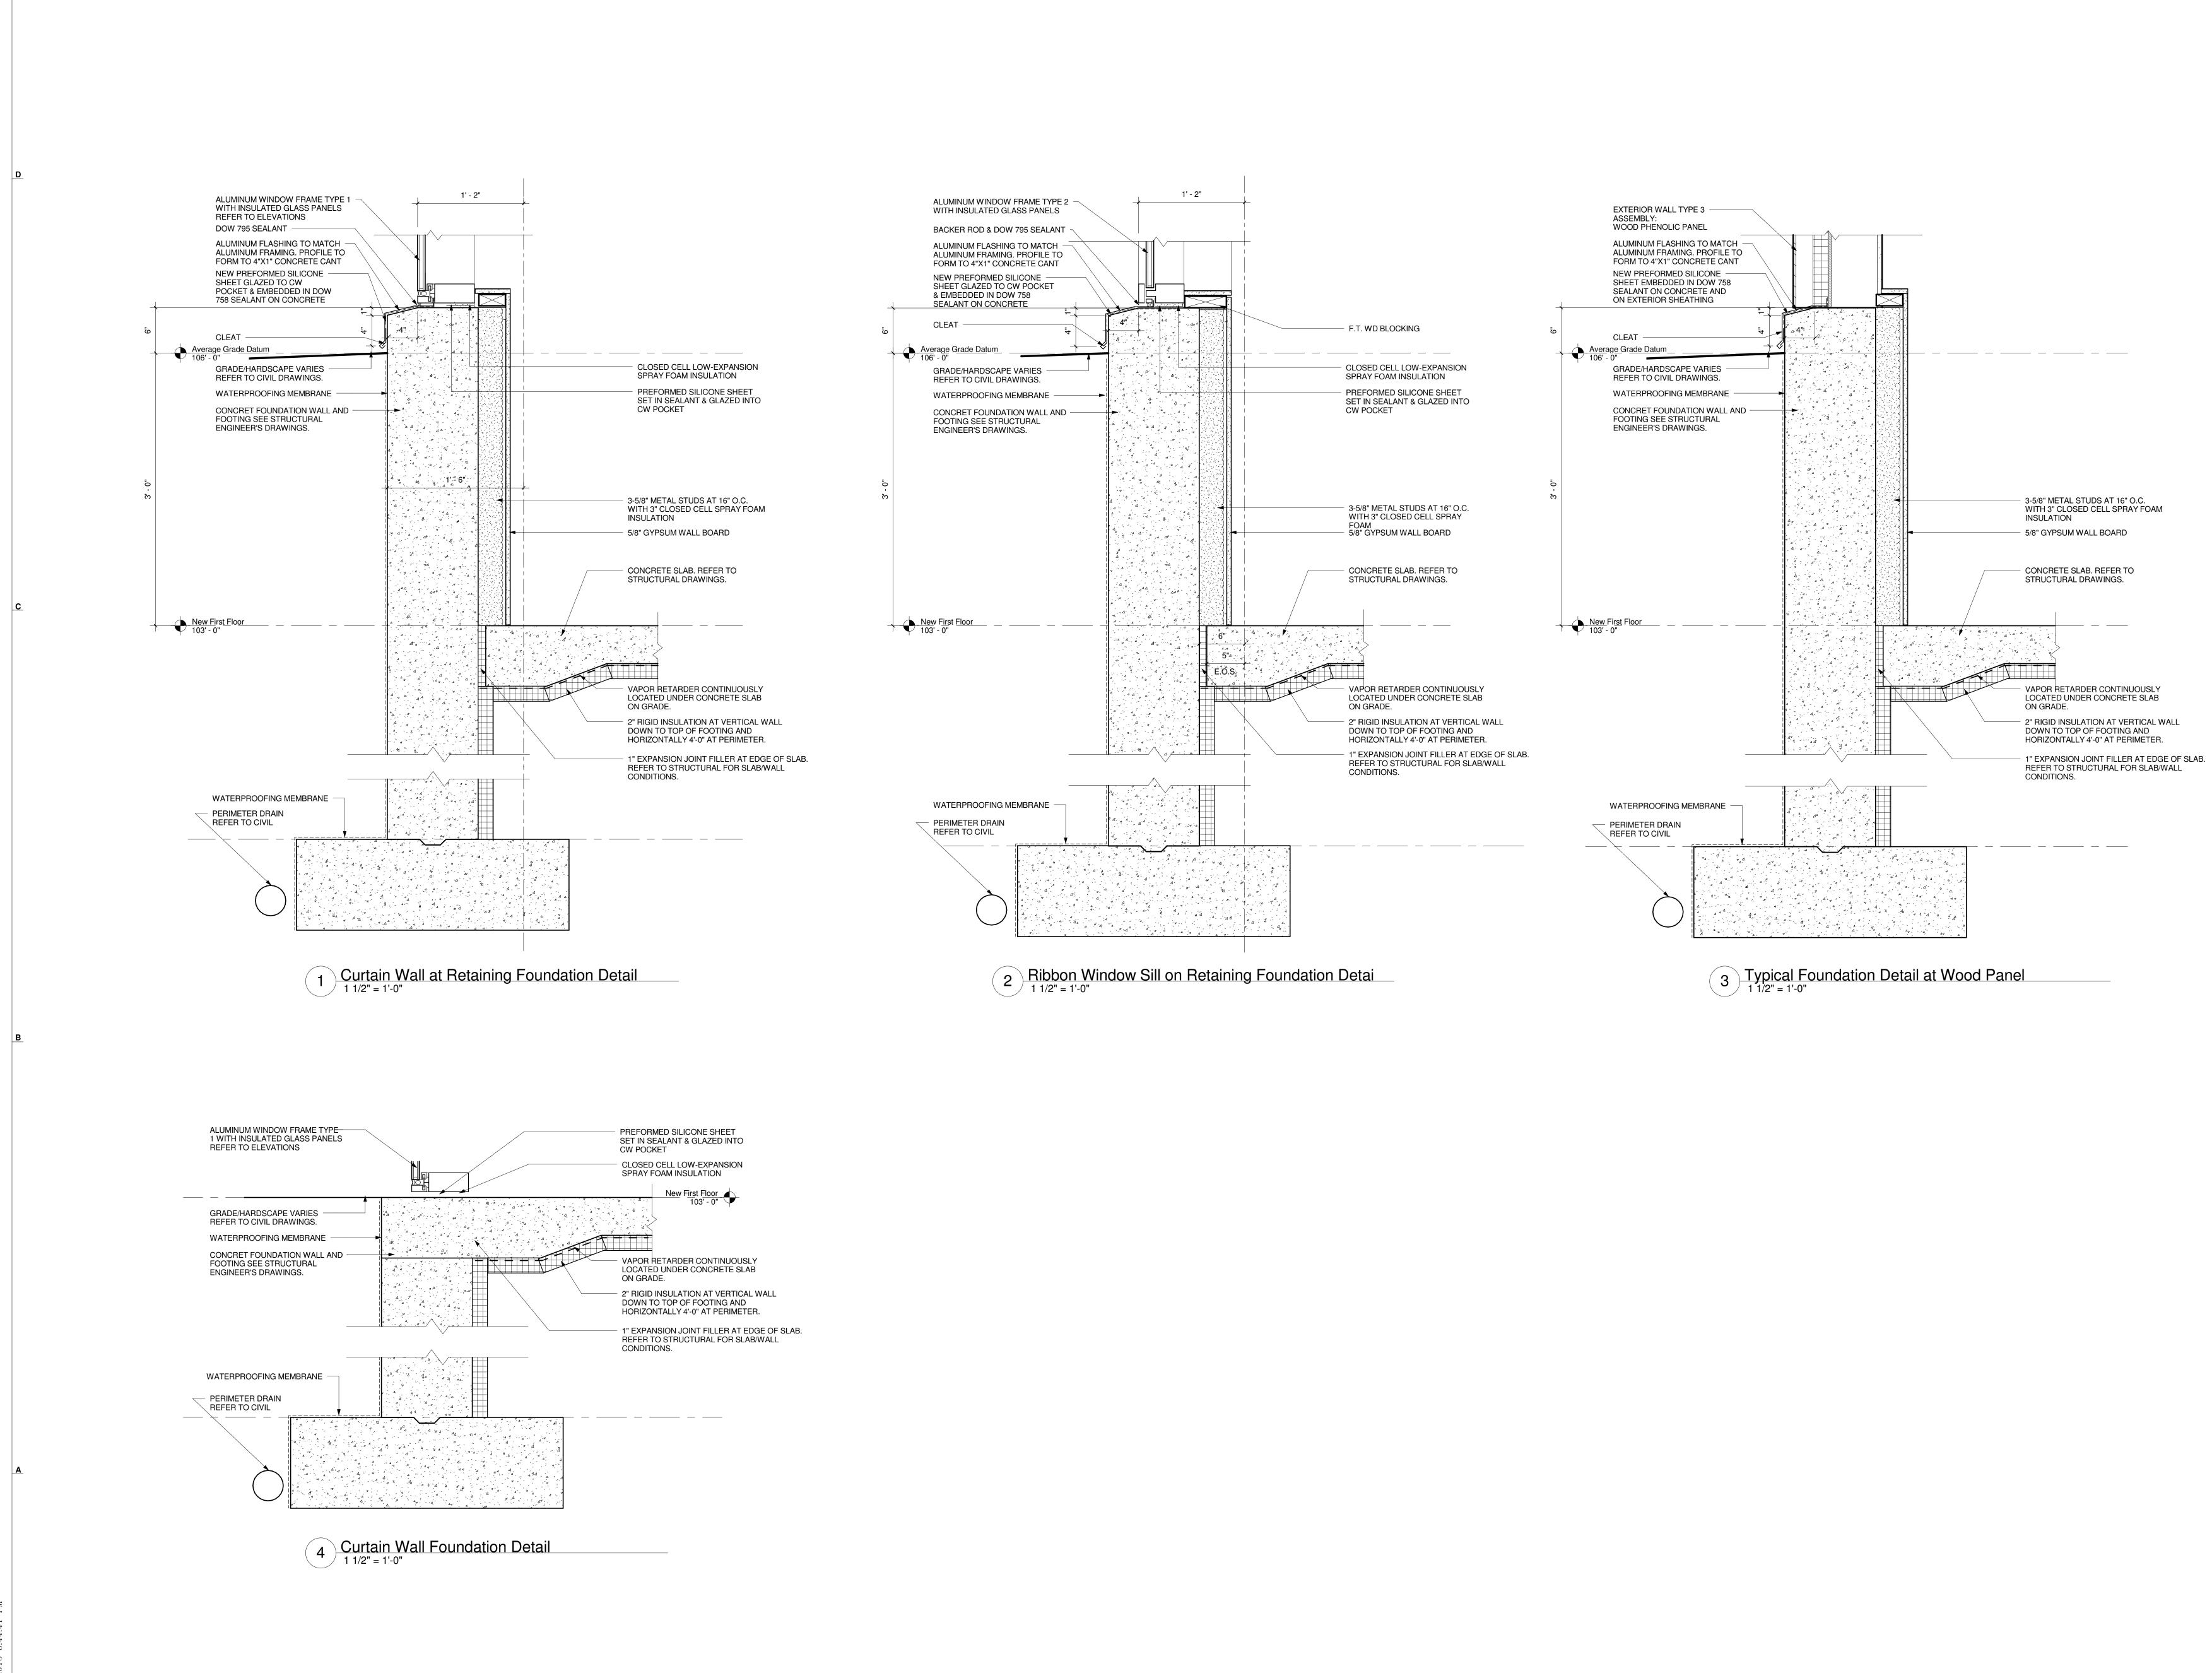

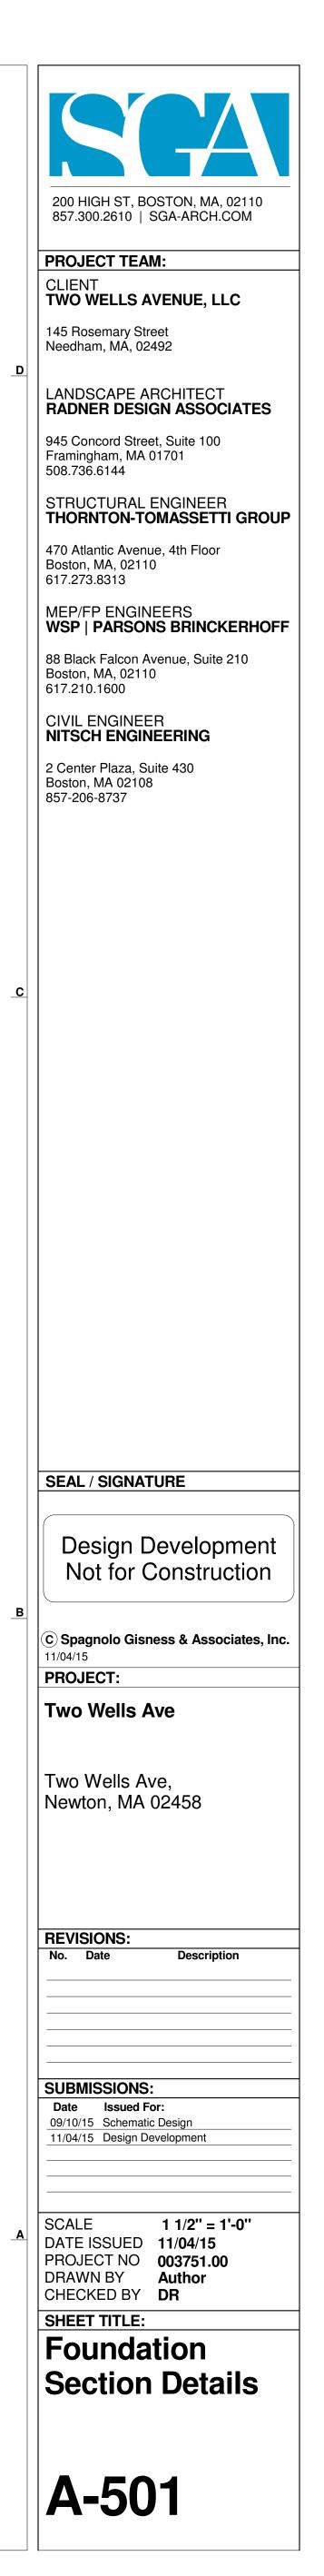


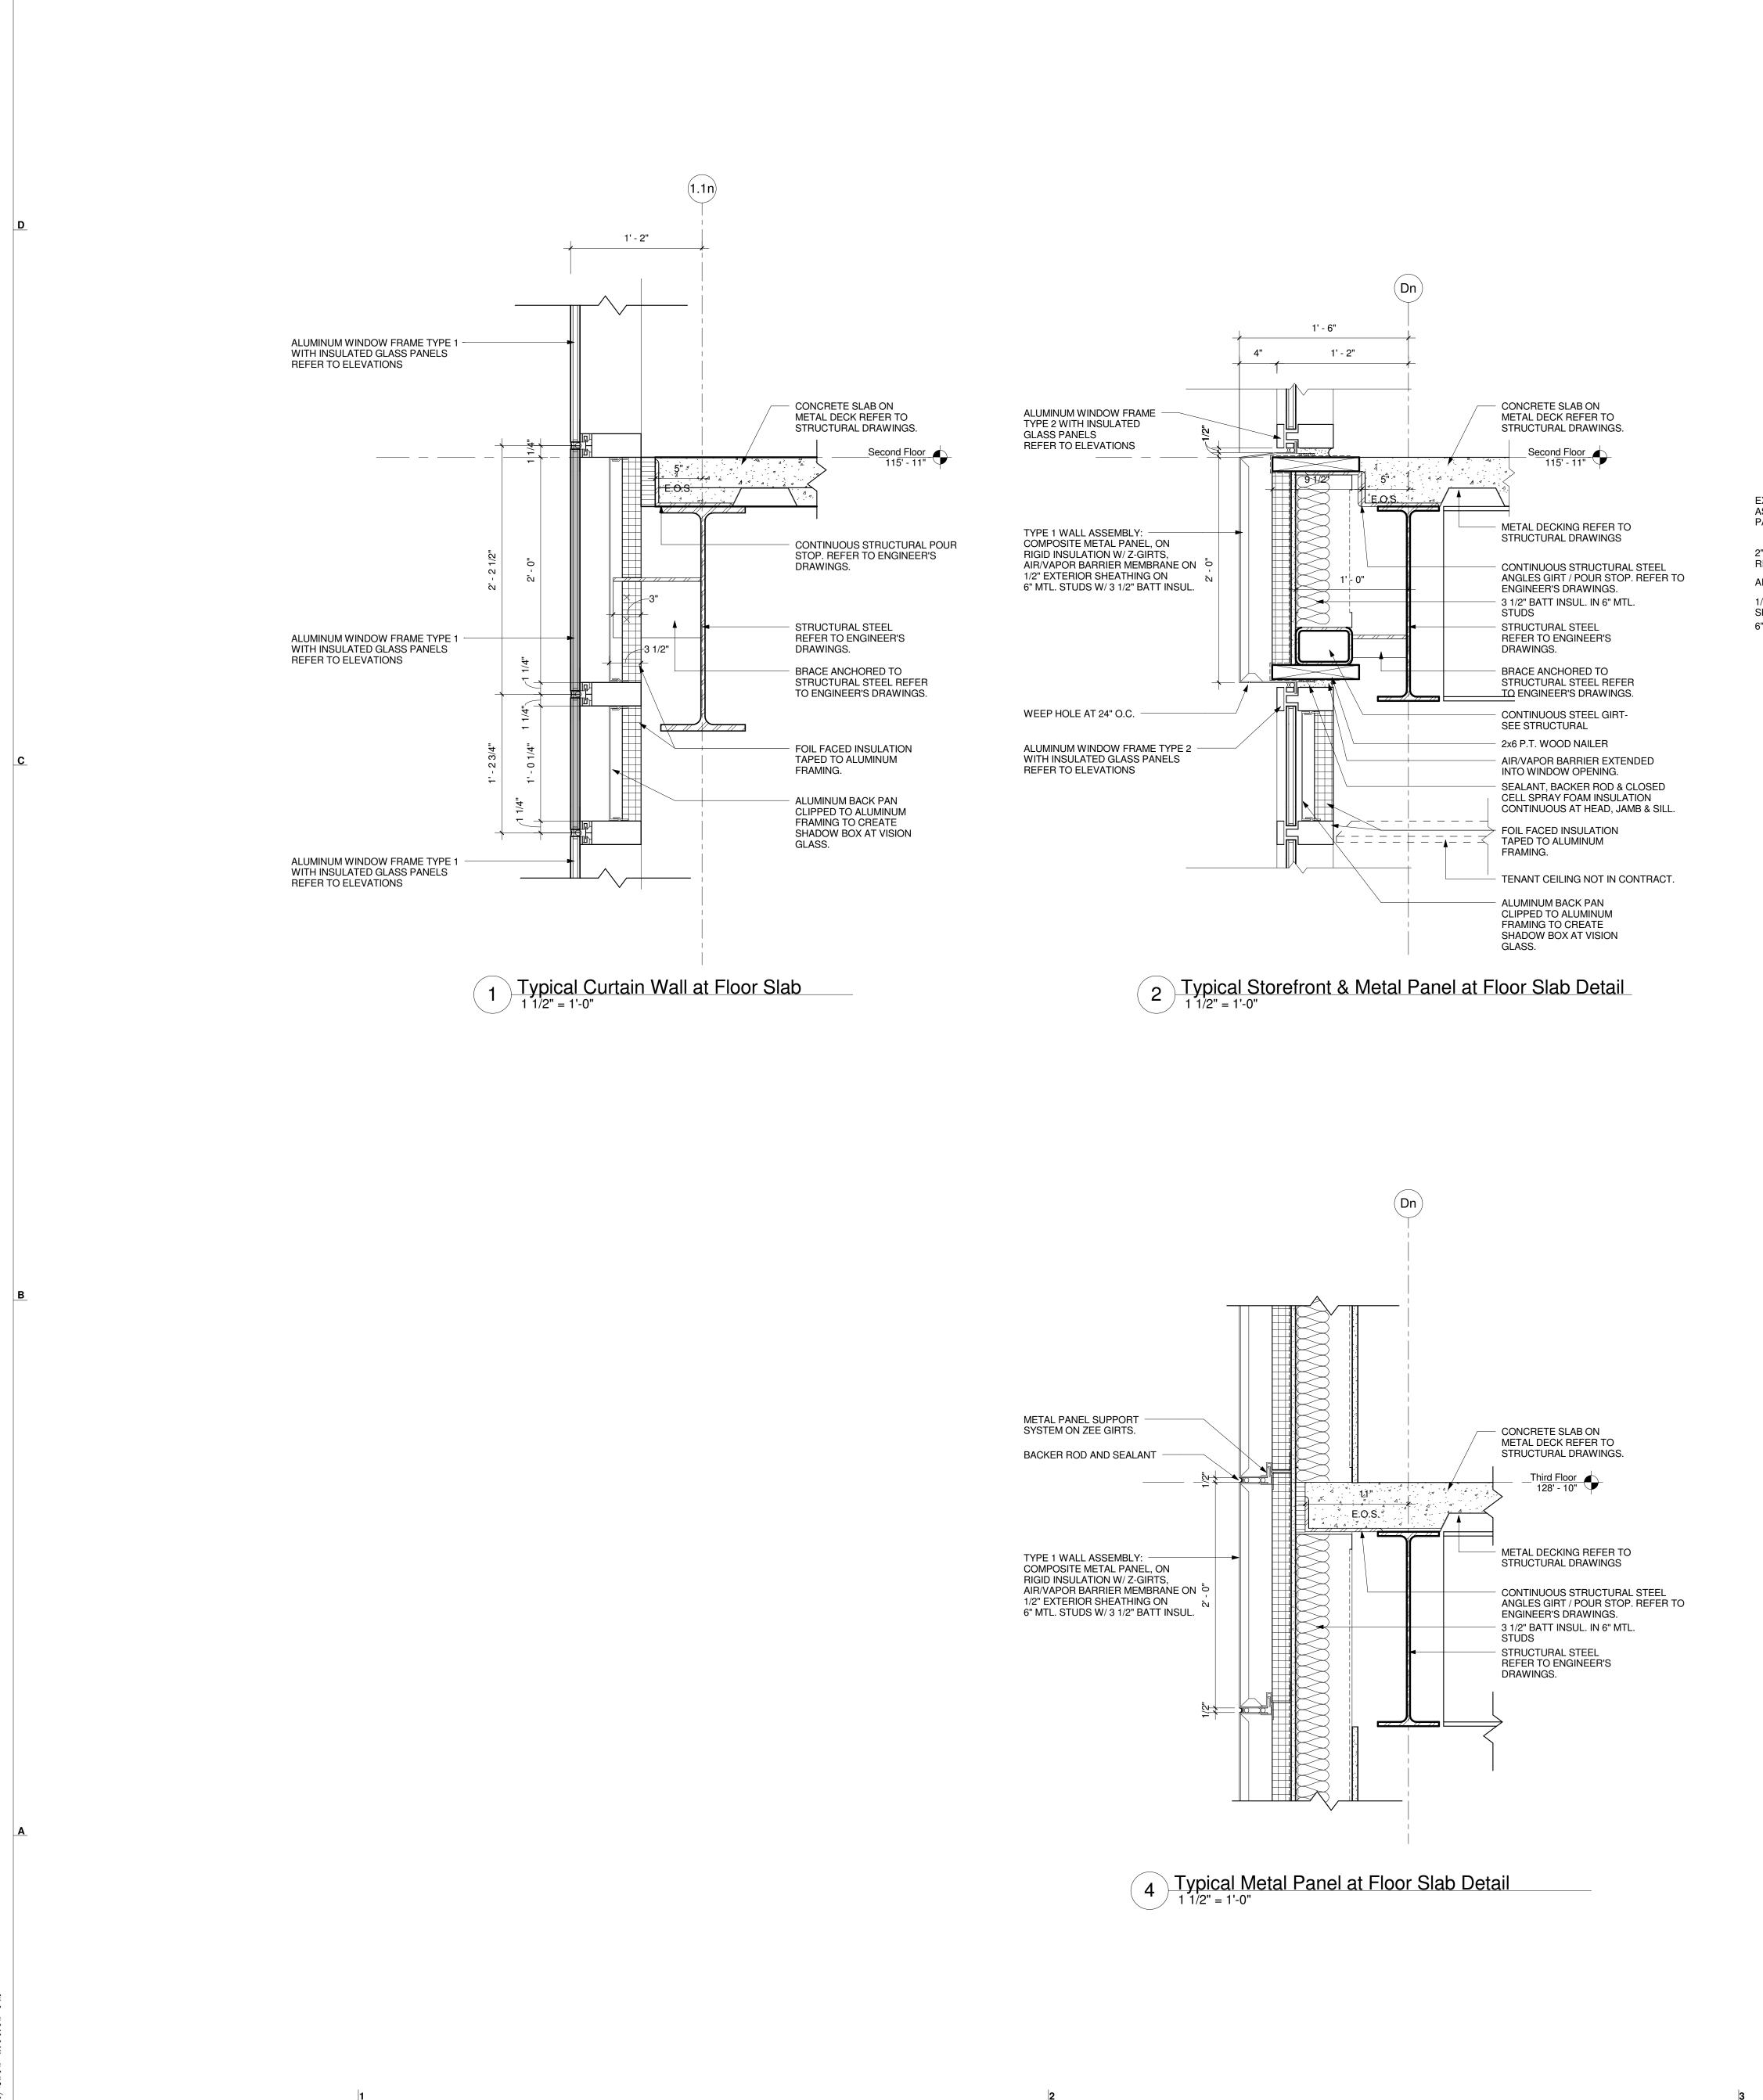



SHEATHING

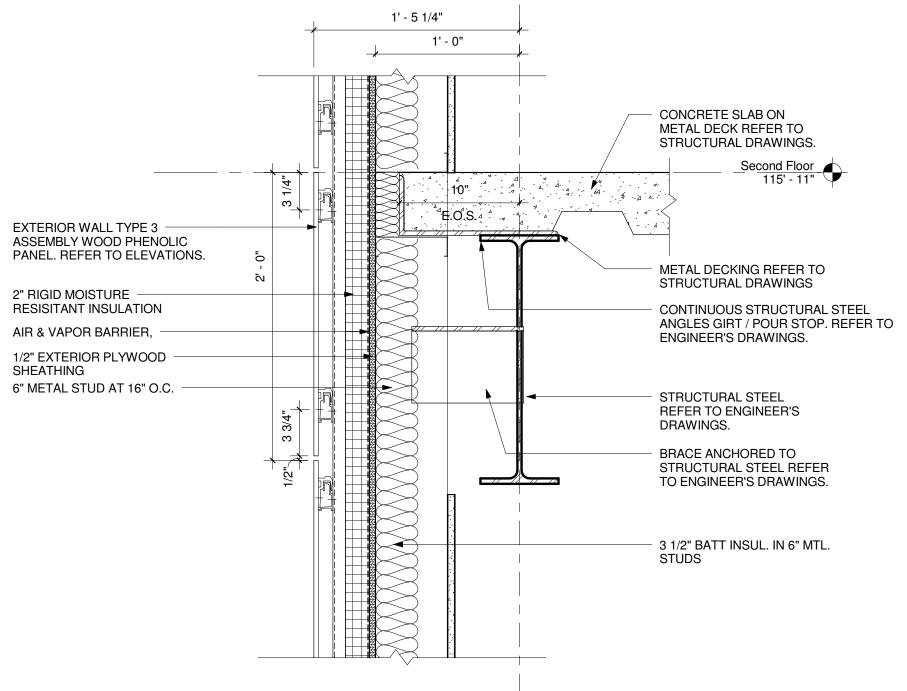


3 Typical Wood Panel at Floor Slab Detail

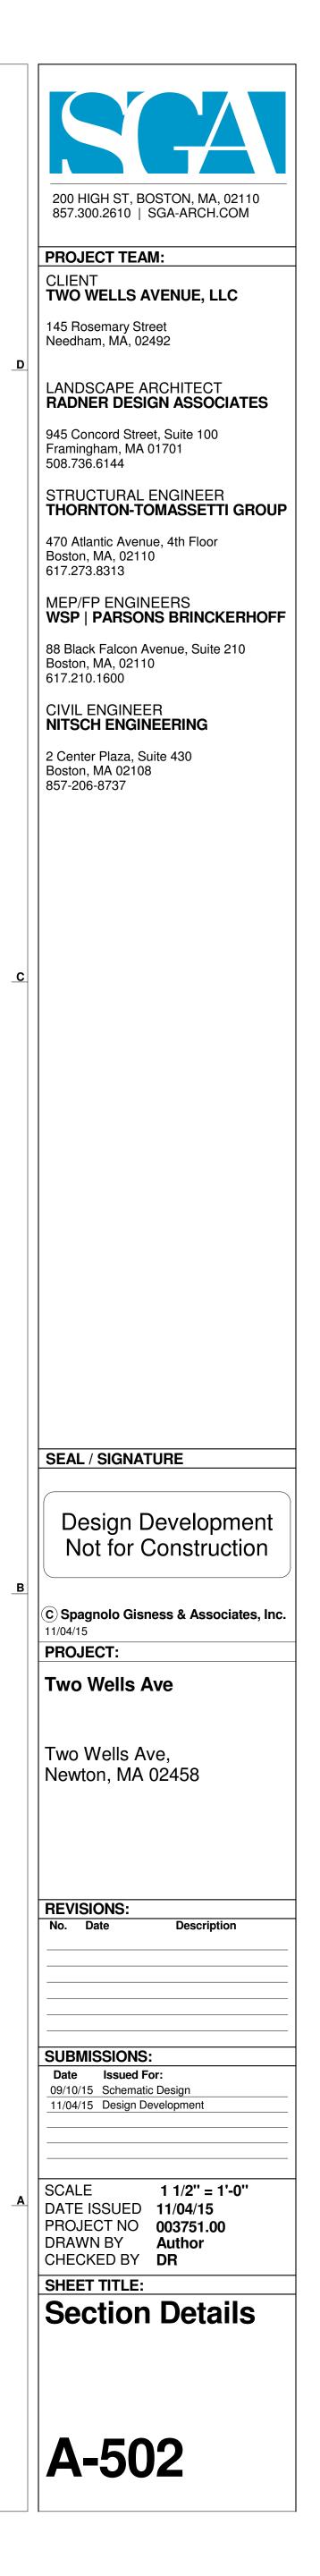

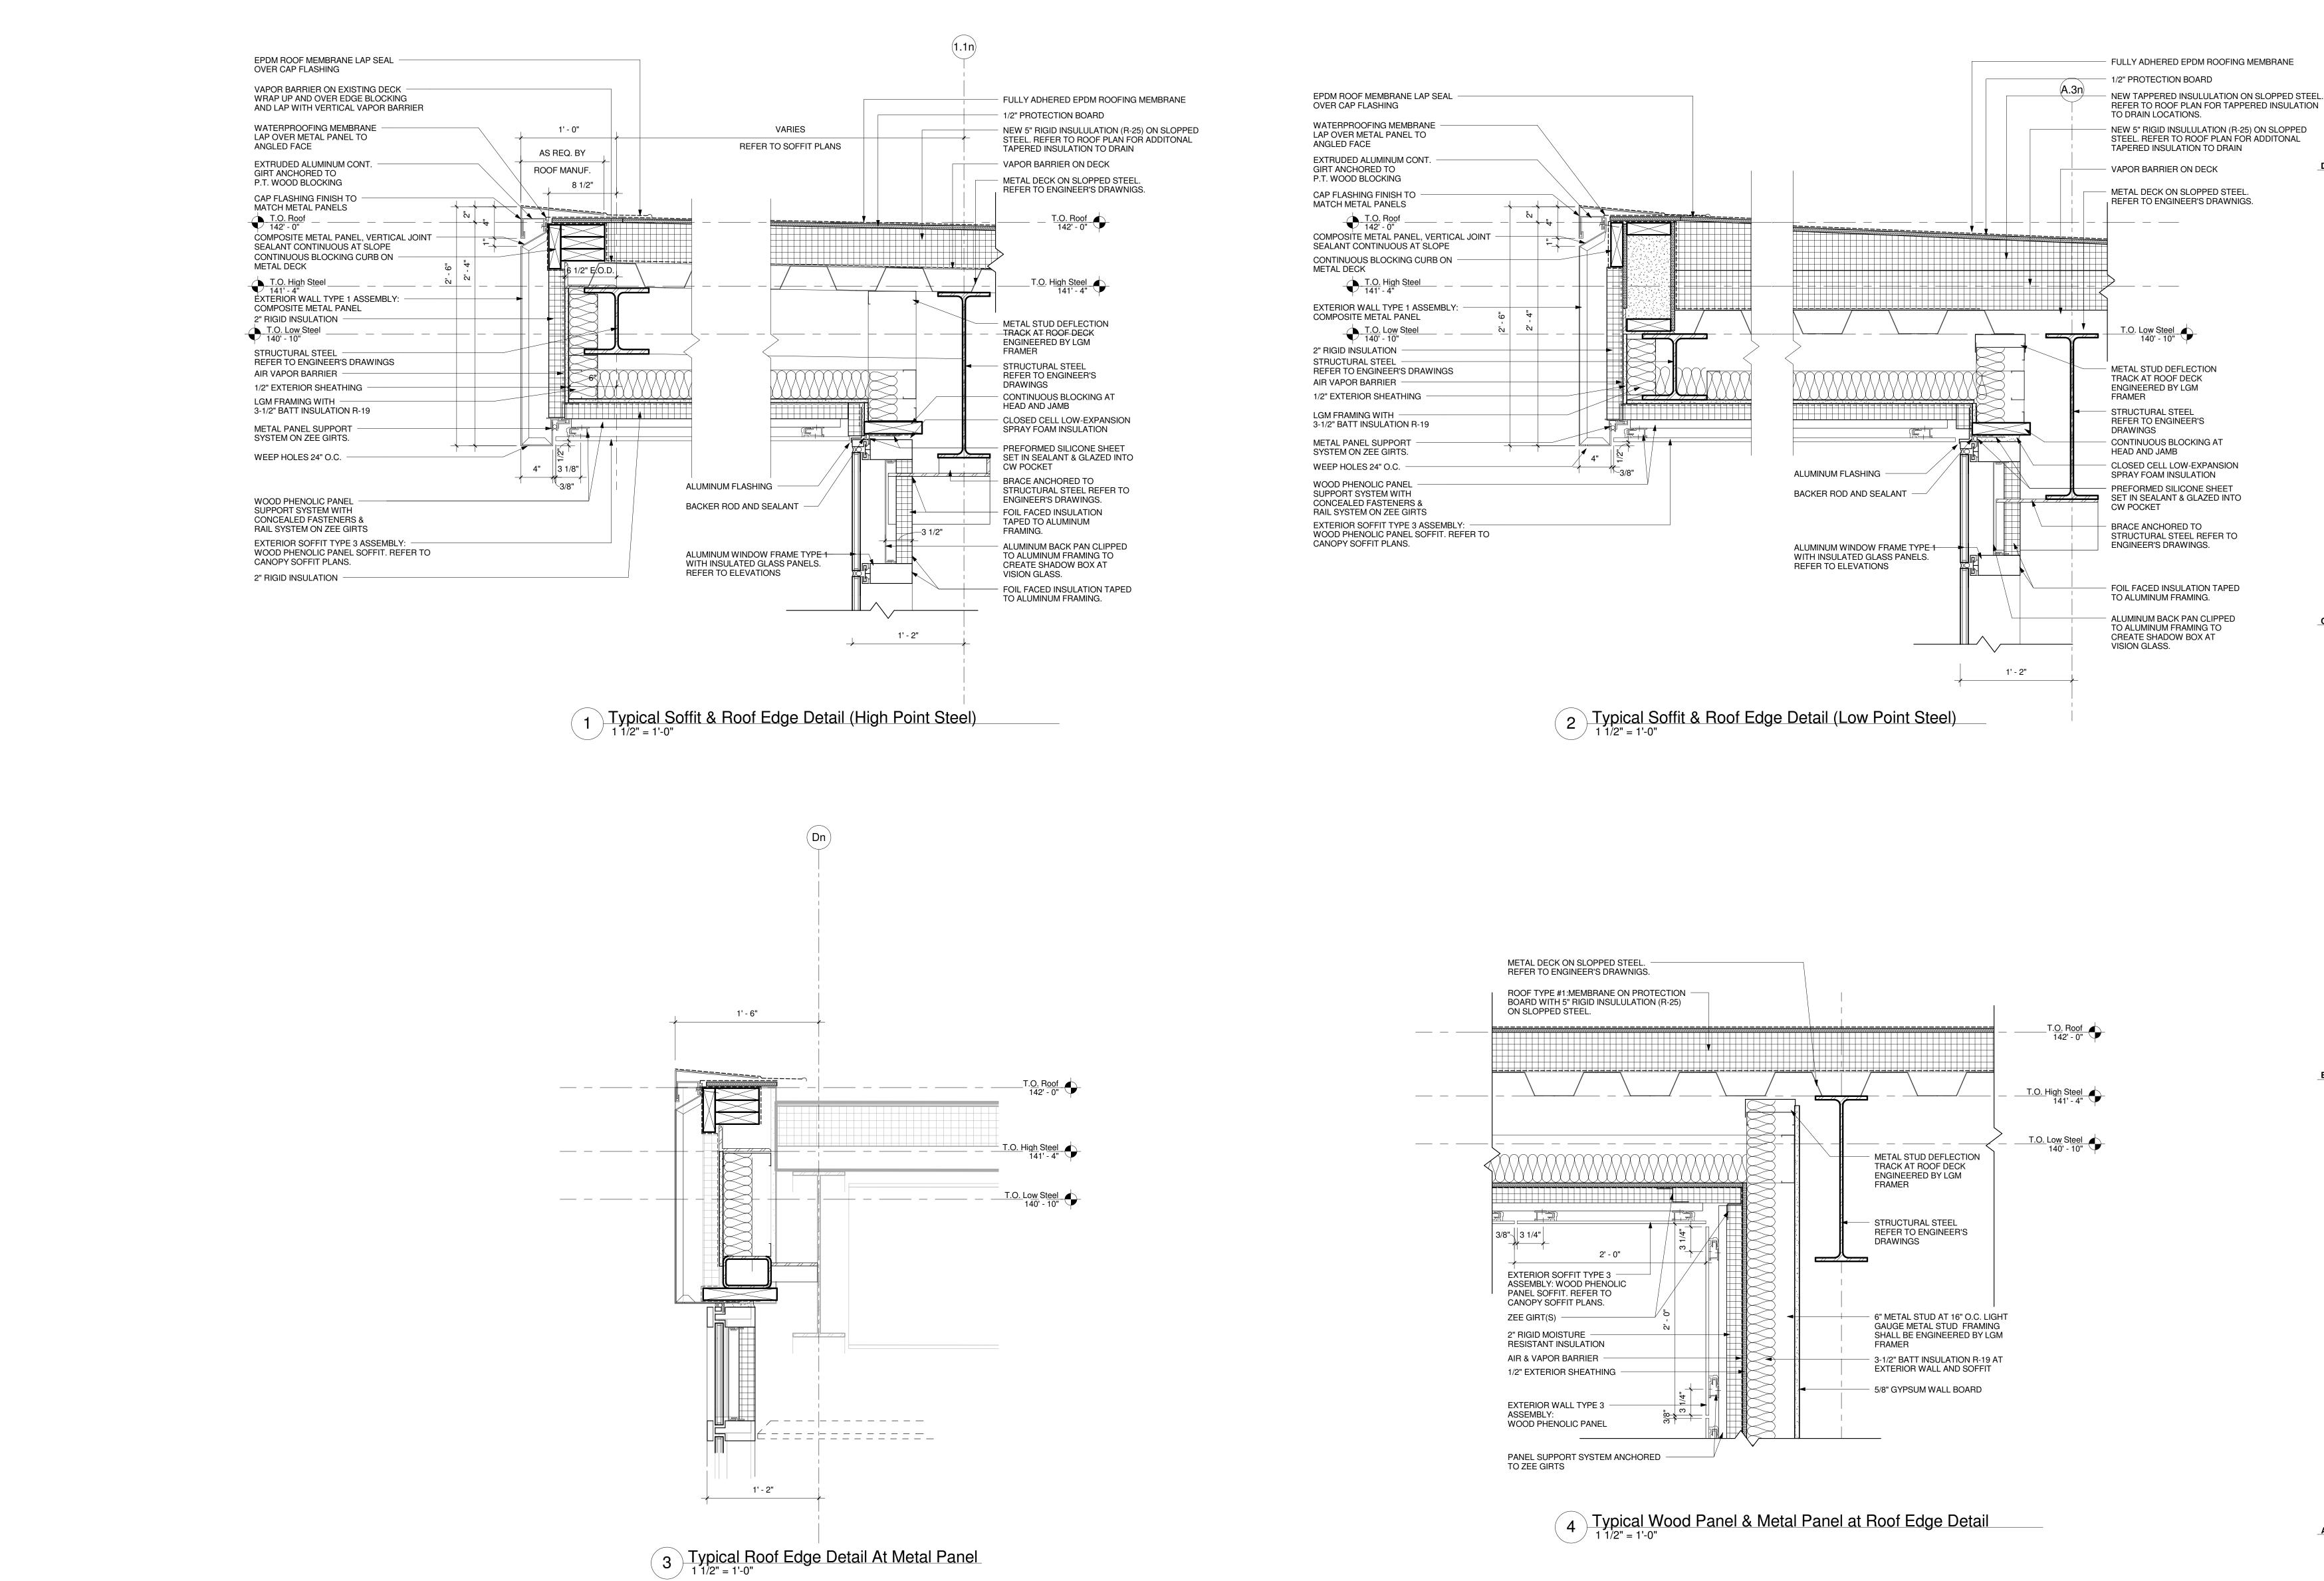

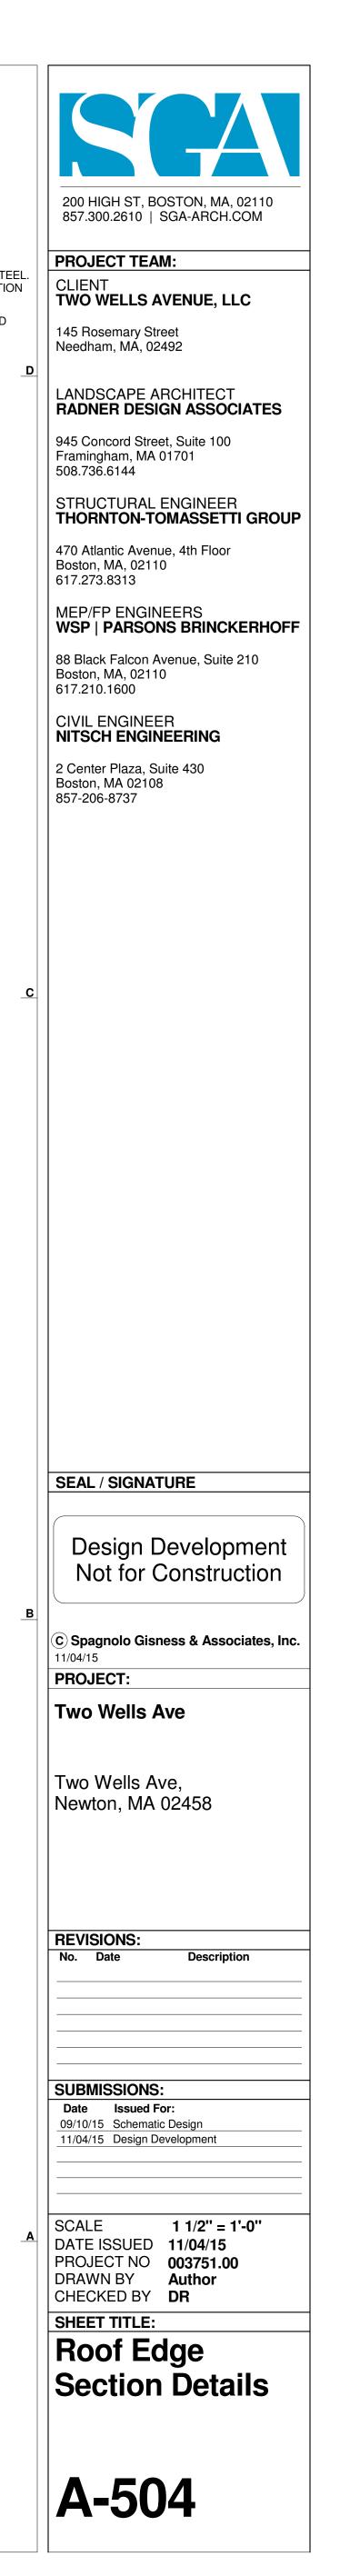

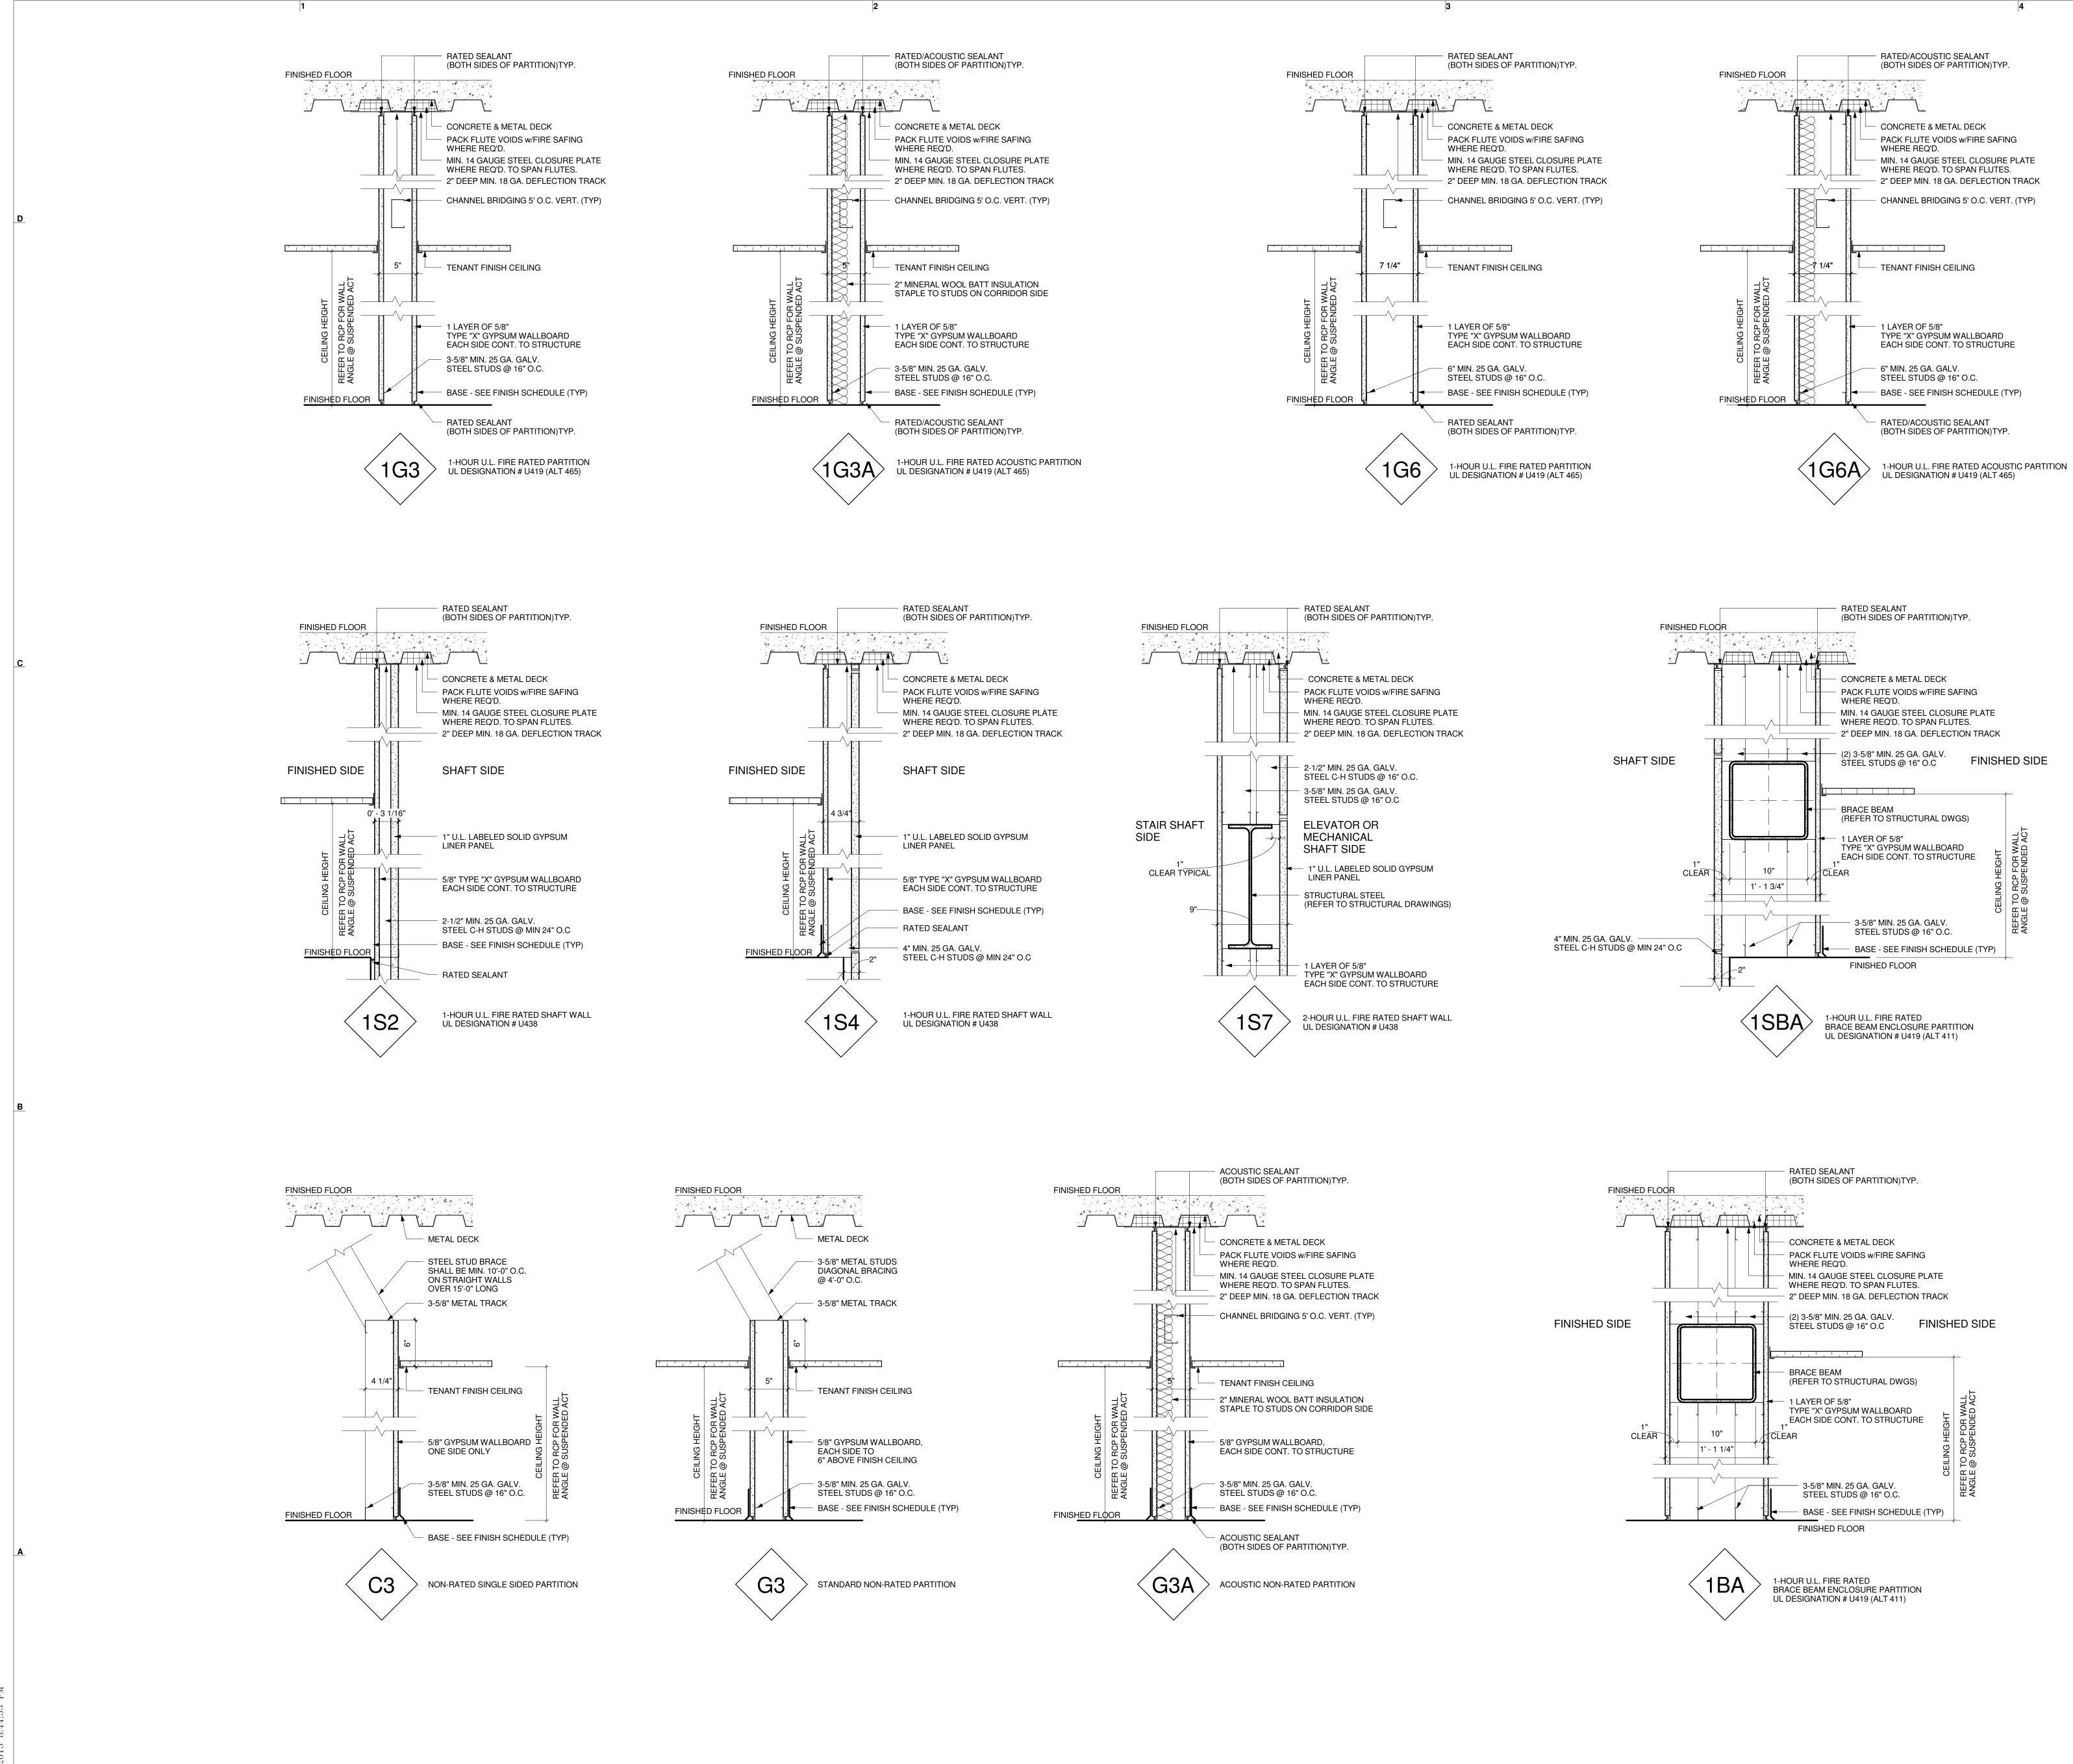

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